

**SITE PLAN KEYNOTES**

- 1 REPLACE (E) PARKING LOT ENTRANCE SIGN WITH (N) IN COMPLIANCE WITH THE CURRENT ACCESSIBILITY CODE REQUIREMENTS
- 2 (E) ACCESSIBLE PARKING SPACE IN COMPLIANCE WITH THE CURRENT ACCESSIBILITY CODE REQUIREMENTS
- 3 (E) VAN ACCESSIBLE PARKING SPACE IN COMPLIANCE WITH THE CURRENT ACCESSIBILITY CODE REQUIREMENTS
- 4 (E) ACCESSIBLE GIRLS RESTROOM (03-103017 CERTIFIED)
- 5 (E) ACCESSIBLE BOYS RESTROOM (03-103017 CERTIFIED)
- 6 (E) ACCESSIBLE STAFF RESTROOM (03-103017 CERTIFIED)
- 7 (E) H/LO DRINKING FOUNTAIN (03-103017 CERTIFIED)
- 8 (E) FIRE HYDRANT

**GENERAL NOTES**

- 1. PROTECT ALL EXISTING STRUCTURES, UTILITIES & LANDSCAPING DURING CONSTRUCTION.
- 2. PLANS WERE PREPARED USING AS-BUILT DRAWINGS RECEIVED FROM THE SCHOOL DISTRICT. THE CONTRACTOR SHALL FIELD VERIFY EXISTING ACTUAL CONDITIONS PRIOR TO START OF WORK AND NOTIFY THE ARCHITECT OF ANY DISCREPANCIES.
- 3. CAMPUS-WIDE MODERNIZATION UNDER A-03-103017 (CERTIFIED).

**PATH OF TRAVEL**

----- "ACCESSIBLE" PATH OF TRAVEL (P.O.T.) PER 03-103017 (CERTIFIED)

PATH OF TRAVEL (P.O.T.) AS INDICATED IS A BARRIER FREE ACCESS IS AT LEAST 48" WIDE WITHOUT ANY ABRUPT VERTICAL CHANGES EXCEEDING 1/2" BEVELLED AT 1:2 MAX. SLOPE. EXCEPT THAT LEVEL CHANGES DO NOT EXCEED 1/4" PER FOOT. CROSS SLOPE DOES NOT EXCEED 2% AND SLOPE IN THE DIRECTION OF TRAVEL IS LESS THAN 5% UNLESS OTHERWISE NOTED. P.O.T. SHALL BE MAINTAINED FREE OF OVERHANGING OBSTRUCTIONS TO 8" MINIMUM AND PROTRUDING OBJECTS GREATER THAN 4" PROJECTION FROM WALL AND ABOVE 27" AND LESS THAN 87". ARCHITECT TO VERIFY THAT ALL BARRIERS IN THE PATH OF TRAVEL HAVE BEEN REMOVED OR WILL BE REMOVED UNDER THIS PROJECT.

PATH OF TRAVEL (P.O.T.) AS VERIFIED BY ARCHITECT IS:

- A COMMON BARRIER FREE ACCESSIBLE ROUTE AT LEAST 48" WIDE WITHOUT ANY ABRUPT VERTICAL CHANGES EXCEEDING 1/2" BEVELLED AT 1:2 MAXIMUM SLOPE. EXCEPT THAT LEVEL CHANGES DO NOT EXCEED 1/4" PER FOOT.
- THE PATH SURFACE IS SLIP RESISTANT, STABLE, FIRM AND SMOOTH.
- PARKING SPACES AT LEAST 60" X 60" ARE LOCATED NOT MORE THAN 200' APART.
- CONTINUOUS GRADIENTS HAVE 60' LEVEL AREAS NOT MORE THAN 40' APART.
- CROSS-SLOPE DOES NOT EXCEED 2%.
- SLOPE IN THE DIRECTION OF TRAVEL IS LESS THAN 5% UNLESS OTHERWISE INDICATED AS A RAMP.
- MAINTAIN, NOT FREE OF OVERHANGING OBSTRUCTIONS TO 8" MINIMUM. PROTRUDING OBJECTS GREATER THAN 4" PROJECTION FROM WALL OR EDGE AND 27" ABOVE FINISH GRADE.

FOR GRATINGS LOCATED IN THE SURFACE OF ANY PEDESTRIAN WAYS AT PATH OF TRAVEL, GRID OPENINGS IN GRATINGS SHALL BE LIMITED TO 1/2" MAX. IN THE DIRECTION OF TRAFFIC FLOW. IF SUCH CONDITION OCCURS, PROVIDE MANUFACTURER CUTSHEETS OF GRATE PROVIDED.

GATES SERVING THE MEANS OF EGRESS SYSTEM SHALL COMPLY WITH THE REQUIREMENTS OF SECTION 1008. GATES USED AS A COMPONENT IN A MEANS OF EGRESS SHALL CONFORM TO THE APPLICABLE REQUIREMENTS FOR DOORS. PROVIDE LEVER HARDWARE AND INSTALL FIRE AND LIFE SAFETY MARKING PER MANUFACTURER HARDWARE FOR EMERGENCY EXITING EVEN WITH THE SIGN COORDINATE WITH FIRE AND LIFE SAFETY REQUIREMENTS.

DESIGN PROFESSIONAL IN GENERAL RESPONSIBLE CHANGE STATEMENT: THE P.O.T. IDENTIFIED IN THESE CONSTRUCTION DOCUMENTS IS COMPLIANT WITH THE CURRENT APPLICABLE CALIFORNIA BUILDING CODE ACCESSIBILITY PROVISIONS FOR PATH OF TRAVEL REQUIREMENTS FOR ALTERATIONS, ADDITIONS AND STRUCTURAL REPAIRS AS PART OF THE DESIGN OF THIS PROJECT. THE P.O.T. WAS EXAMINED AND ANY ELEMENTS, COMPONENTS OR PORTIONS OF THE P.O.T. THAT WERE DETERMINED TO BE NON COMPLIANT:

1. HAVE BEEN IDENTIFIED
2. THE CORRECTIVE WORK NECESSARY TO BRING THEM INTO COMPLIANCE HAS BEEN INCLUDED WITHIN THE SCOPE OF THIS PROJECTS WORK THROUGH DETAIL DRAWINGS AND SPECIFICATIONS INCORPORATED INTO THESE CONSTRUCTION DOCUMENTS.

DURING CONSTRUCTION, IF P.O.T. ITEMS WITHIN THE SCOPE OF THE PROJECT REPRESENTED AS CODE COMPLIANT ARE FOUND TO BE NON CONFORMING BEYOND REASONABLE CONSTRUCTION TOLERANCES, THEY SHALL BE BROUGHT INTO COMPLIANCE WITH THE CBC AS PART OF THIS PROJECT BY MEANS OF A CONSTRUCTION CHANGE DOCUMENT.

OXNARD UNION HIGH SCHOOL DISTRICT  
 HUENEME HIGH SCHOOL  
 500 W. BARD RD. OXNARD, CA 93021  
**SITE SECURITY IMPROVEMENTS**




**KRUGER BENSEN ZIEMER ARCHITECTS, INC. AIA**  
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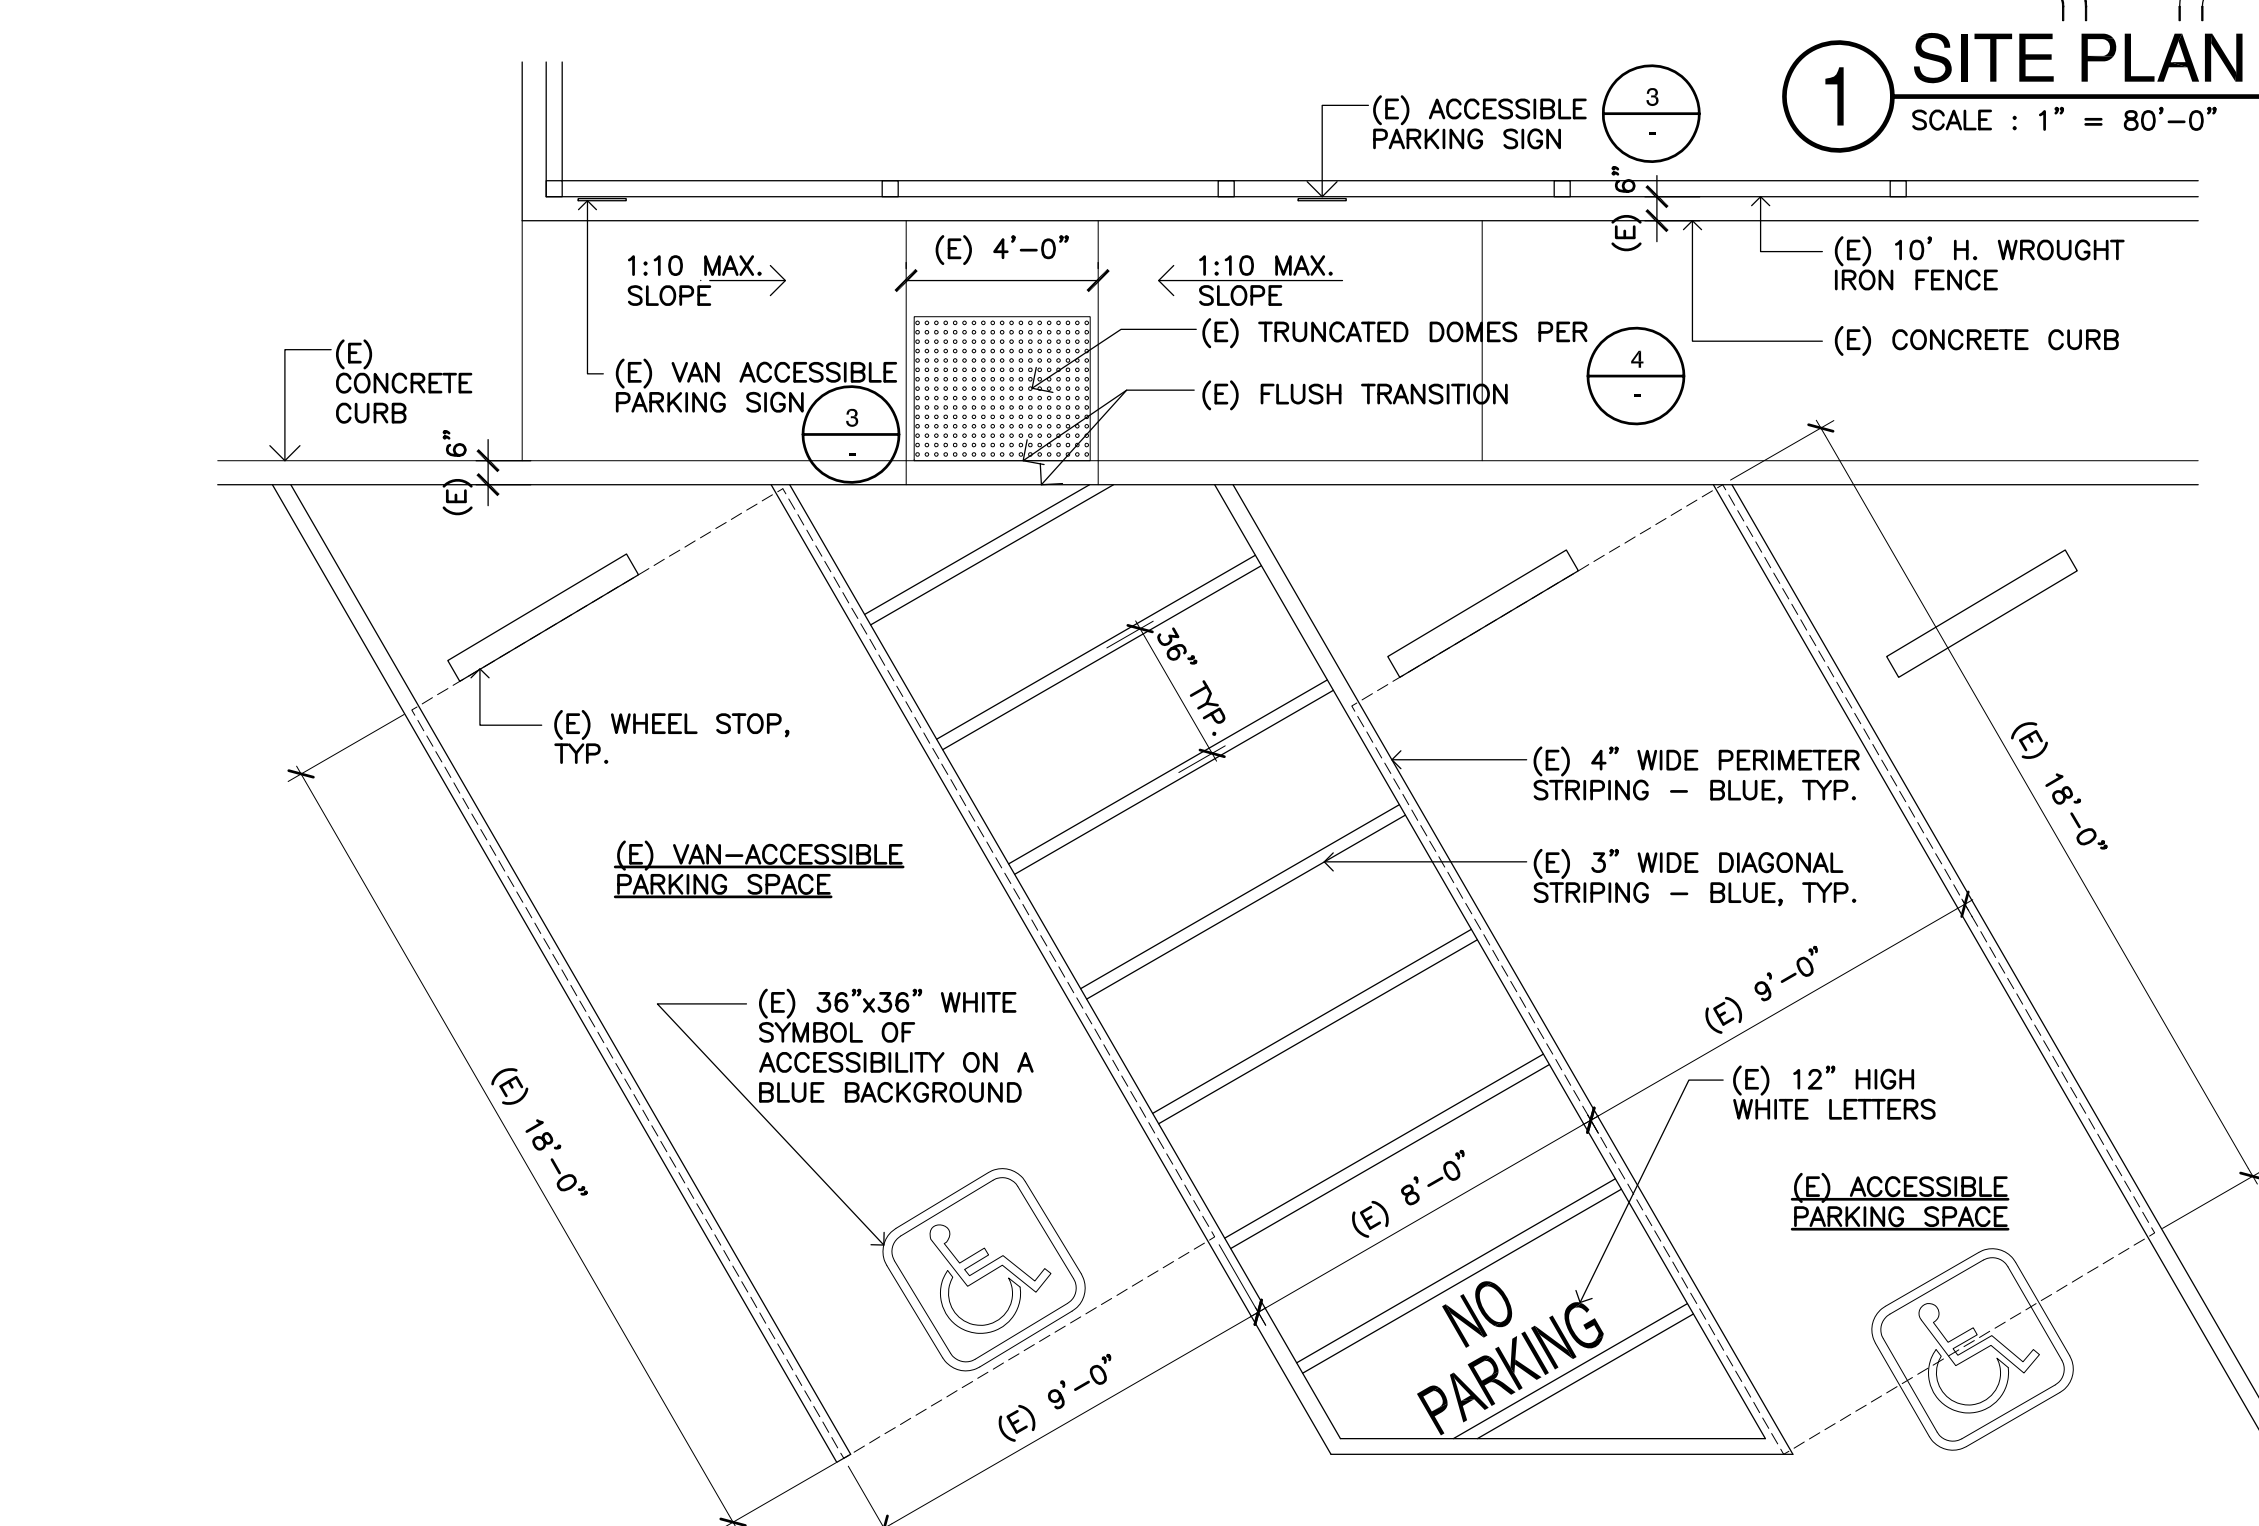
**TODD A. JESPERSSEN, AIA**  
 PRINCIPAL/ARCHITECT

**JONATHAN D. LEE**  
 ARCHITECTURAL ASSISTANT


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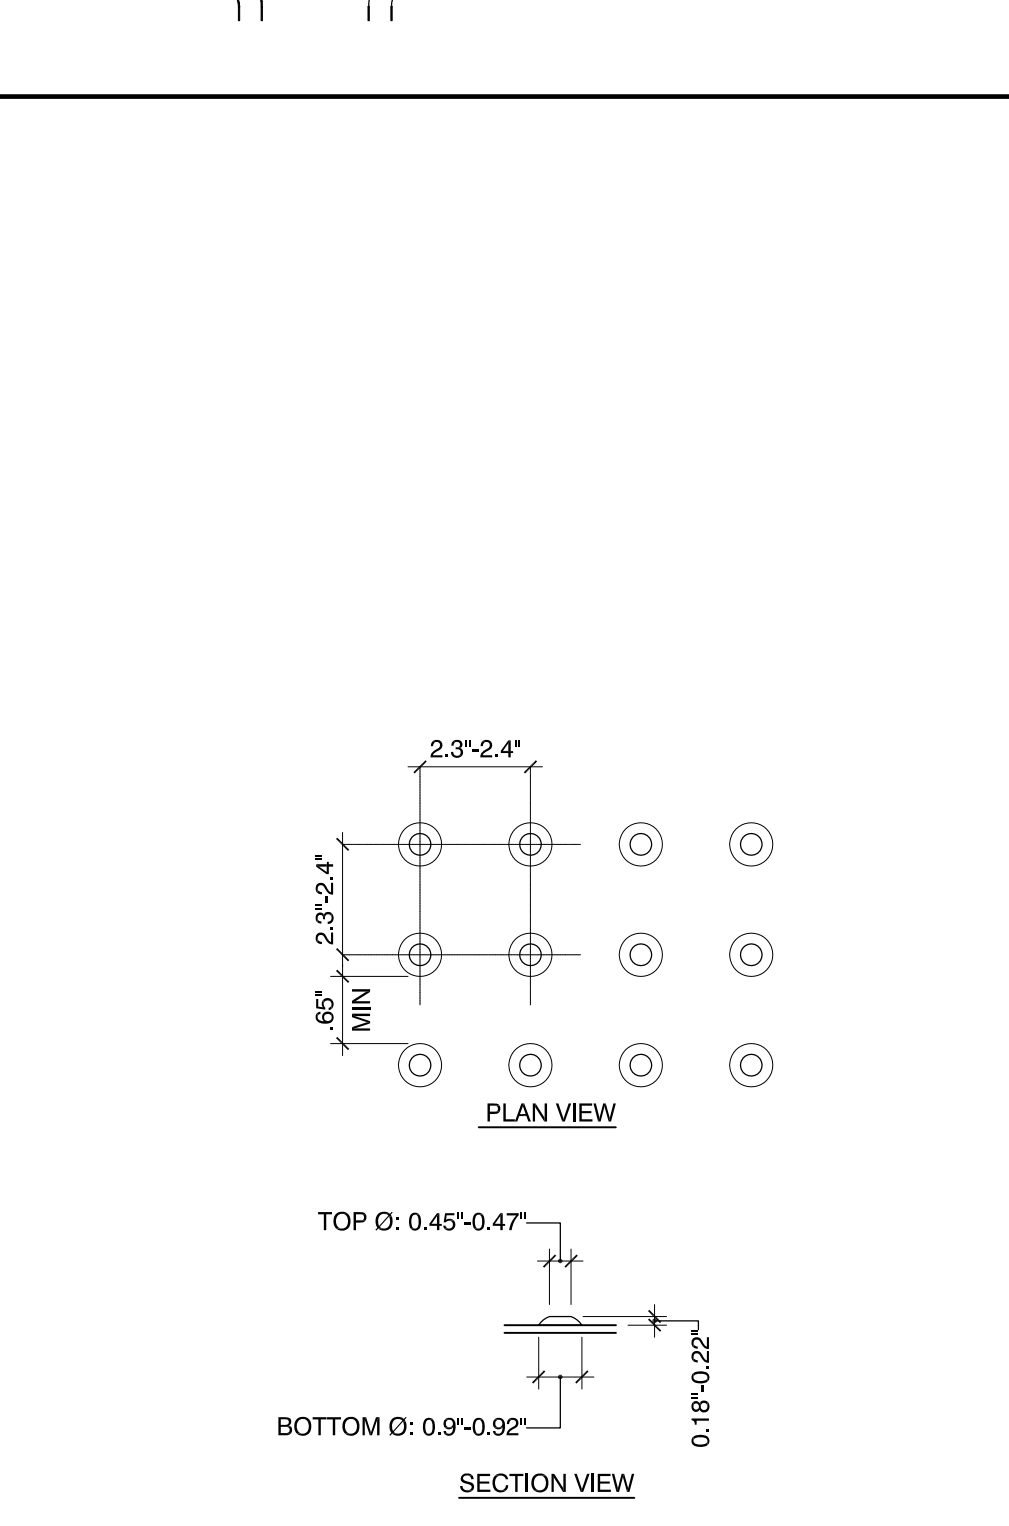
ARCHITECTS  
 STAMP & SIGNATURE

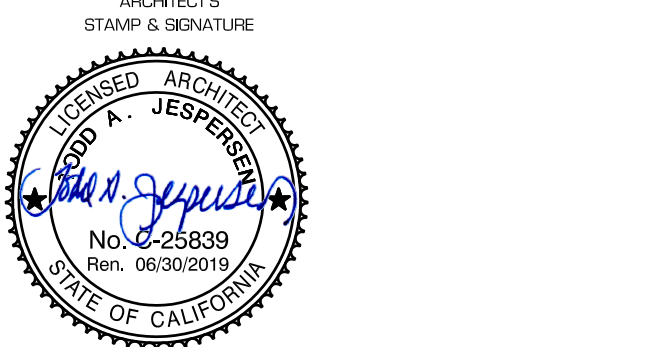


**2 Existing Accessible Parking Spaces**  
 SCALE: 1/4" = 1'-0"



**3 (E) Accessible Parking Signage**  
 SCALE: 1-1/2" = 1'-0"

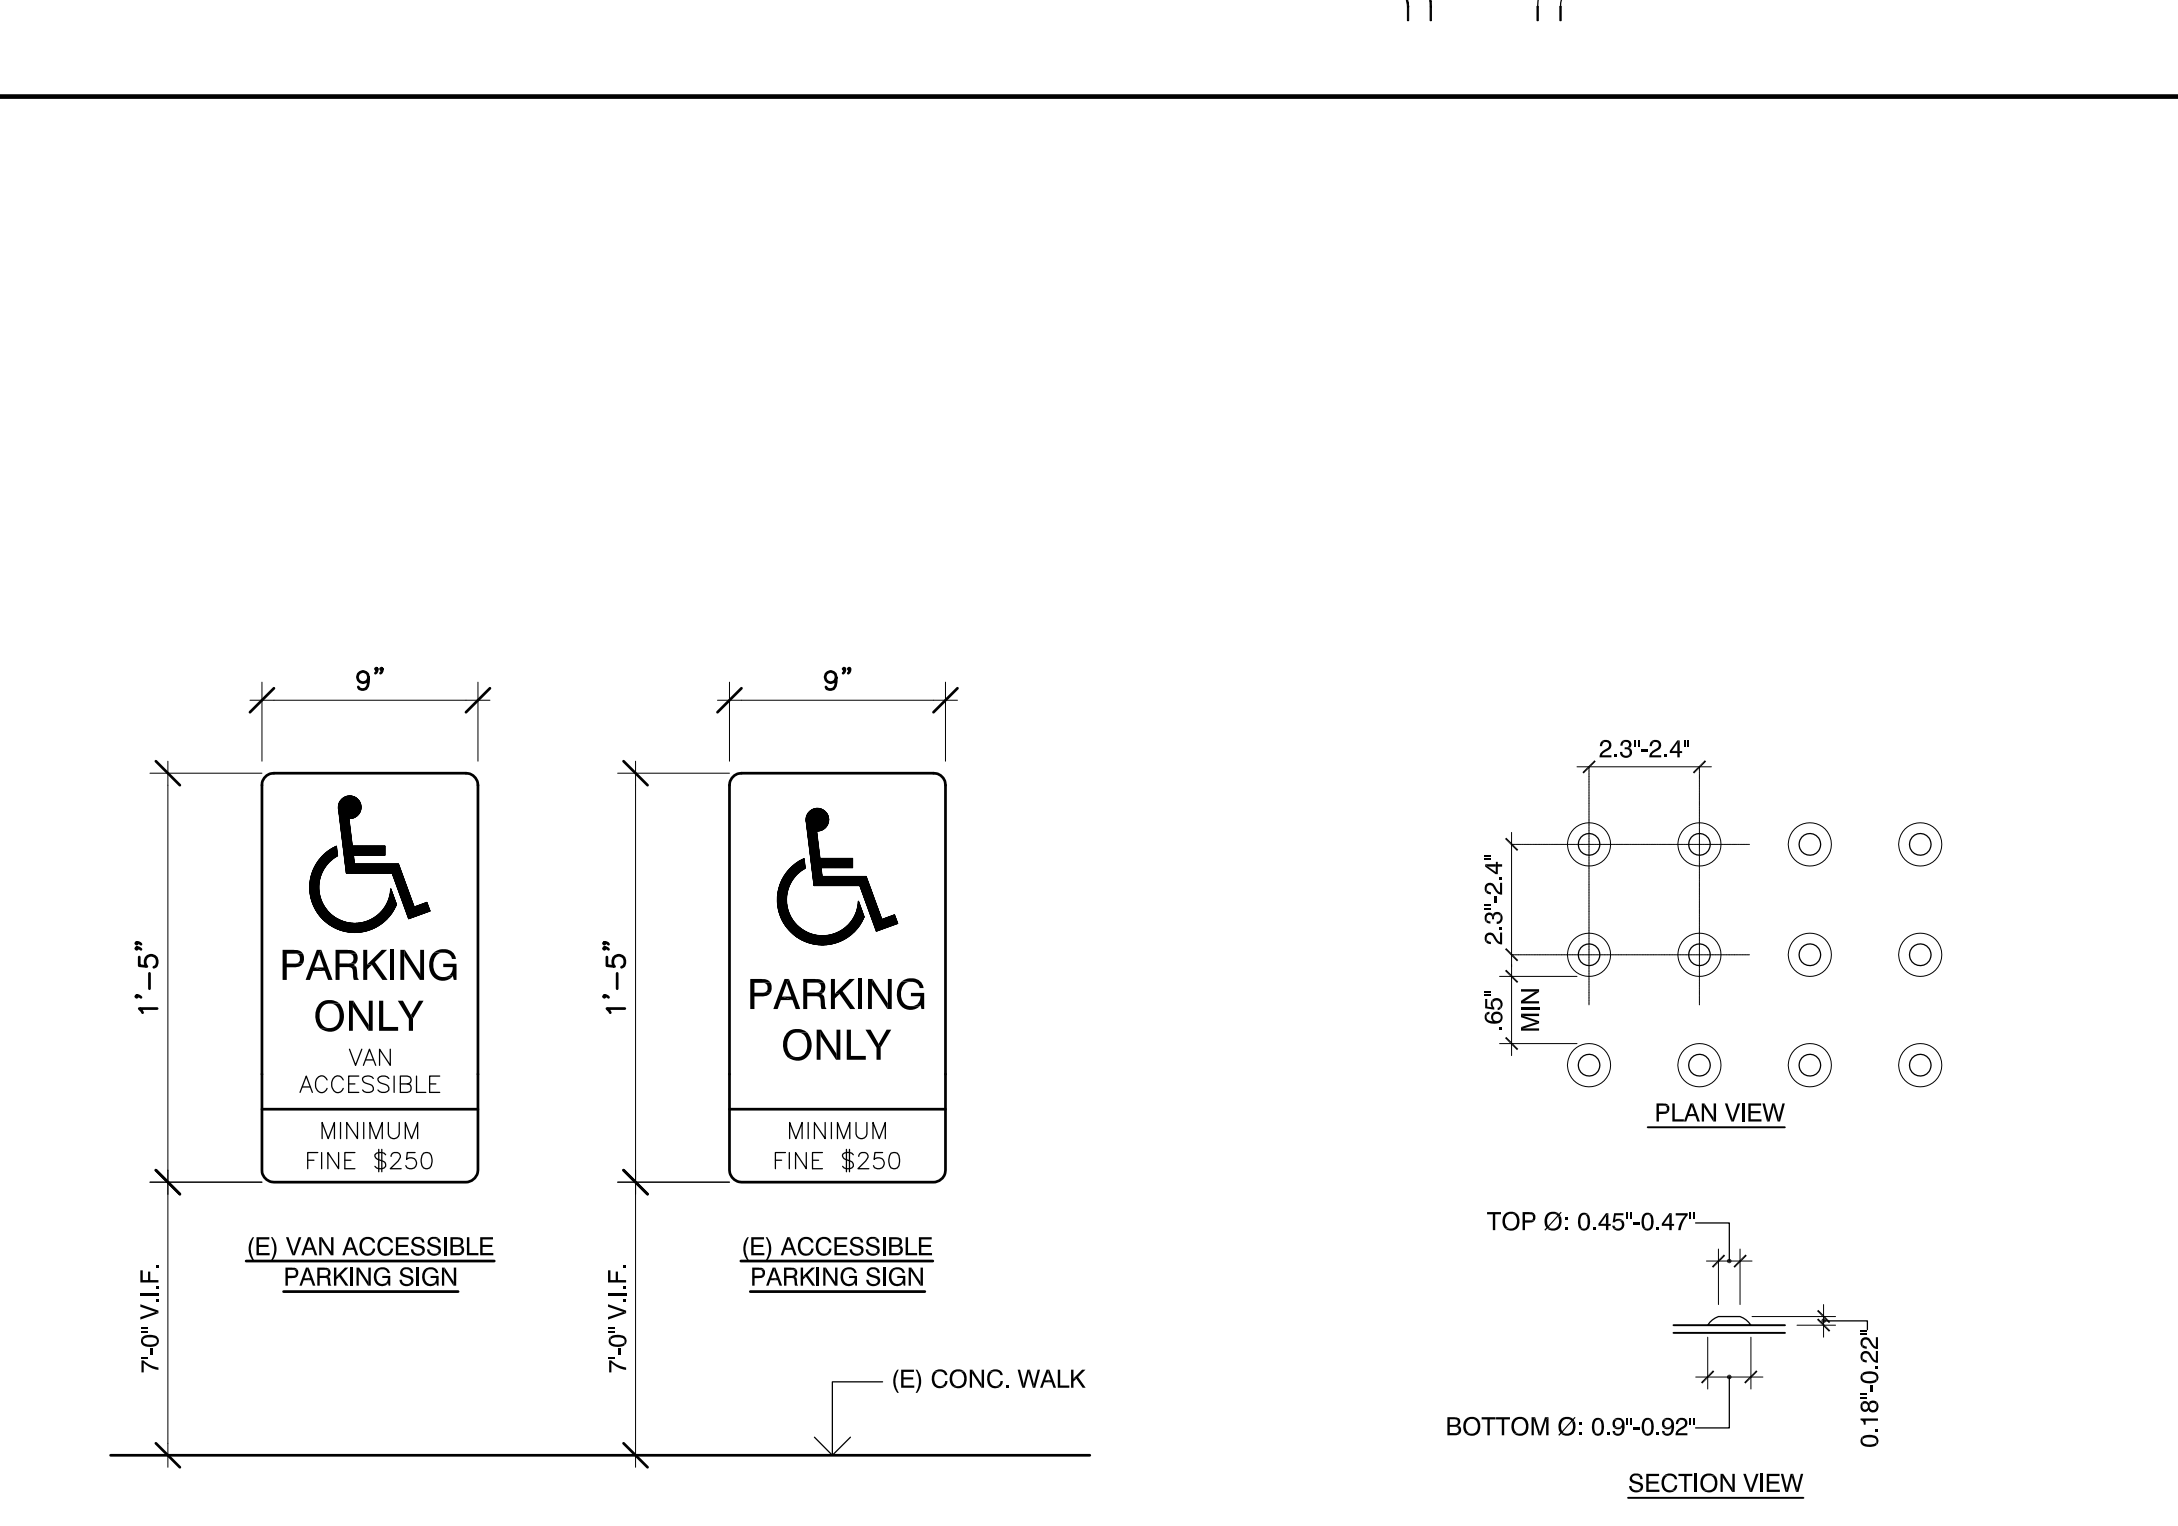

**4 Existing Truncated Domes**  
 SCALE: 3/4" = 1'-0"

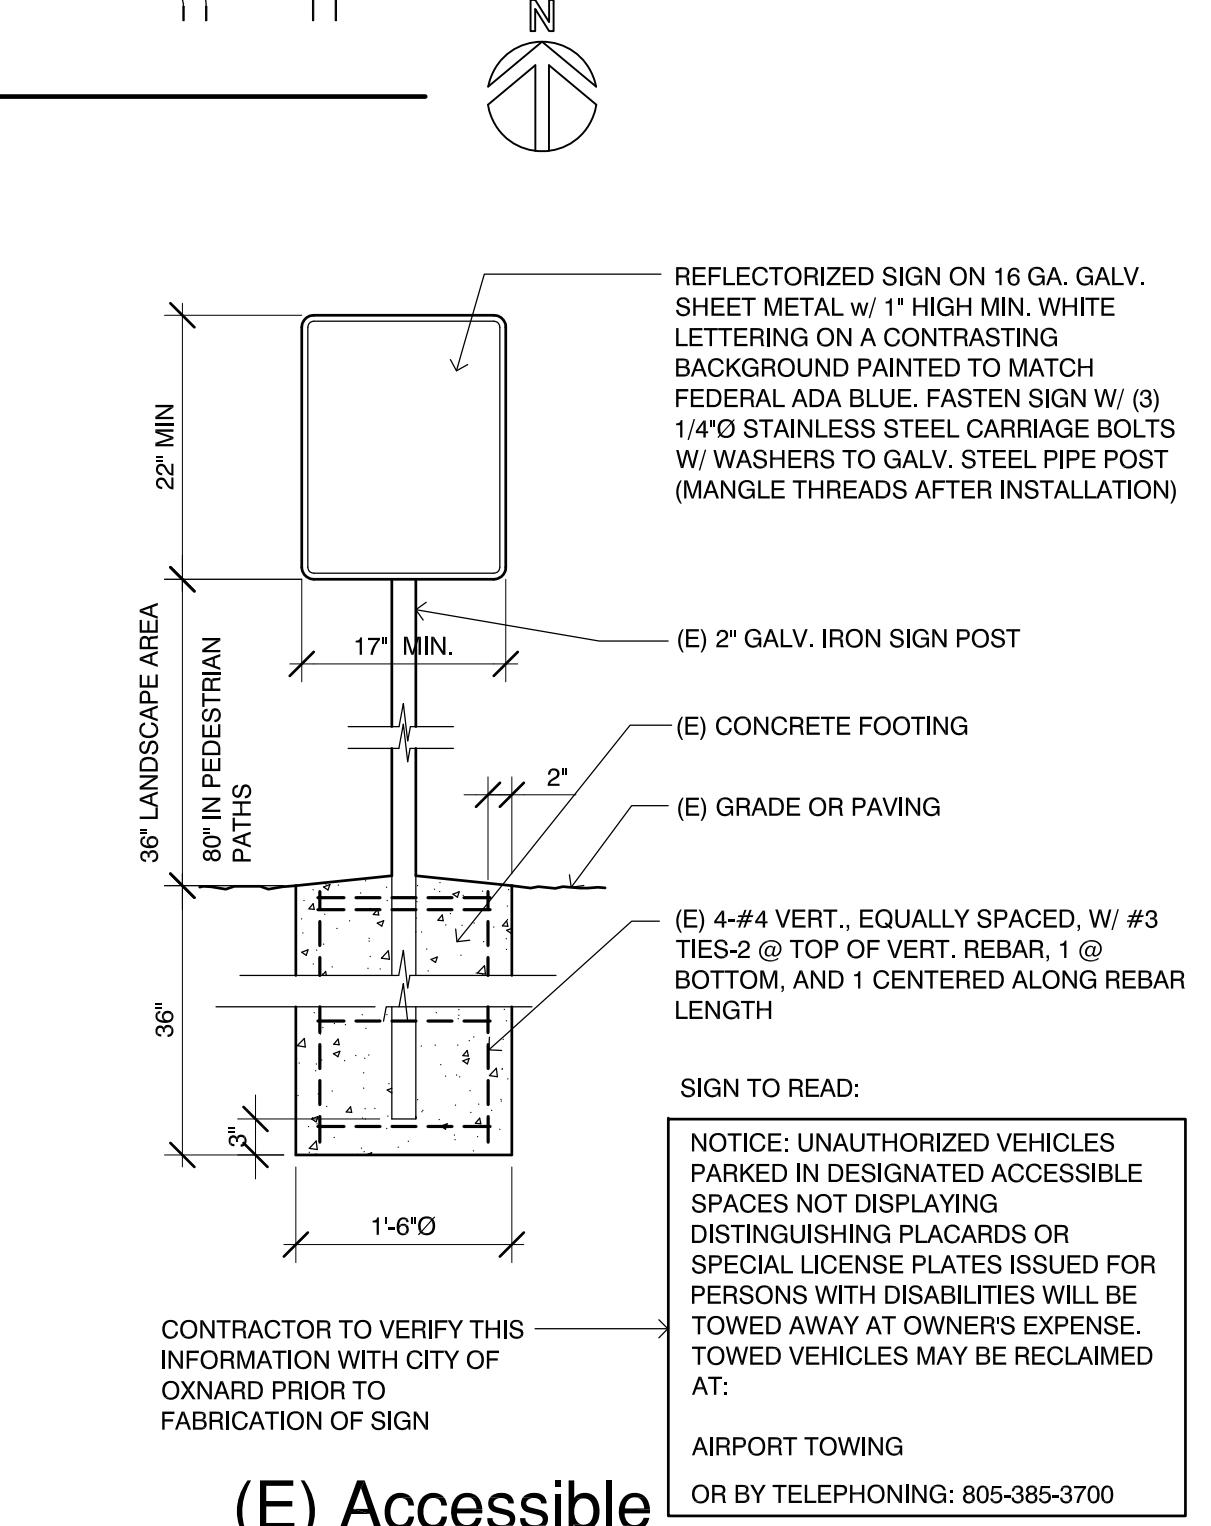


**5 (E) Accessible Parking Lot Entrance Sign**  
 SCALE: 3/4" = 1'-0"

REVISION	DESCRIPTION	DATE	BY
1	PP/JL		
2	TJ	1/18/2019	
3			
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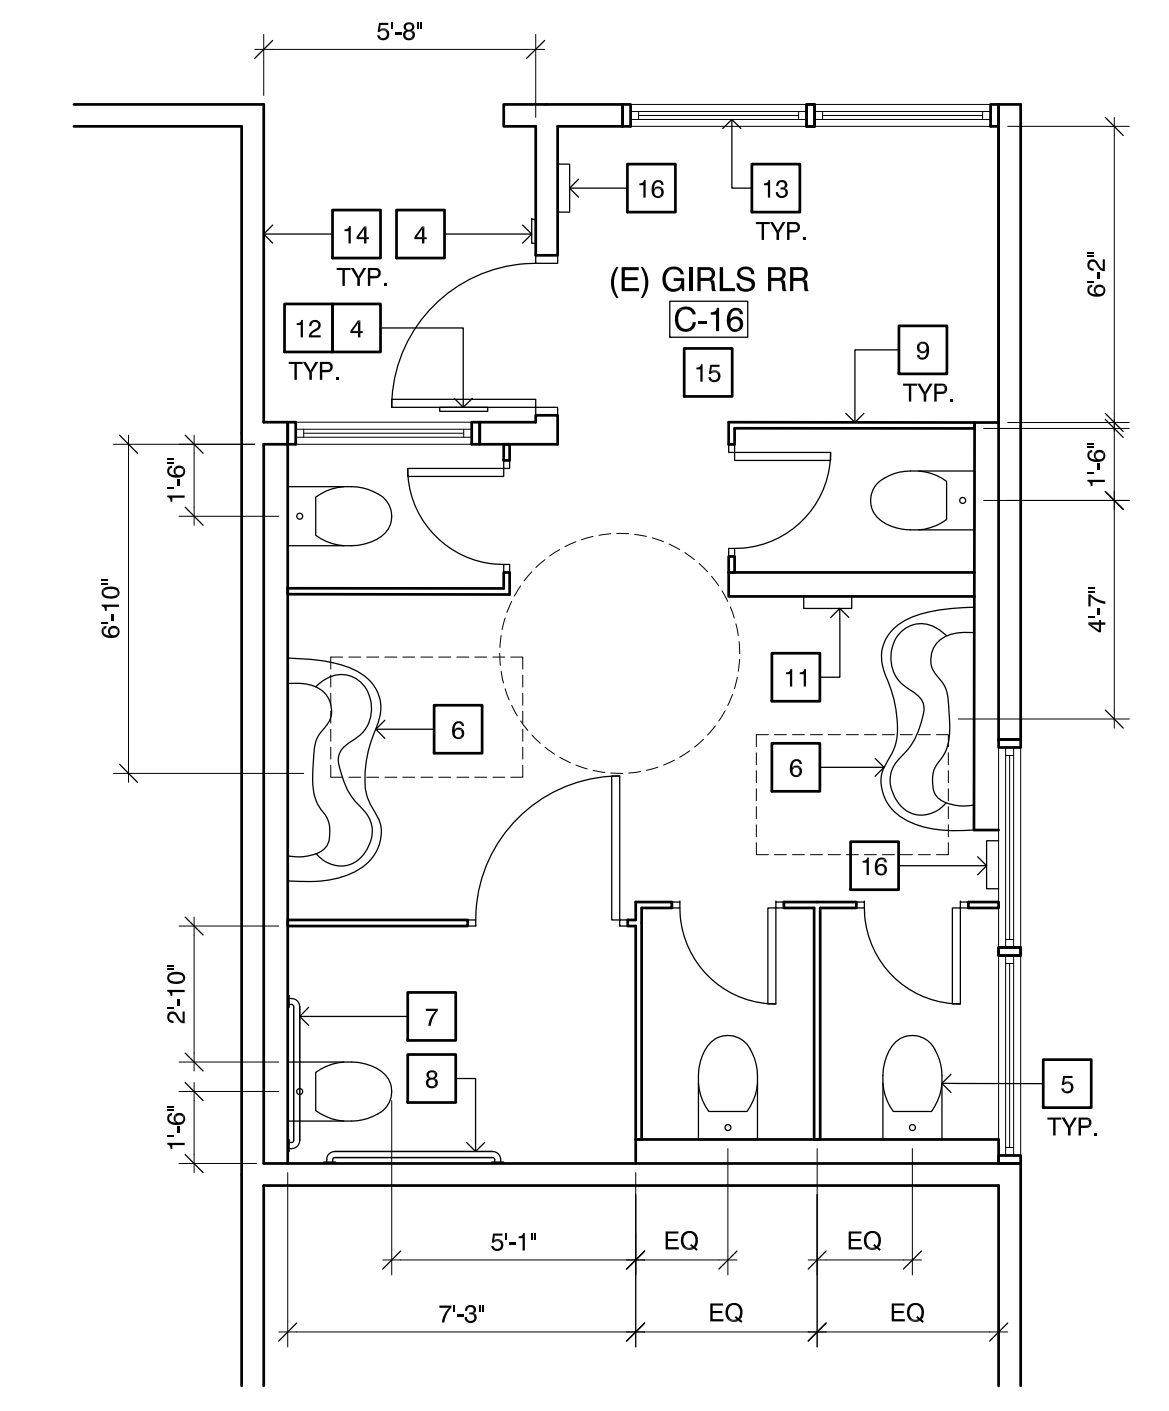
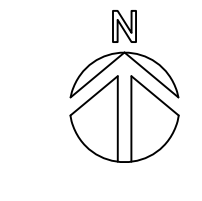
DRAWN: PP/JL  
 CHECKED: TJ  
 DATE: 1/18/2019  
 JOB NO.: 18016  
 SHEET: SITE PLAN  
 TITLE: SITE DETAILS  
 SHEET: A-100

EXISTING RESTROOM KEYNOTES



- 1 UPDATE (E) MEN'S RESTROOM SIGNAGE IF NON-COMPLIANT (S5 A-800)
- 2 UPDATE (E) WOMEN'S RESTROOM SIGNAGE IF NON-COMPLIANT (S4 A-800)
- 3 UPDATE (E) BOYS RESTROOM SIGNAGE IF NON-COMPLIANT (S3 A-800)
- 4 UPDATE (E) GIRL'S RESTROOM SIGNAGE IF NON-COMPLIANT (S2 A-800)
- 5 (E) WATER CLOSET TO REMAIN
- 6 (E) SINK TO REMAIN
- 7 (E) 36" S.S. GRAB BAR TO REMAIN
- 8 (E) 48" S.S. GRAB BAR TO REMAIN
- 9 (E) PARTITION TO REMAIN
- 10 (E) URINAL TO REMAIN
- 11 (E) HAND DRYER TO REMAIN
- 12 (E) DOOR TO REMAIN
- 13 (E) WINDOW TO REMAIN
- 14 (E) WALL TO REMAIN
- 15 (E) TILE FLOOR TO REMAIN
- 16 (E) PAPER TOWEL DISPENSER TO REMAIN
- 17 DEMO (E) PARTITION
- 18 DEMO (E) DOOR
- 19 (N) PARTITION
- 20 (N) DOOR
- 21 (N) 48" S.S. GRAB BAR

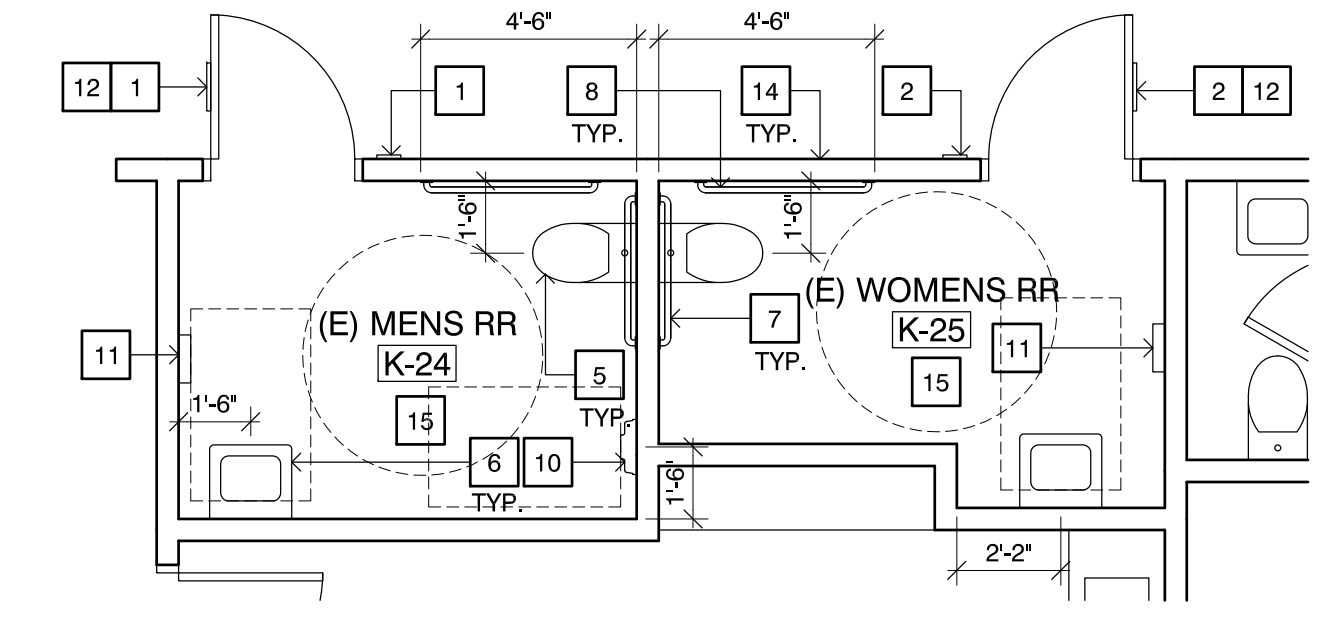



1 EXISTING STAFF RESTROOMS  
 SCALE: 1/4" = 1'-0"




2 EXISTING GIRLS RESTROOMS  
 SCALE: 1/4" = 1'-0"

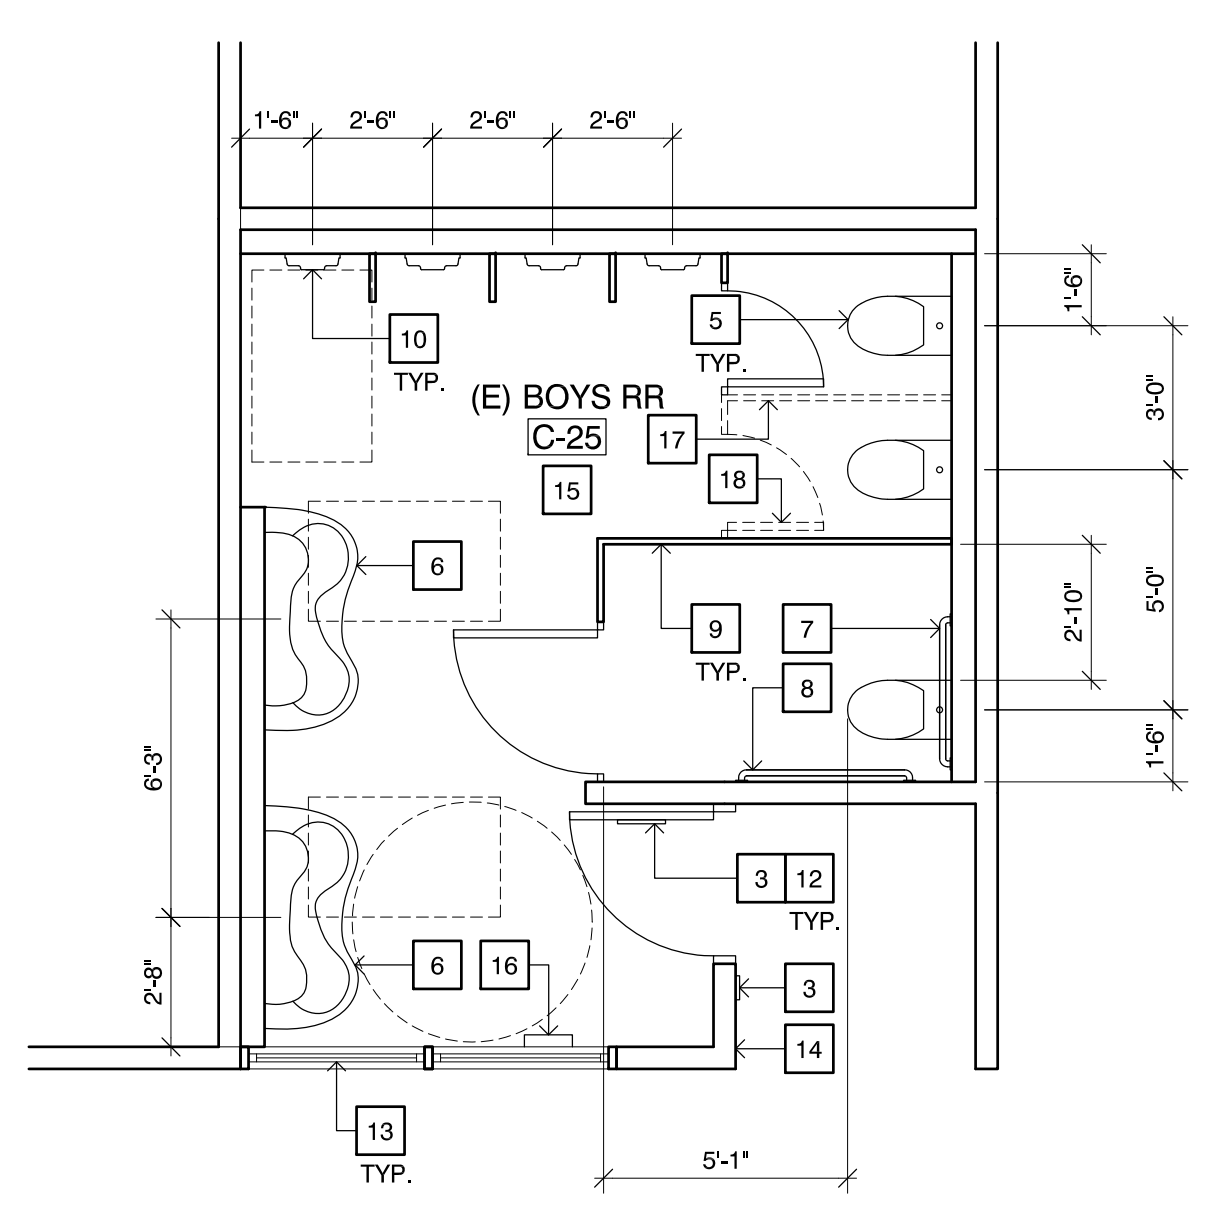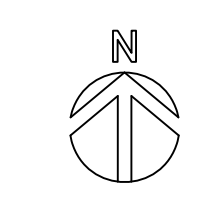

3 EXISTING BOYS RESTROOMS (DEMO)  
 SCALE: 1/4" = 1'-0"

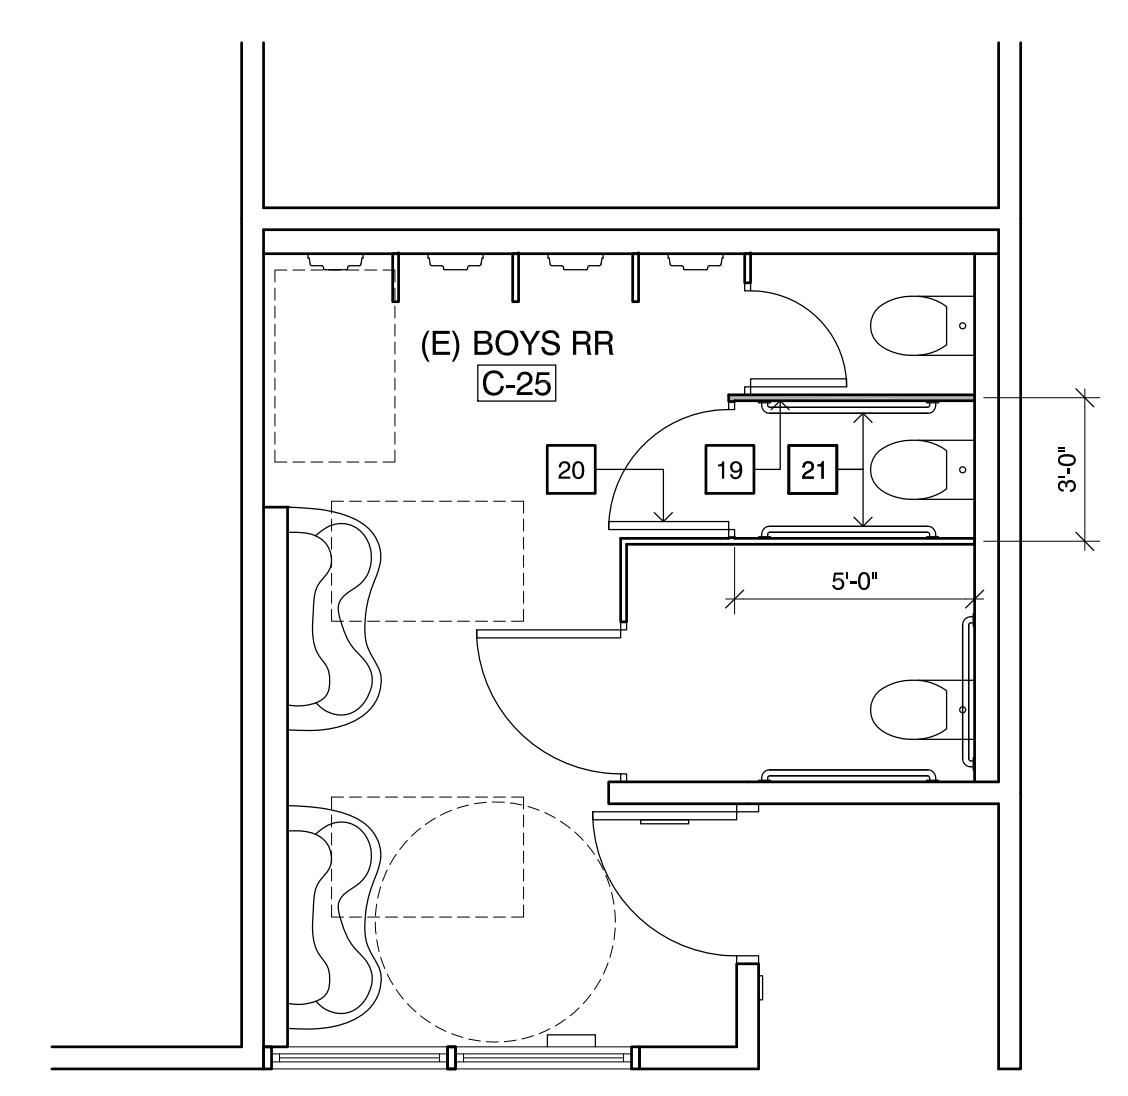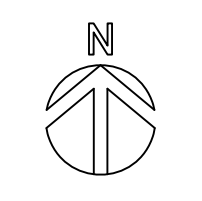

4 EXISTING BOYS RESTROOMS  
 (w/ NEW AMBULATORY TOILET STALL)  
 SCALE: 1/4" = 1'-0"

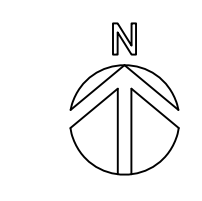


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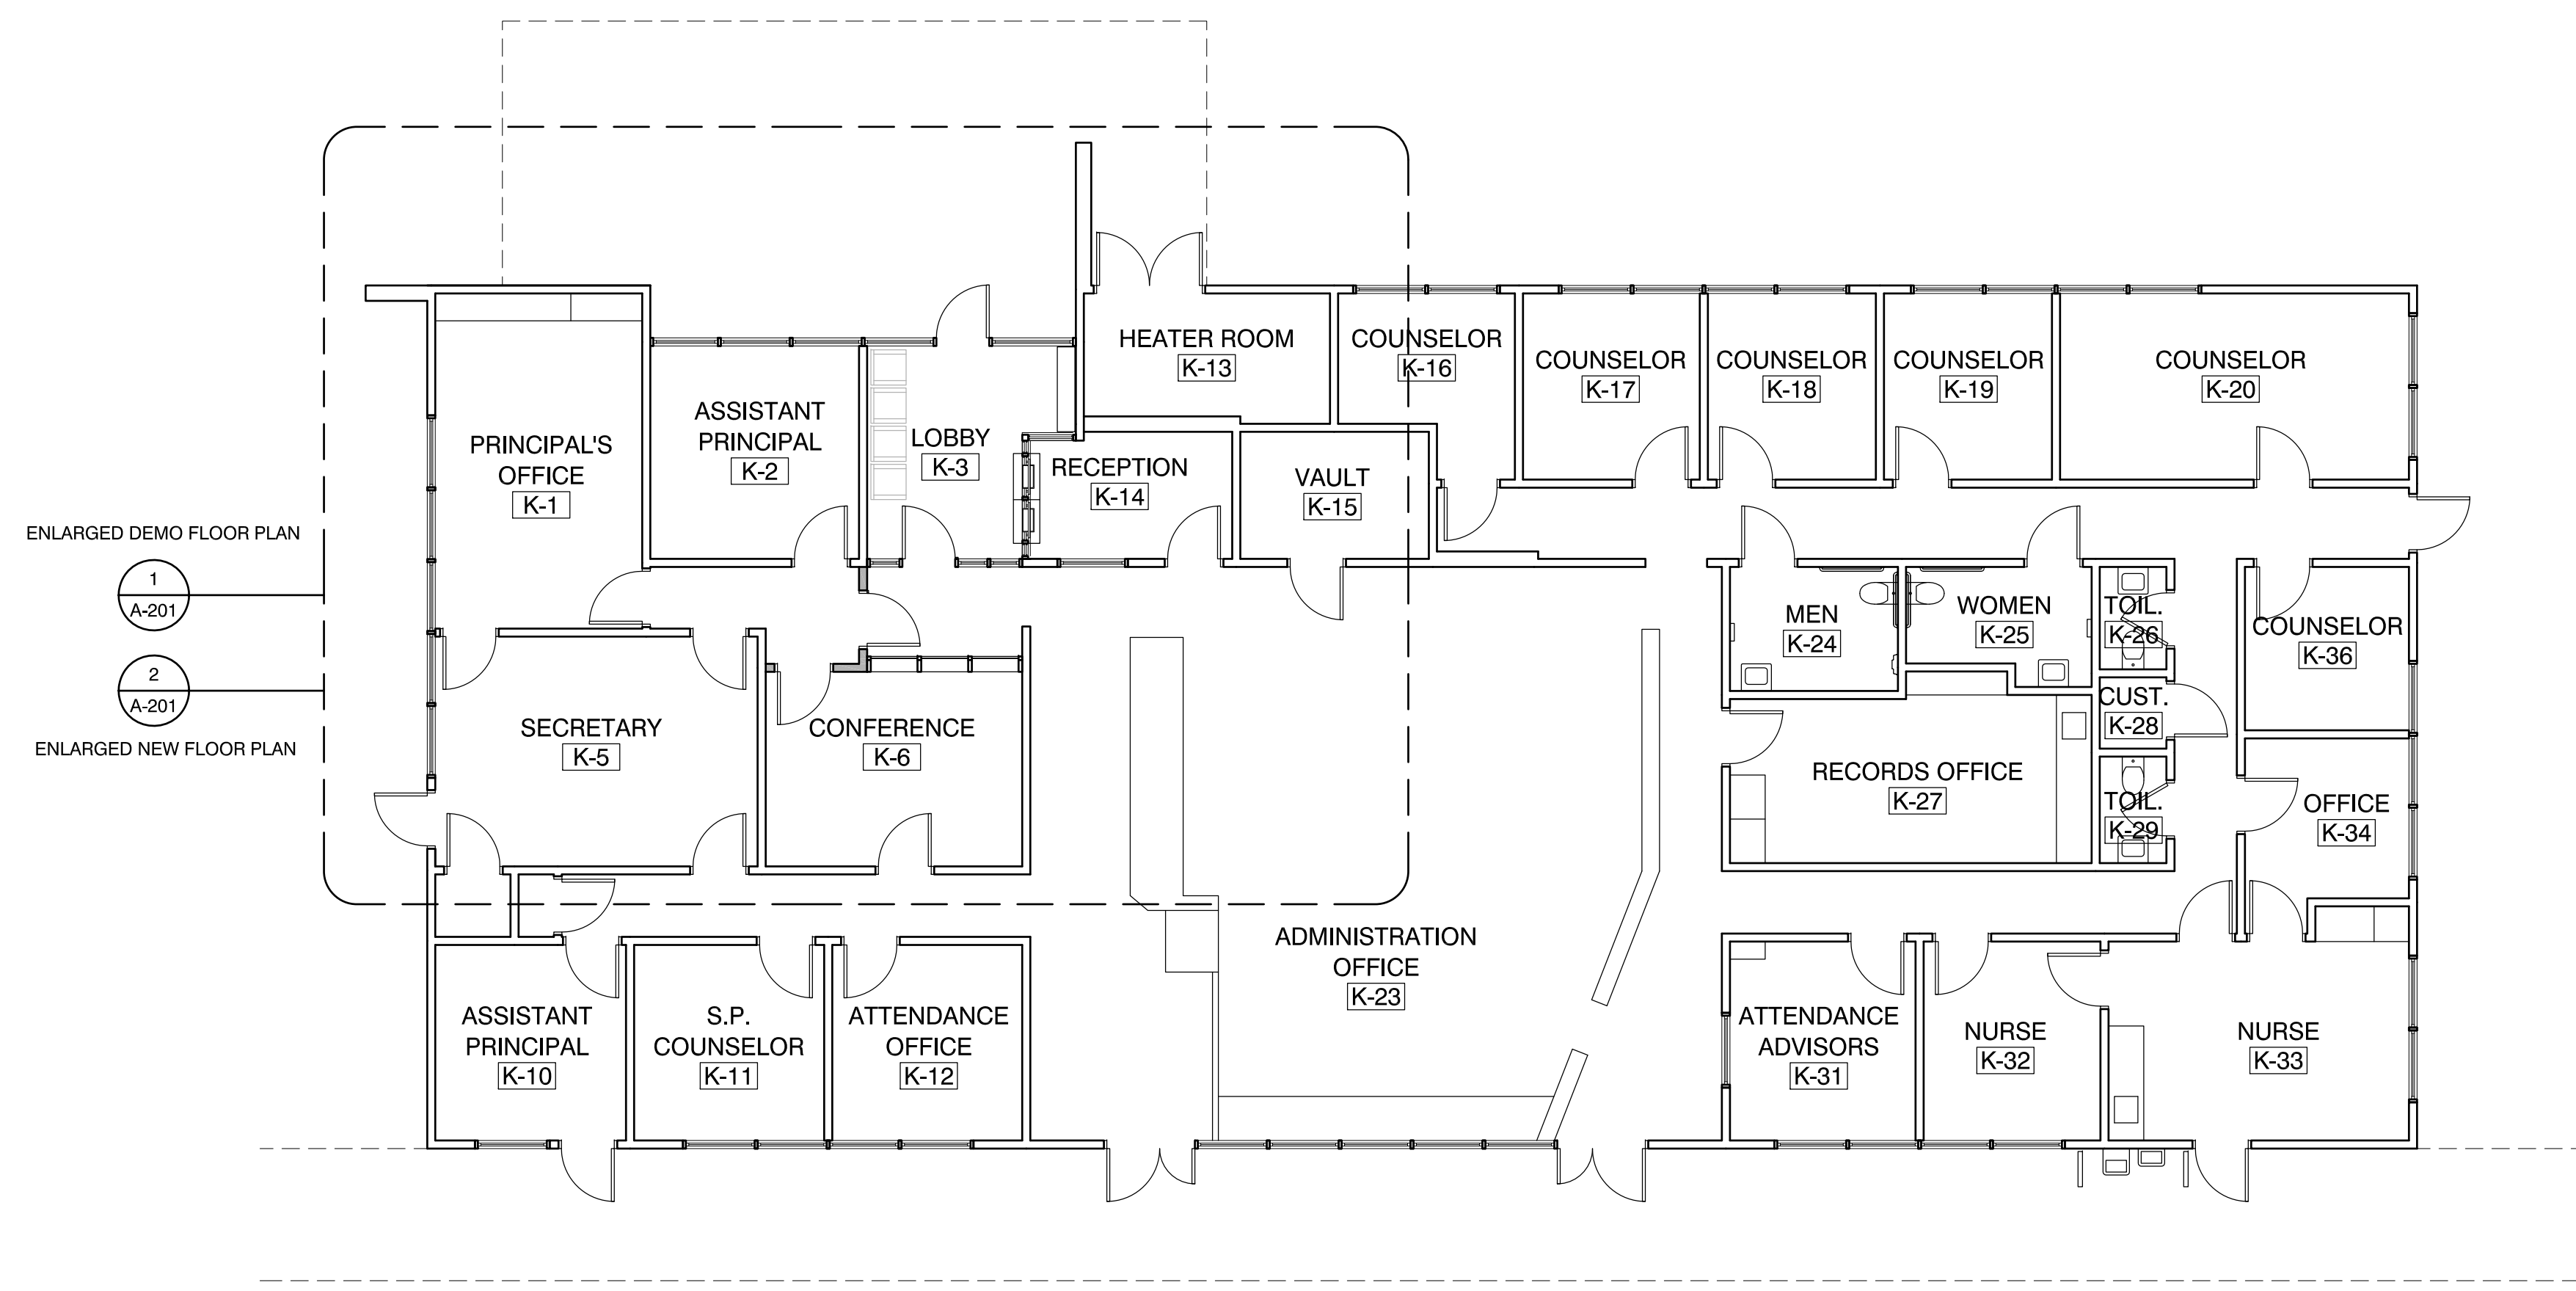
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DRAWN JL  
 CHECKED TJ  
 DATE 1/18/2019  
 JOB. NO. 18016

SHEET EXISTING RESTROOM PLANS  
 TITLE



IDENTIFICATION STAMP  
 DIV. OF THE STATE ARCHITECT  
 APP. 03-119340 INC.  
 REVIEWED FOR  
 SS  FLS  ACS   
 DATE: 4/2/19

OXNARD UNION HIGH SCHOOL DISTRICT  
 HUENEME HIGH SCHOOL  
 500 W. BARD RD. OXNARD, CA 93051  
 SITE SECURITY IMPROVEMENTS

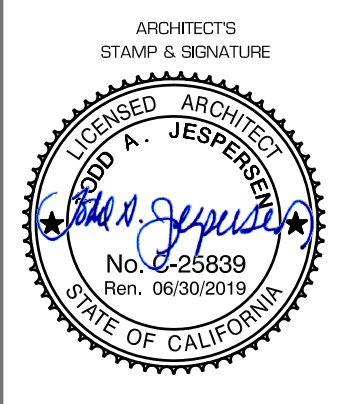

ENLARGED DEMO FLOOR PLAN  
 1 A-201  
 ENLARGED NEW FLOOR PLAN  
 2 A-201

1 BUILDING 'K' FLOOR PLAN  
 SCALE : 1/8" = 1'-0"

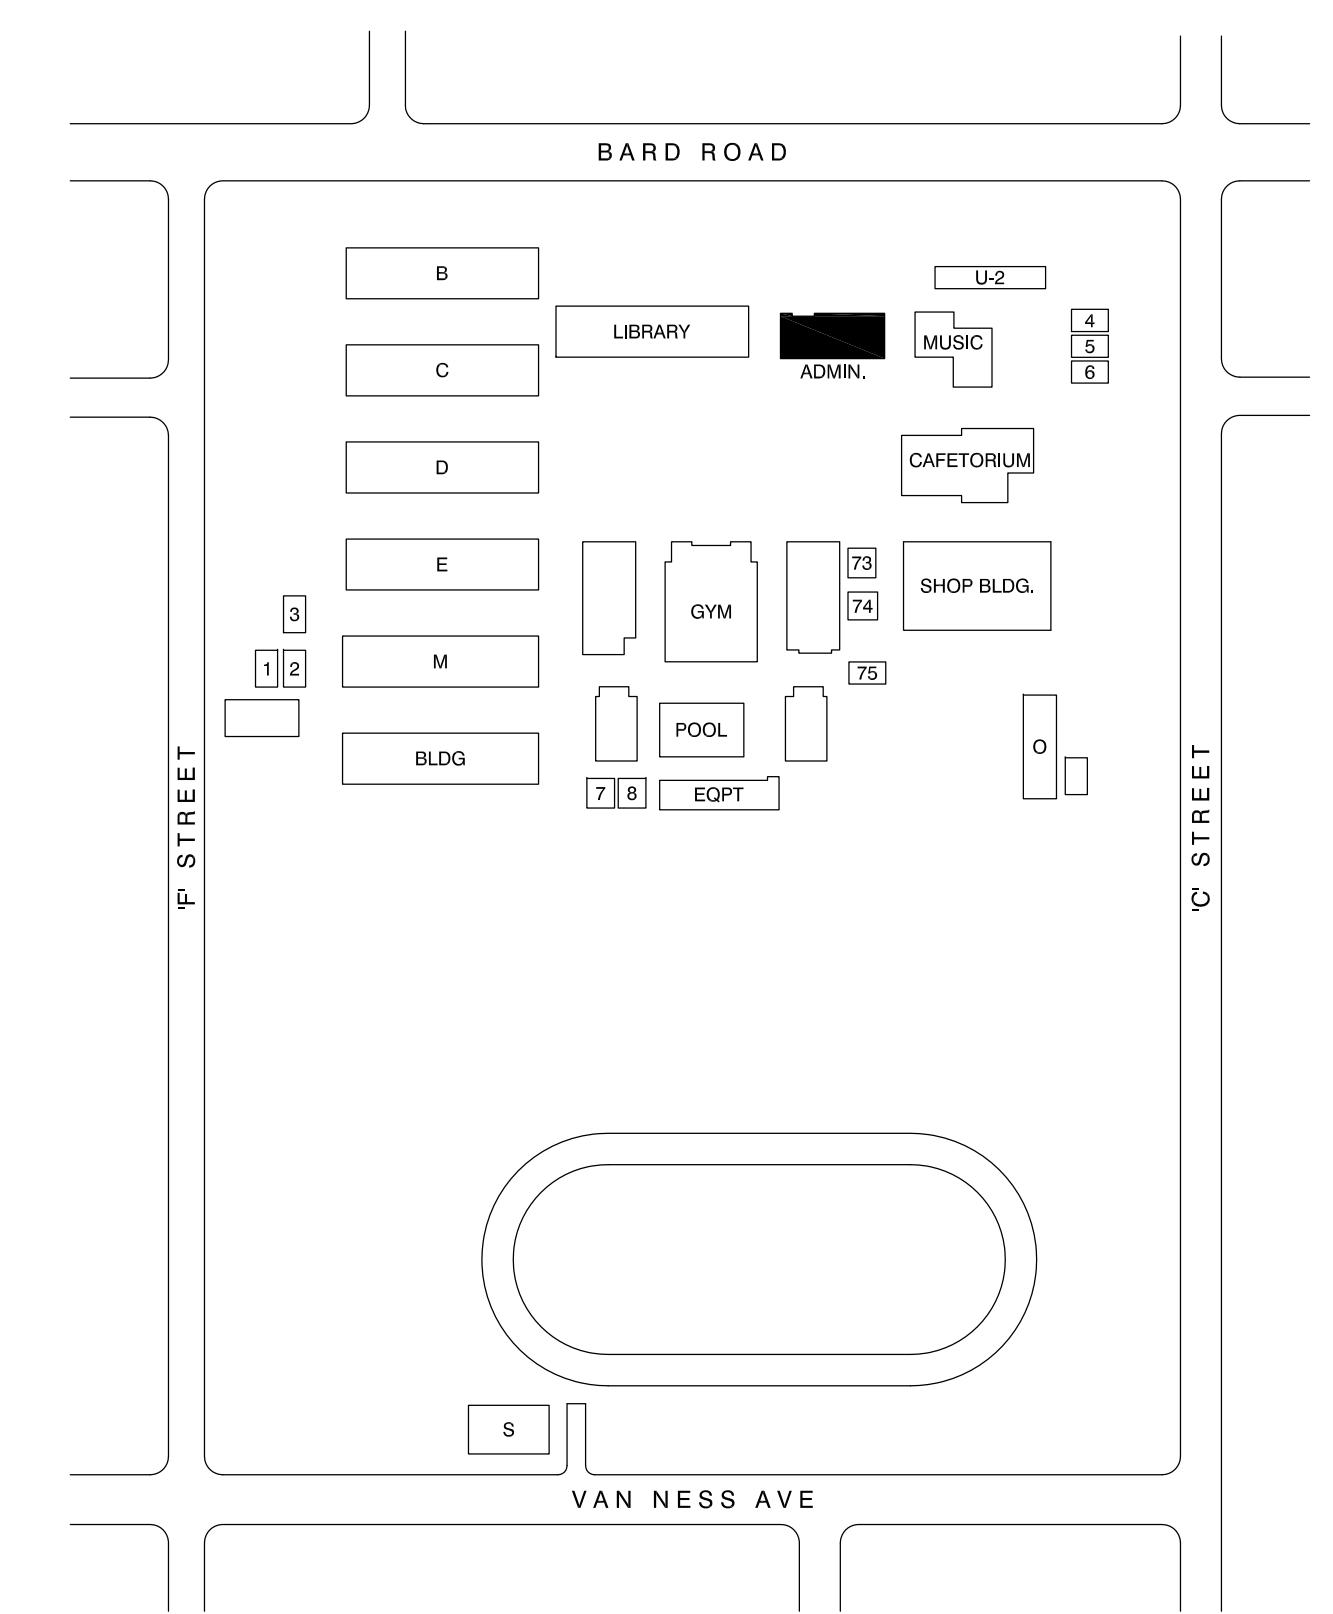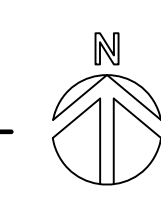

KEY PLAN



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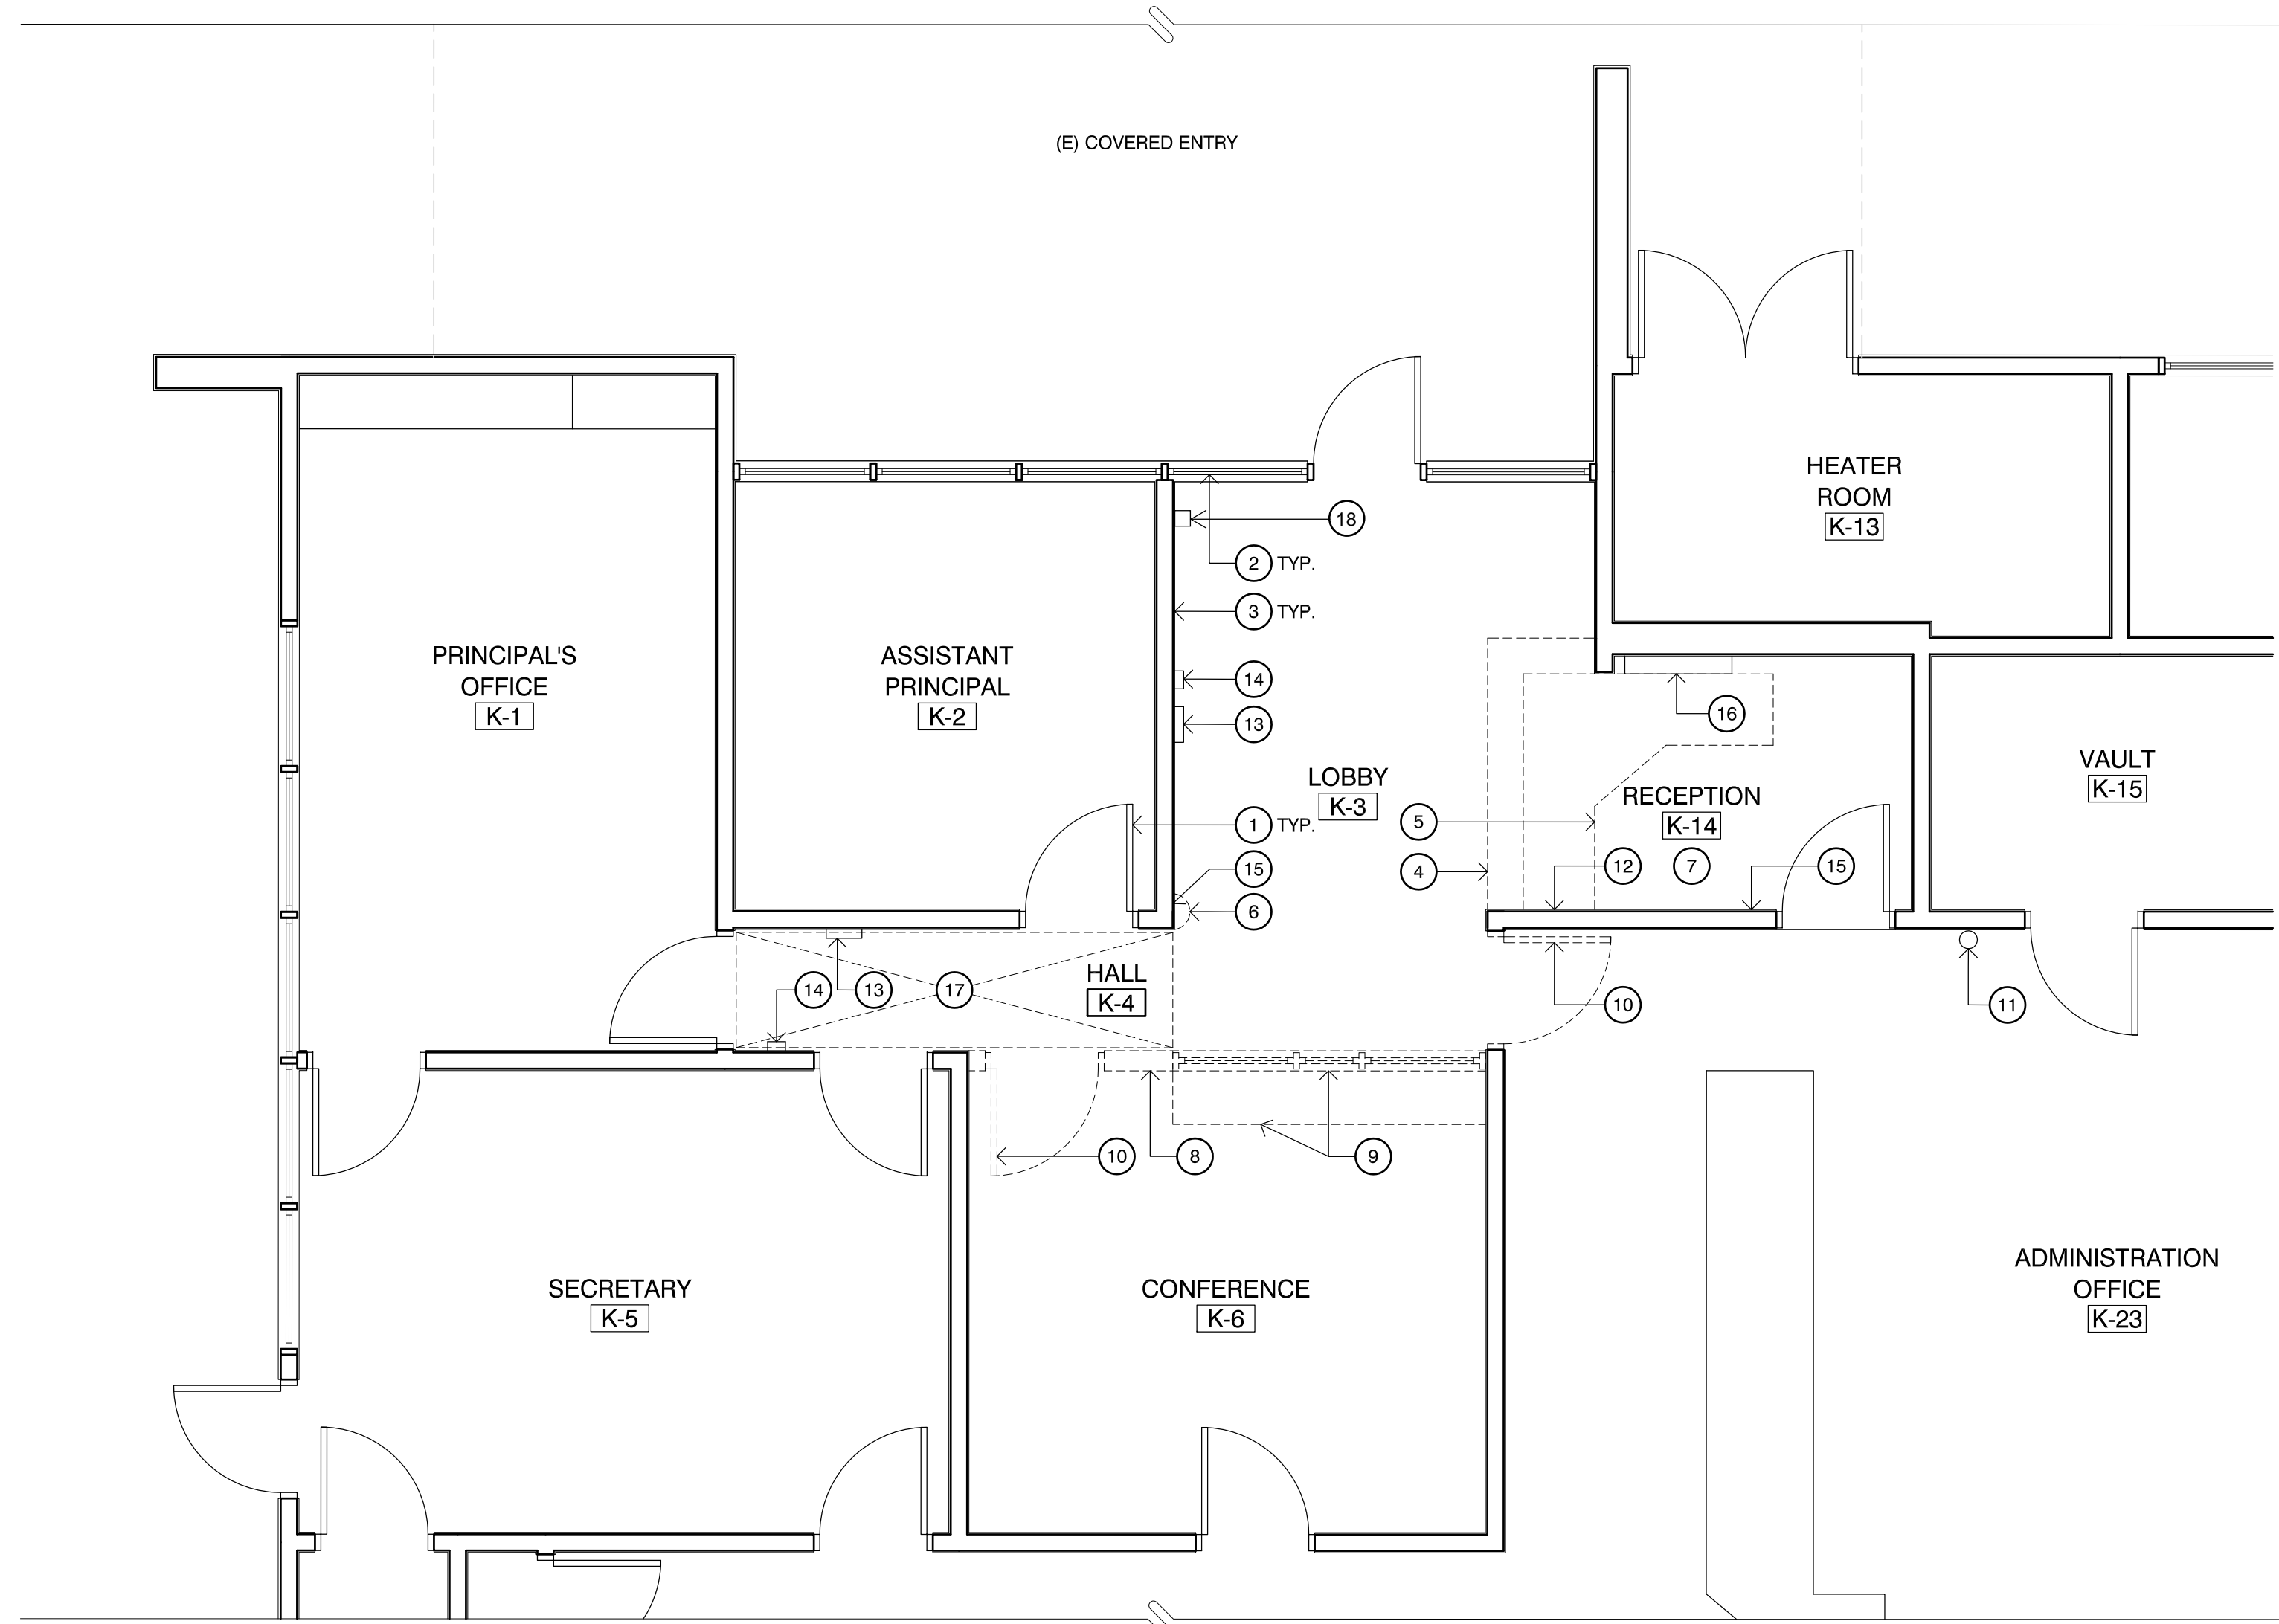


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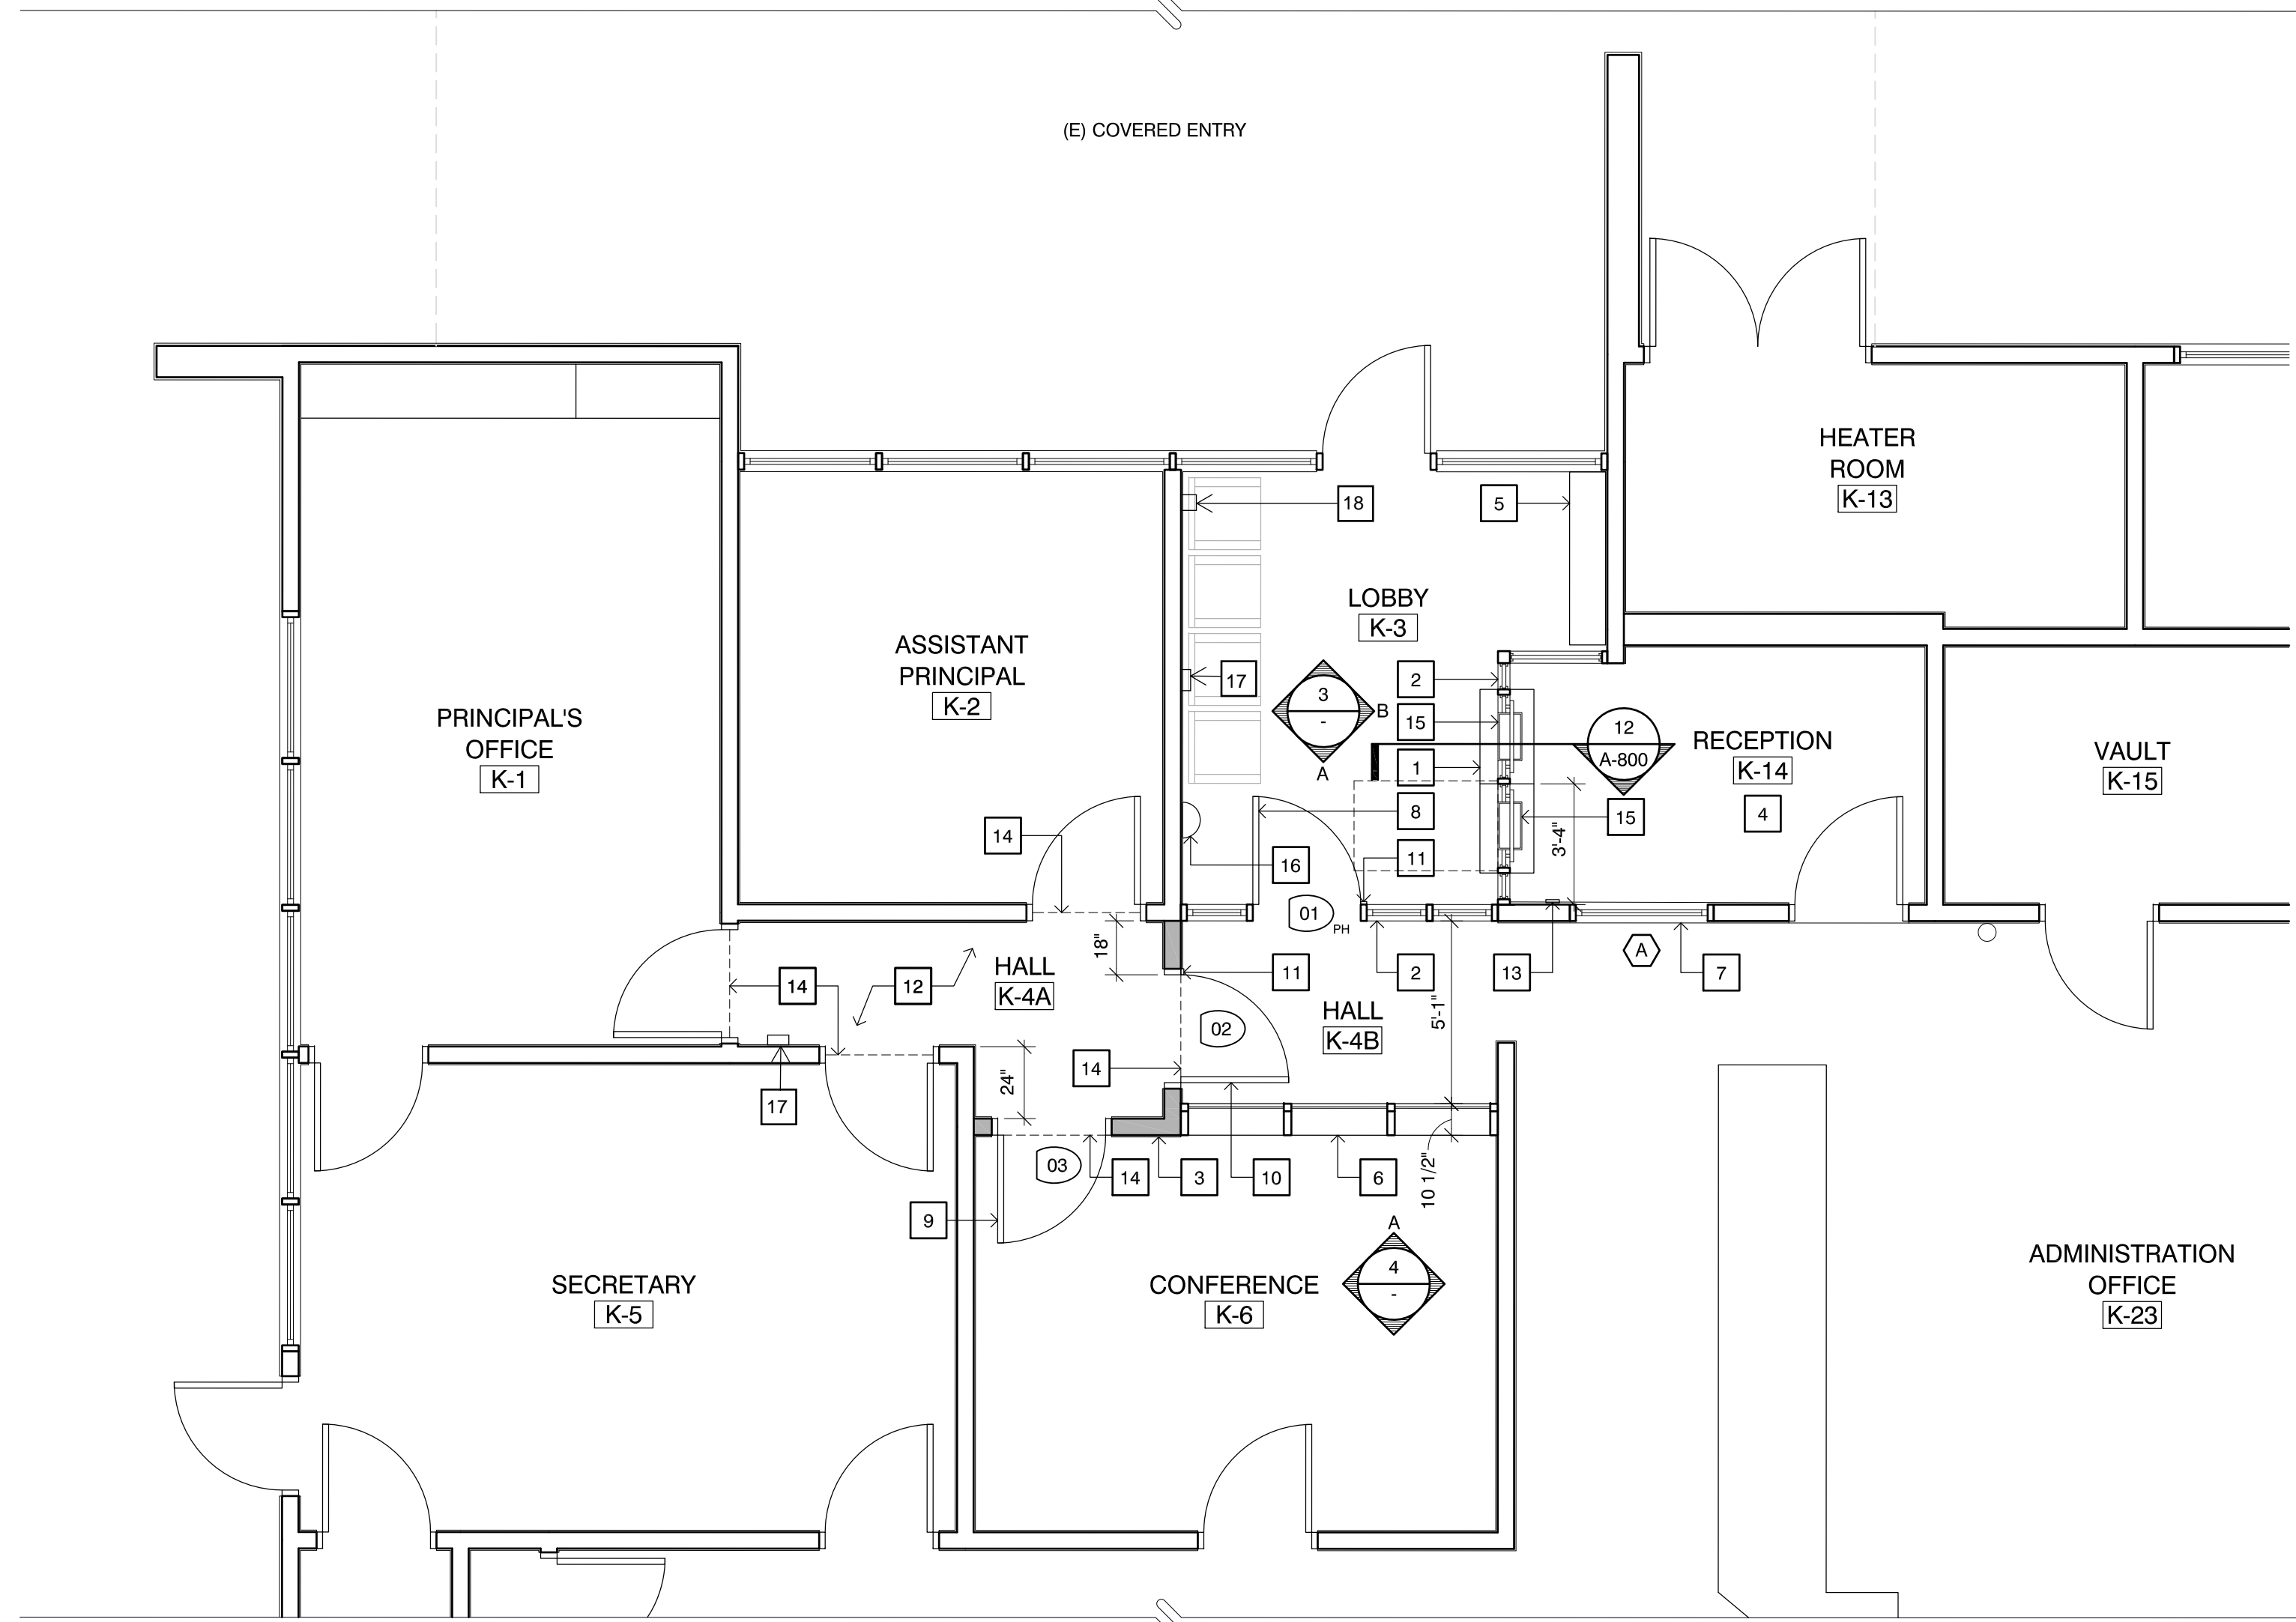
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 DATE 1/18/2019  
 JOB NO. 18016

SHEET BUILDING 'K' FLOOR PLAN  
 TITLE



SHEET  
**A-200**




**1 ENLARGED DEMO FLOOR PLAN**  
SCALE: 1/4" = 1'-0"



**2 ENLARGED NEW FLOOR PLAN**  
SCALE: 1/4" = 1'-0"

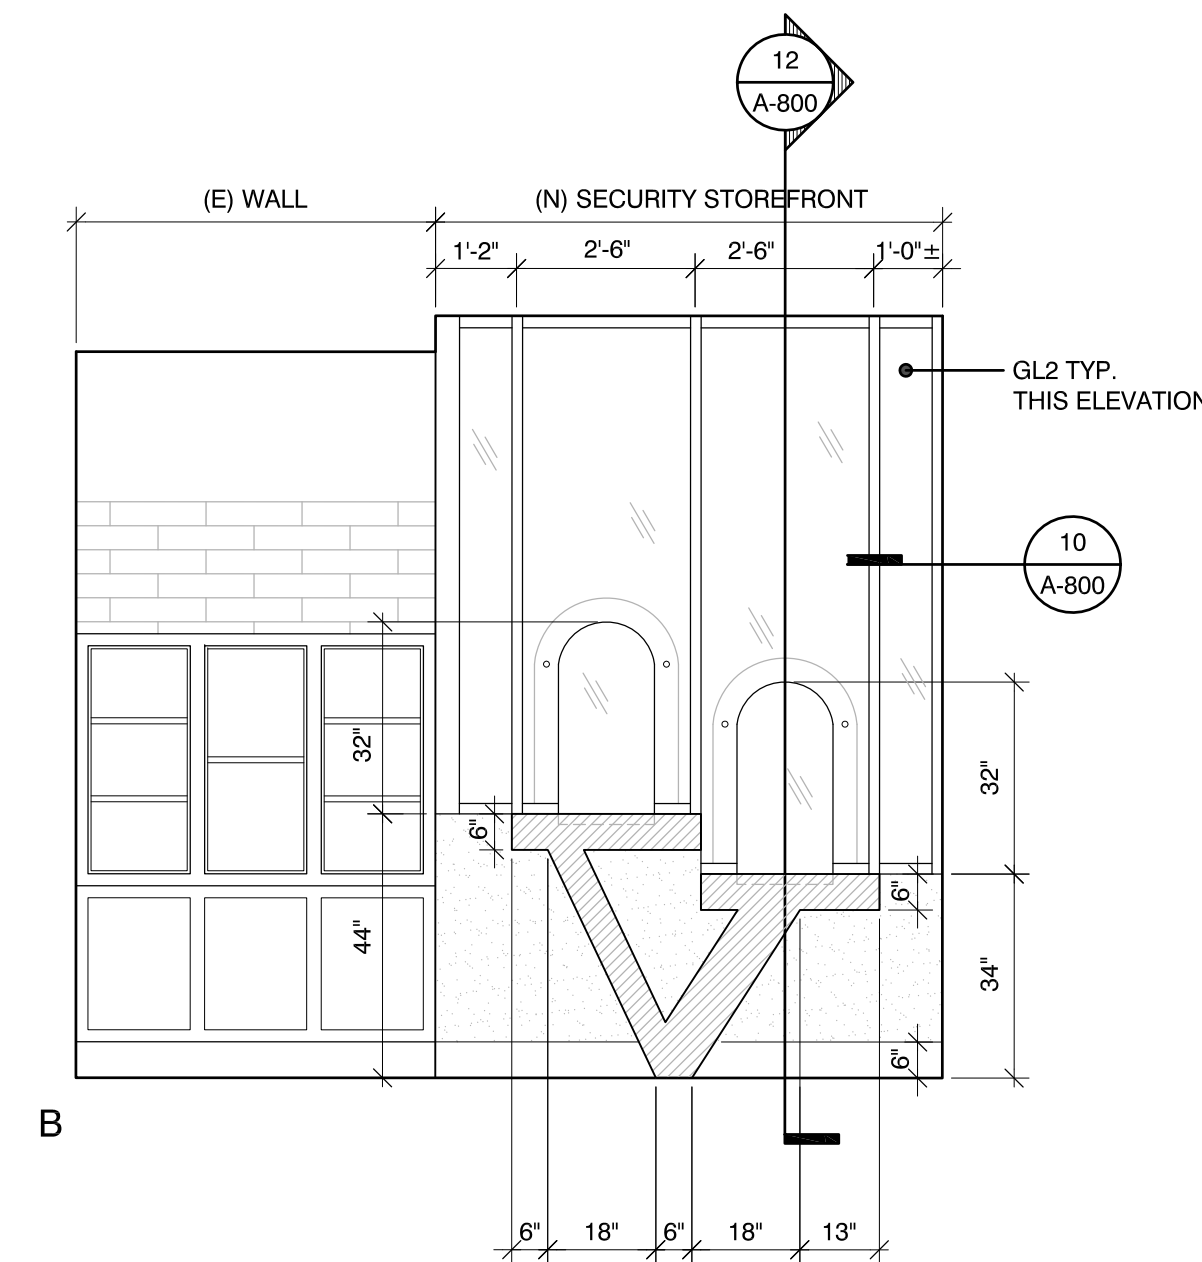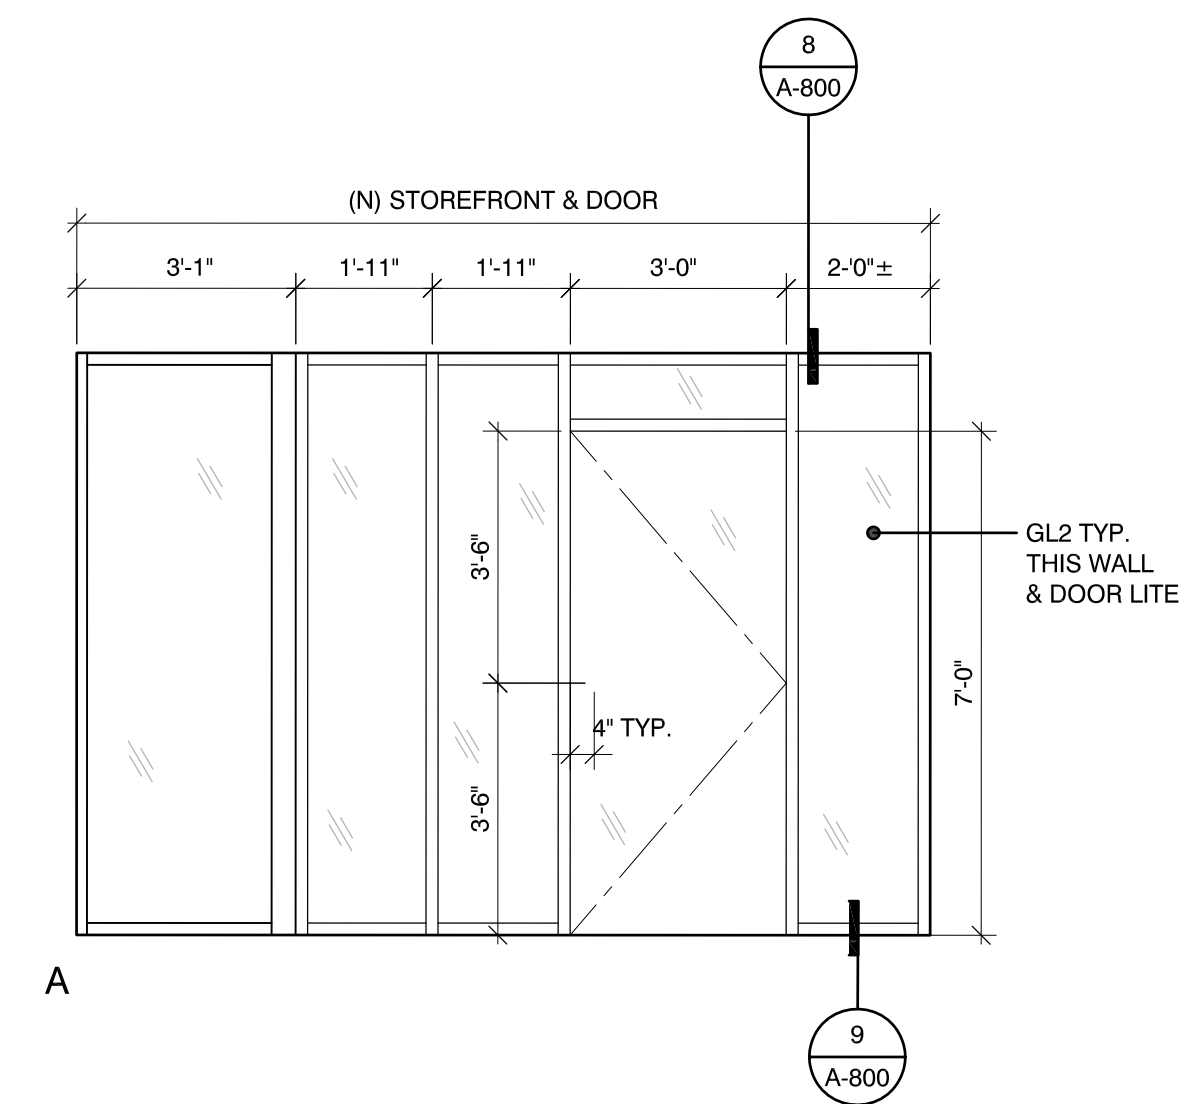

**3 INTERIOR ELEVATIONS - LOBBY**  
SCALE: 3/8" = 1'-0"

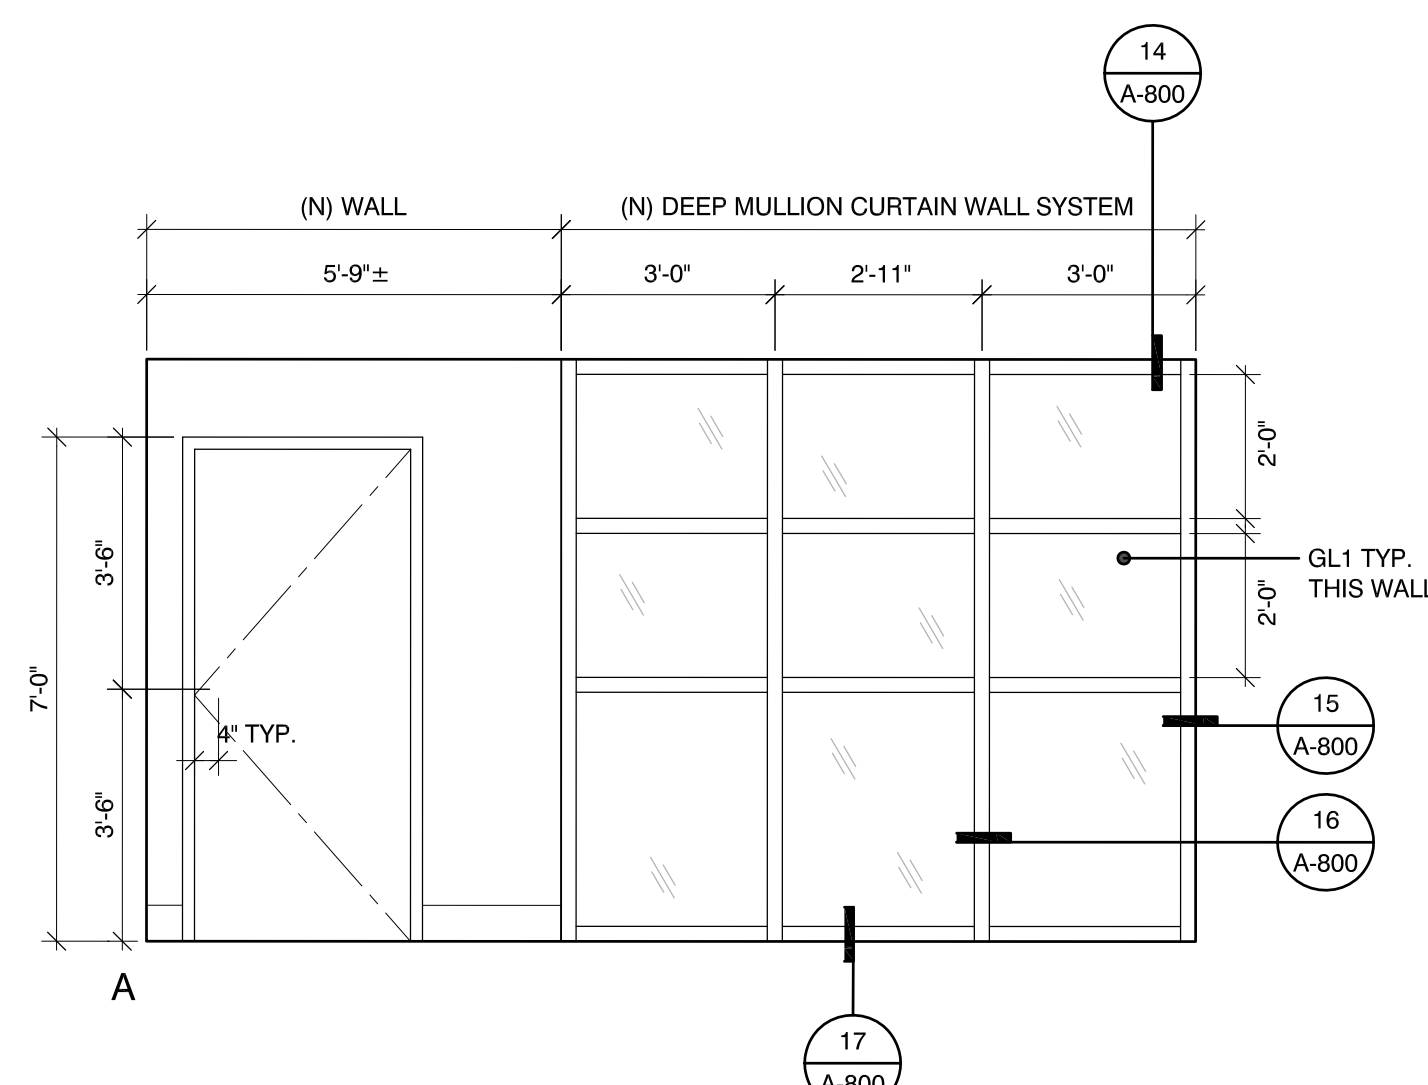

**4 INTERIOR ELEVATIONS - CONFERENCE**  
SCALE: 3/8" = 1'-0"

**DEMO PLAN KEYNOTES**

- 1 (E) DOOR TO REMAIN
- 2 (E) WINDOW TO REMAIN
- 3 (E) WALL TO REMAIN
- 4 DEMO (E) COUNTER
- 5 REMOVE (E) WORKSTATION
- 6 RELOCATE (E) HALF-DOME SAFETY MIRROR
- 7 REMOVE (E) CARPET & RUBBER BASE
- 8 DEMO (E) WALL
- 9 DEMO (E) WINDOW & STOREFRONT/COUNTER ASSEMBLY
- 10 DEMO (E) DOOR & FRAME
- 11 (E) FIRE EXTINGUISHER TO REMAIN
- 12 (E) WALL OUTLET TO REMAIN
- 13 (E) EMERGENCY LIGHTING TO REMAIN
- 14 UPDATE (E) FIRE ALARM STROBE TO HORN/STROBE
- 15 (E) LIGHT SWITCH TO REMAIN
- 16 (E) FIRE ALARM PANEL TO REMAIN
- 17 (E) REMOVE (E) VCT & BASE FOR (N) WORK
- 18 (E) PULL STATION TO REMAIN

**NEW PLAN & INTERIOR ELEVATIONS KEYNOTES**

- 1 (N) HI-LO COUNTER
- 2 (N) SECURITY STOREFRONT ASSEMBLY
- 3 (N) WALL
- 4 (N) CARPET & RUBBER BASE
- 5 (N) TROPHY DISPLAY CASE
- 6 (N) 10 1/2" DEEP MULLION CURTAIN WALL SYSTEM w/ 1/4" LAMINATED SAFETY GLASS
- 7 (N) 4' W. WINDOW
- 8 (N) STOREFRONT DOOR
- 9 (N) DOOR
- 10 (N) DOOR WITH VISION PANEL
- 11 (N) CARD ACCESS
- 12 (N) VCT TO MATCH (E)
- 13 (N) DOOR ACCESS CONTROLS @ +36" AFF
- 14 (N) ALUMINUM TRANSITION STRIP
- 15 (N) BULLET-TRAP RECESSED CURRENCY TRAY
- 16 (N) LOCATION FOR (E) HALF-DOME SAFETY MIRROR
- 17 (N) FIRE ALARM HORN/STROBE
- 18 (E) PULL STATION TO REMAIN

**LEGEND**

- (N) WALL MATCH (E) ADJACENT FINISHES
- (N) HI-LO SOLID SURFACE CASEWORK TRANSACTION COUNTER
- (N) GYPSUM BOARD

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DATE: 4/2/19


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HUENEME HIGH SCHOOL  
500 W. BARD RD. OXNARD, CA 93051  
SITE SECURITY IMPROVEMENT



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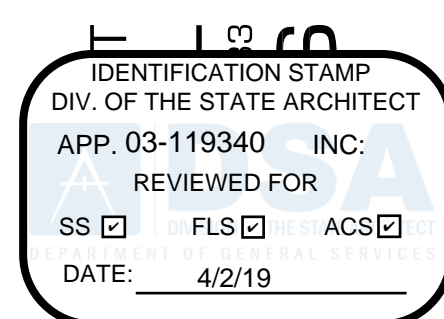
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REVISION	DESCRIPTION	DATE	BY
DRAWN	JL		
CHECKED	TJ		
DATE		1/18/2019	
JOB. NO.		18016	

SHEET ENLARGED DEMO FLOOR PLAN  
TITLE ENLARGED NEW FLOOR PLAN  
INTERIOR ELEVATIONS

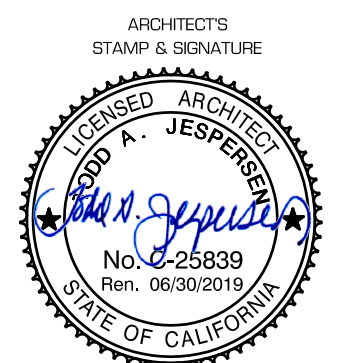

OXNARD UNION HIGH SCHOOL DISTRICT  
 HUENEME HIGH SCHOOL  
 500 W. BARD RD. OXNARD, CA 93030  
 SITE SECURITY IMPROVEMENT

DOOR, FRAME AND SIGNAGE MESSAGE SCHEDULE																															
DOOR	DOOR INFO																	SIGNAGE INFO													
	DOOR OPENING		DOOR					CUTOUTS		HDWR GROUP	ASSY FIRE RATING	FRAME				DETAILS				DOOR REMARKS	SIGN TYPE/ SEE DETAIL SIDE OF DOOR		DESCRIPTION		MESSAGE		SIGNAGE REMARKS				
	WIDTH	HEIGHT	TYPE	MAT'L	THICK	FIN	COLOR	LITE	LVR			TYPE	MAT'L	FIN	COLOR	HEAD	JAMB	SILL	SIGNAGE		PULL SIDE	PUSH SIDE	PULL SIDE	PUSH SIDE	PULL SIDE	PUSH SIDE					
1	3'-0"	7'-0"	A	BR	1 3/4"	FF	TBD	1	-	01	-	1	HM	FF	TBD	4 A-800	4 A-800	4 A-800	7 A-800	G1 A-800	S1 A-800	CARD READER & ACCESS CONTROL PANIC HARDWARE	S1	S1	◇	◇	OFFICE	EXIT	◇		
2	3'-0"	7'-0"	B	SC WD	1 3/4"	P.LAM	TBD	1	-	02	-	1	HM	PT	TBD	4 A-800	4 A-800	4 A-800	7 A-800	G1 A-800	S1 A-800	CARD READER & ACCESS CONTROL	S1	S1	◇	◇	PRINCIPAL ASSISTANT PRINCIPAL EXIT	EXIT	CONFERENCE	◇	
3	3'-0"	7'-0"	B	SC WD	1 3/4"	P.LAM	TBD	-	-	02	-	1	HM	PT	TBD	4 A-800	4 A-800	4 A-800	7 A-800	G1 A-800	S1 A-800		S1	S1	◇	◇					◇

**DOOR & WINDOW SCHEDULE KEYNOTES**

- 1 DOOR HARDWARE PROVIDED BY MODULAR PARTITION MANUFACTURER

**SIGNAGE KEYNOTES**

- 1 EXTERIOR PANEL SIGN
- 2 INTERIOR PANEL SIGN

**GLAZING TYPES**

- GL1 LAMINATED SAFETY GLASS (CLEAR) - 1/2" THICK
- GL2 BULLET-RESISTANT 1-1/4" LP 125 - LAMINATED (CLEAR)

**ABBREVIATIONS**

- ALUM ALUMINUM
- FF FACTORY FINISH
- HM HOLLOW METAL
- MFR PER MANUFACTURER
- PT PAINTED
- SC WD SOLID CORE WOOD
- SS STAINLESS STEEL
- BR BULLET-RESISTANT
- P.LAM PLASTIC LAMINATE

**GENERAL NOTES**


- SEE S1/A-800 FOR INTERIOR PANEL SIGNAGE MOUNTING HEIGHTS.
- SEE DOOR & FRAME SCHEDULE FOR PANEL SIGNAGE ASSOCIATED w/ A DOOR.
- SEE SHEET A-800 FOR SIGN DETAILS.

**SIGNAGE NOTES**

- SK1 PANEL WALL MOUNT

**DOORS AND WINDOWS NOTES**


- VERIFY ALL ROUGH OPENINGS DIMENSIONS PRIOR TO FABRICATION.
- ALL DOORS SHALL HAVE LEVER HARDWARE U.O.N. DOOR HANDLES, PULLS, LATCHES, LOCKS, AND OTHER OPERATING DEVICES SHALL BE INSTALLED MINIMUM 34" AND MAXIMUM 48" ABOVE FINISH FLOOR. (CBC 1008.1.9.2).
- ALL EXIT DOORS SHALL BE OPENABLE FROM INSIDE WITHOUT THE USE OF A KEY OR SPECIAL KNOWLEDGE (CBC 1008.1.9) AND THE FORCE REQUIRED TO PUSH OR PULL AN EGRESS DOOR TO THE OPEN POSITION SHALL NOT EXCEED 5 POUND (CBC 1008.1.3).
- CONTRACTOR SHALL PROVIDE POWER AS NECESSARY FOR FULL OPERATION OF KEYPAD ACCESS.
- PANIC HARDWARE SHALL CONTAIN A MINIMUM OF TWO LOCKING POINTS ON EACH DOOR.
- GLAZING IN DOORS OR WITHIN 40" OF ANY DOOR LOCKING MECHANISM SHALL BE FULLY TEMPERED SAFETY GLASS.
- ALL PEDESTRIAN DOORS AND GATES (EXCEPT SLIDING DOORS) SHALL BE PROVIDED WITH A KICKPLATE AT THE BOTTOM 10 INCHES OF THE PUSH SIDE OF THE DOOR.
- PROVIDE STEEL INSERTS AT STOREFRONTS AS REQUIRED.

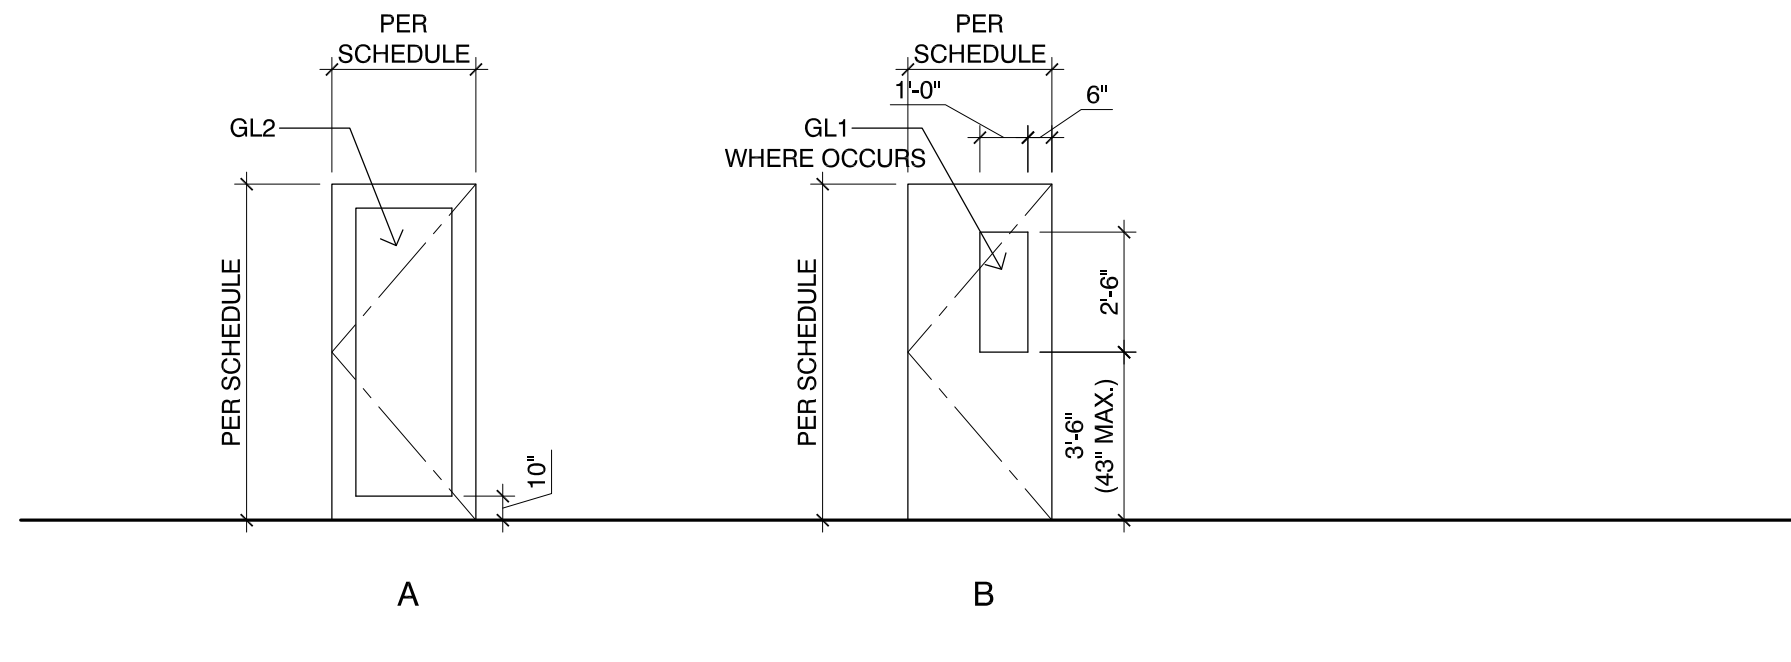

**DOOR TYPES**  
SCALE: 1/4" = 1'-0"

**DOOR FRAME TYPES**  
SCALE: 1/4" = 1'-0"

WINDOW & LOUVER SCHEDULE														
WINDOW TYPE	NOMINAL SIZE		FRAME			GLASS (2)		SCREEN	ASSY FIRE RATING	DETAILS				REMARKS
	WIDTH	HEIGHT	MATERIAL	FIN	COLOR	TYPE	THK			HEAD	L JAMB	R JAMB	SILL	
A	4'-0"	3'-6"	ALUM.	FF	TBD	GL-1	1/4"	-	NONE	18 A-800	18 A-800	18 A-800	18 A-800	FIXED STOREFRONT

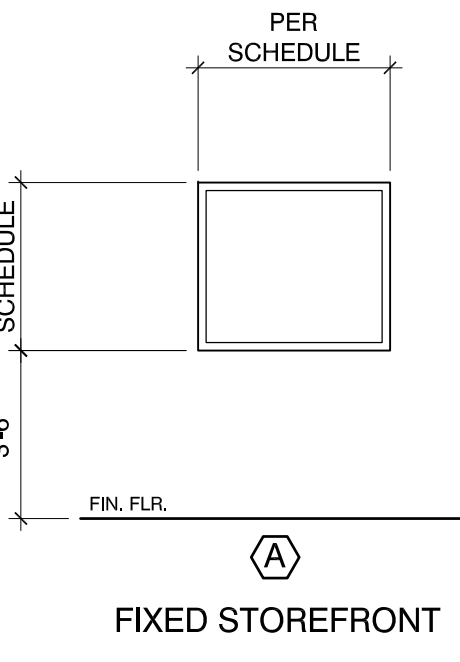


**WINDOW TYPES**  
SCALE: 1/4" = 1'-0"



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△	-	-/-	XX
△	-	-/-	XX
△	-	-/-	XX
△	-	-/-	XX
△	-	-/-	XX
△	-	-/-	XX
△	-	-/-	XX

REVISION DESCRIPTION DATE BY  
 DRAWN: JL  
 CHECKED: TJ  
 DATE: 1/18/2019  
 JOB. NO. 18016

SHEET DOOR & WINDOW SCHEDULE

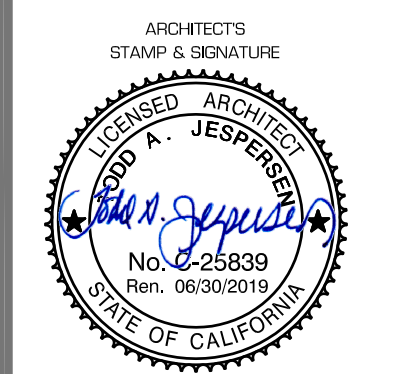SHEET TITLE

A-401

## ROOM FINISH SCHEDULE

ROOM NO.	ROOM NAME	FLOOR			BASE			WAINSCOT				WALLS								CEILING			REMARKS					
		SUB FLOOR	FLOOR MATERIAL	FINISH	COLOR	MATERIAL	FINISH	COLOR	MATERIAL	FINISH	COLOR	HEIGHT	NORTH		EAST		SOUTH		WEST		MATERIAL	FINISH		COLOR	HEIGHT			
													MATERIAL	FINISH	MATERIAL	FINISH	MATERIAL	FINISH	MATERIAL	FINISH						MATERIAL	FINISH	
K-3	LOBBY	F1	F3	-	-	B1	FN1	C2	-	-	-	W1	FN2	P1	W2	FN2	P1	W3	FN1	-	W4	FN2	P1	CL1	-	-	VARIABLES	
K-4A	HALL	F1	F4	FN1	C4	B1	FN1	C2	-	-	-	W1	FN2	P1	W2	FN2	P1	W3	FN2	P1	W4	FN2	P1	CL1	-	-	VARIABLES	
K-4B	HALL	F1	F3	-	-	B1	FN1	C2	-	-	-	W5	FN1	-	W1	FN2	P1	W5	FN1	-	W2	FN2	P1	CL1	-	-	VARIABLES	
K-6	CONFERENCE	F1	F3	-	-	B1	FN1	C2	-	-	-	W2	FN2	P1	W1	FN2	P1	W1	FN2	P1	W1	FN2	P1	CL1	-	-	VARIABLES	
K-14	RECEPTION	F1	F2	FN1	C1	B1	FN1	C2	-	-	-	W2	FN2	P1	W1	FN2	P1	W1	FN2	P1	W2	FN2	P1	CL1	-	-	VARIABLES	

### ROOM FINISH NOTES


- ALL FINISHES SHALL COMPLY WITH CBC CHAPTERS 3, 4, 6, 7, 8, 10 AND 11B AND CFC.
- ALL EXPOSED STEEL FRAMING AND CONNECTORS AT BUILDING INTERIOR SHALL BE PAINTED.
- ALL EXPOSED SPRINKLER PIPING AT BUILDING INTERIOR SHALL BE PAINTED.
- ALL EXPOSED DUCTWORK SHALL BE PAINTED.
- ALL EXPOSED GYPSUM BOARD SHALL RECEIVE A LEVEL 4 FINISH.
- ALL INTERIOR WALL AND CEILING FINISHES SHALL MEET THE FLAMESPREAD AND SMOKE DEVELOPED INDEXES OF CBC TABLE 803.9.
- FURNISH AND INSTALL 4'-0" HIGH 1" STAINLESS STEEL CORNER GUARDS AT ALL OUTSIDE WALL CORNERS WITHIN THE BUILDING.
- CONTRACTOR SHALL BE RESPONSIBLE FOR SHOP DRAWINGS AND PROVIDING AND INSTALLING THE REQUIRED FACILITY INFRASTRUCTURE FOR THE SUPPORT SYSTEM SERVICES ALL EQUIPMENTS. SUPPORT SYSTEMS INCLUDE, BUT NOT LIMITED TO CONDUITS, WIRES AND BOXES, UTILITIES SERVING ALL APPLIANCES. CONTRACTOR SHALL PROVIDE AND INSTALL ALL STRUCTURAL, MECHANICAL, PLUMBING, ELECTRICAL AND OTHER REQUIRED SUPPORT SERVICES NECESSARY TO SUPPORT THE OPERATION OF THE BUILDING COMPONENTS.
- ALL FINISH FLOORING SURFACES SHALL BE FIRM, STABLE, AND SLIP RESISTANT.

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APP. 03-119340 INC.  
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OXNARD UNION HIGH SCHOOL DISTRICT  
HUENEME HIGH SCHOOL  
500 W. BARD RD. OXNARD, CA 93030

SITE SECURITY IMPROVEMENT


MATERIALS LEGEND		MISC COLOR LEGEND	
Subfloor/Flooring	F1 (E) CONCRETE SUBFLOOR	C1 CARPET FLOORING COLOR TO MATCH EXISTING	
	F2 (N) CARPET	C2 RUBBER BASE COLOR TO MATCH EXISTING	
	F3 (E) VCT	C3 "TECTUM" ACOUSTIC CEILING PANEL COLOR TO BE DETERMINED	
	F4 (N) VCT	C4 VCT FLOORING COLOR TO MATCH EXISTING	
Base	B1 (N) 4" RUBBER BASE		
Walls	W1 (E) GYP. BRD.	<b>PAINT COLOR LEGEND</b>	
	W2 (N) GYP. BRD.	<span style="border: 1px solid black; border-radius: 50%; padding: 2px;">P1</span> DUNN EDWARDS, PAINT COLOR: T.B.D. (WALLS & CEILINGS)	
	W3 (N) CERAMIC TILE	<span style="border: 1px solid black; border-radius: 50%; padding: 2px;">P2</span> DUNN EDWARDS, PAINT COLOR: T.B.D. (INTERIOR DOOR FRAMES)	
	W4 (N) FIBERGLASS REINFORCED PLASTIC (FRP) PANELS	<span style="border: 1px solid black; border-radius: 50%; padding: 2px;">P3</span> DUNN EDWARDS, PAINT COLOR: T.B.D. (EXTERIOR DOOR FRAMES)	
	W5 (N) SECURITY STOREFRONT		
Ceilings	CL1 (E) ACOUSTICAL PANELS		
	CL2 (N) ACOUSTICAL PANELS		
	CL3 (E) GYP. BRD. CEILING		
Finish	FN1 FACTORY FINISH	<b>KEYNOTES</b>	
	FN2 PAINT	<span style="border: 1px solid black; border-radius: 50%; padding: 2px;">1</span> NOT USED	
		<b>GENERAL NOTES</b>	
		<ol style="list-style-type: none"> <li>DIRECTIONAL LOCATIONS INDICATED ON ROOM FINISH SCHEDULES ARE ORIENTATED ACCORDING TO TRUE NORTH AS SHOWN ON PLAN</li> <li>ALL WALLS TO BE PAINTED P1 U.N.O.</li> <li>ALL DOOR FRAMES TO BE PAINTED PAINT SYSTEM P28J. SEE DOOR SCHEDULE FOR COLORS.</li> <li>ALL METAL DOORS TO BE PAINTED PAINT SYSTEM P28B. SEE DOOR SCHEDULE FOR COLORS.</li> <li>PROVIDE TRANSITIONS AT ALL FLOORING MATERIAL CHANGES - REF DETAILS THIS SHEET.</li> <li>ALL MATERIALS TO MEET CBC TABLE 8A FOR FRAME SPREAD.</li> <li>INTERIOR WALL AND CEILING FINISHES SHALL BE CLASSIFIED FOR FIRE PERFORMANCE AND SMOKE DEVELOPMENT PER 2016 CALIFORNIA BUILDING CODE, SEC. 803.</li> <li>INTERIOR WALL AND CEILING FINISHES SHALL BE CLASSIFIED BY OCCUPANCY PER TABLE 803.9 OR BE TESTED PER SEC. 803.12 (NFPA 286 CRITERIA) OF 2016 CALIFORNIA BUILDING CODE.</li> <li>TEXTILE WALL AND VINYL COVERINGS SHALL BE TESTED PER SEC. 803.1.3 ACCEPTANCE CRITERIA OF NFPA 265 OR PER SEC. 803.1.4 ACCEPTANCE CRITERIA TESTED TO ASTM E84 OR UL 723 CLASS A FLAME SPREAD INDEX AND HAVE AFSS PER SEC. 903.1.1 OR 903.1.1.2, 2010 CALIFORNIA BUILDING CODE.                     <ol style="list-style-type: none"> <li>EXCEPTION: 803.2 MATERIALS LESS THAN 0.036" THICK APPLIED DIRECTLY NEED NOT BE TESTED.</li> <li>PER SEC. 803.5, TEXTILE WALL COVERINGS, INCLUDING CARPET, SHALL BE TESTED USING PRODUCT MOUNTING SYSTEM INCLUDING ADHESIVE.</li> <li>PER SEC. 803.6, TEXTILE CEILING COVERINGS SHALL BE TESTED USING PRODUCT MOUNTING SYSTEM INCLUDING ADHESIVE.</li> <li>PER SEC. 803.7, EXPANDED VINYL WALL COVERINGS SHALL BE TESTED USING PRODUCT MOUNTING SYSTEM INCLUDING ADHESIVE.</li> <li>PER SEC. 803.8, EXPANDED VINYL CEILING COVERINGS SHALL BE TESTED USING PRODUCT MOUNTING SYSTEM INCLUDING ADHESIVE.</li> <li>PER SEC. 803.8.10, STABILITY - INTERIOR FINISH MATERIALS WILL NOT BECOME READILY DETACHED WHERE SUBJECTED TO ROOM TEMP. OF 200 DEG. F FOR 30 MIN.</li> </ol> </li> <li>DECORATIVE TRIM &amp; MATERIALS SHALL COMPLY WITH 2016 CALIFORNIA BUILDING CODE.</li> <li>THERMAL AND ACOUSTICAL INSULATION SHALL COMPLY WITH SEC. 719, 2010 CALIFORNIA BUILDING CODE.</li> </ol>	

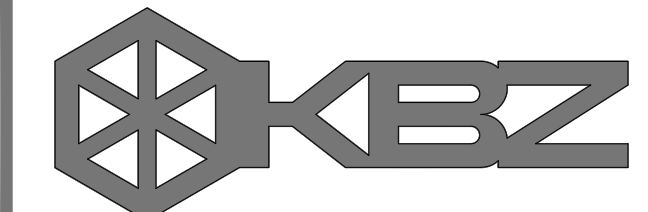

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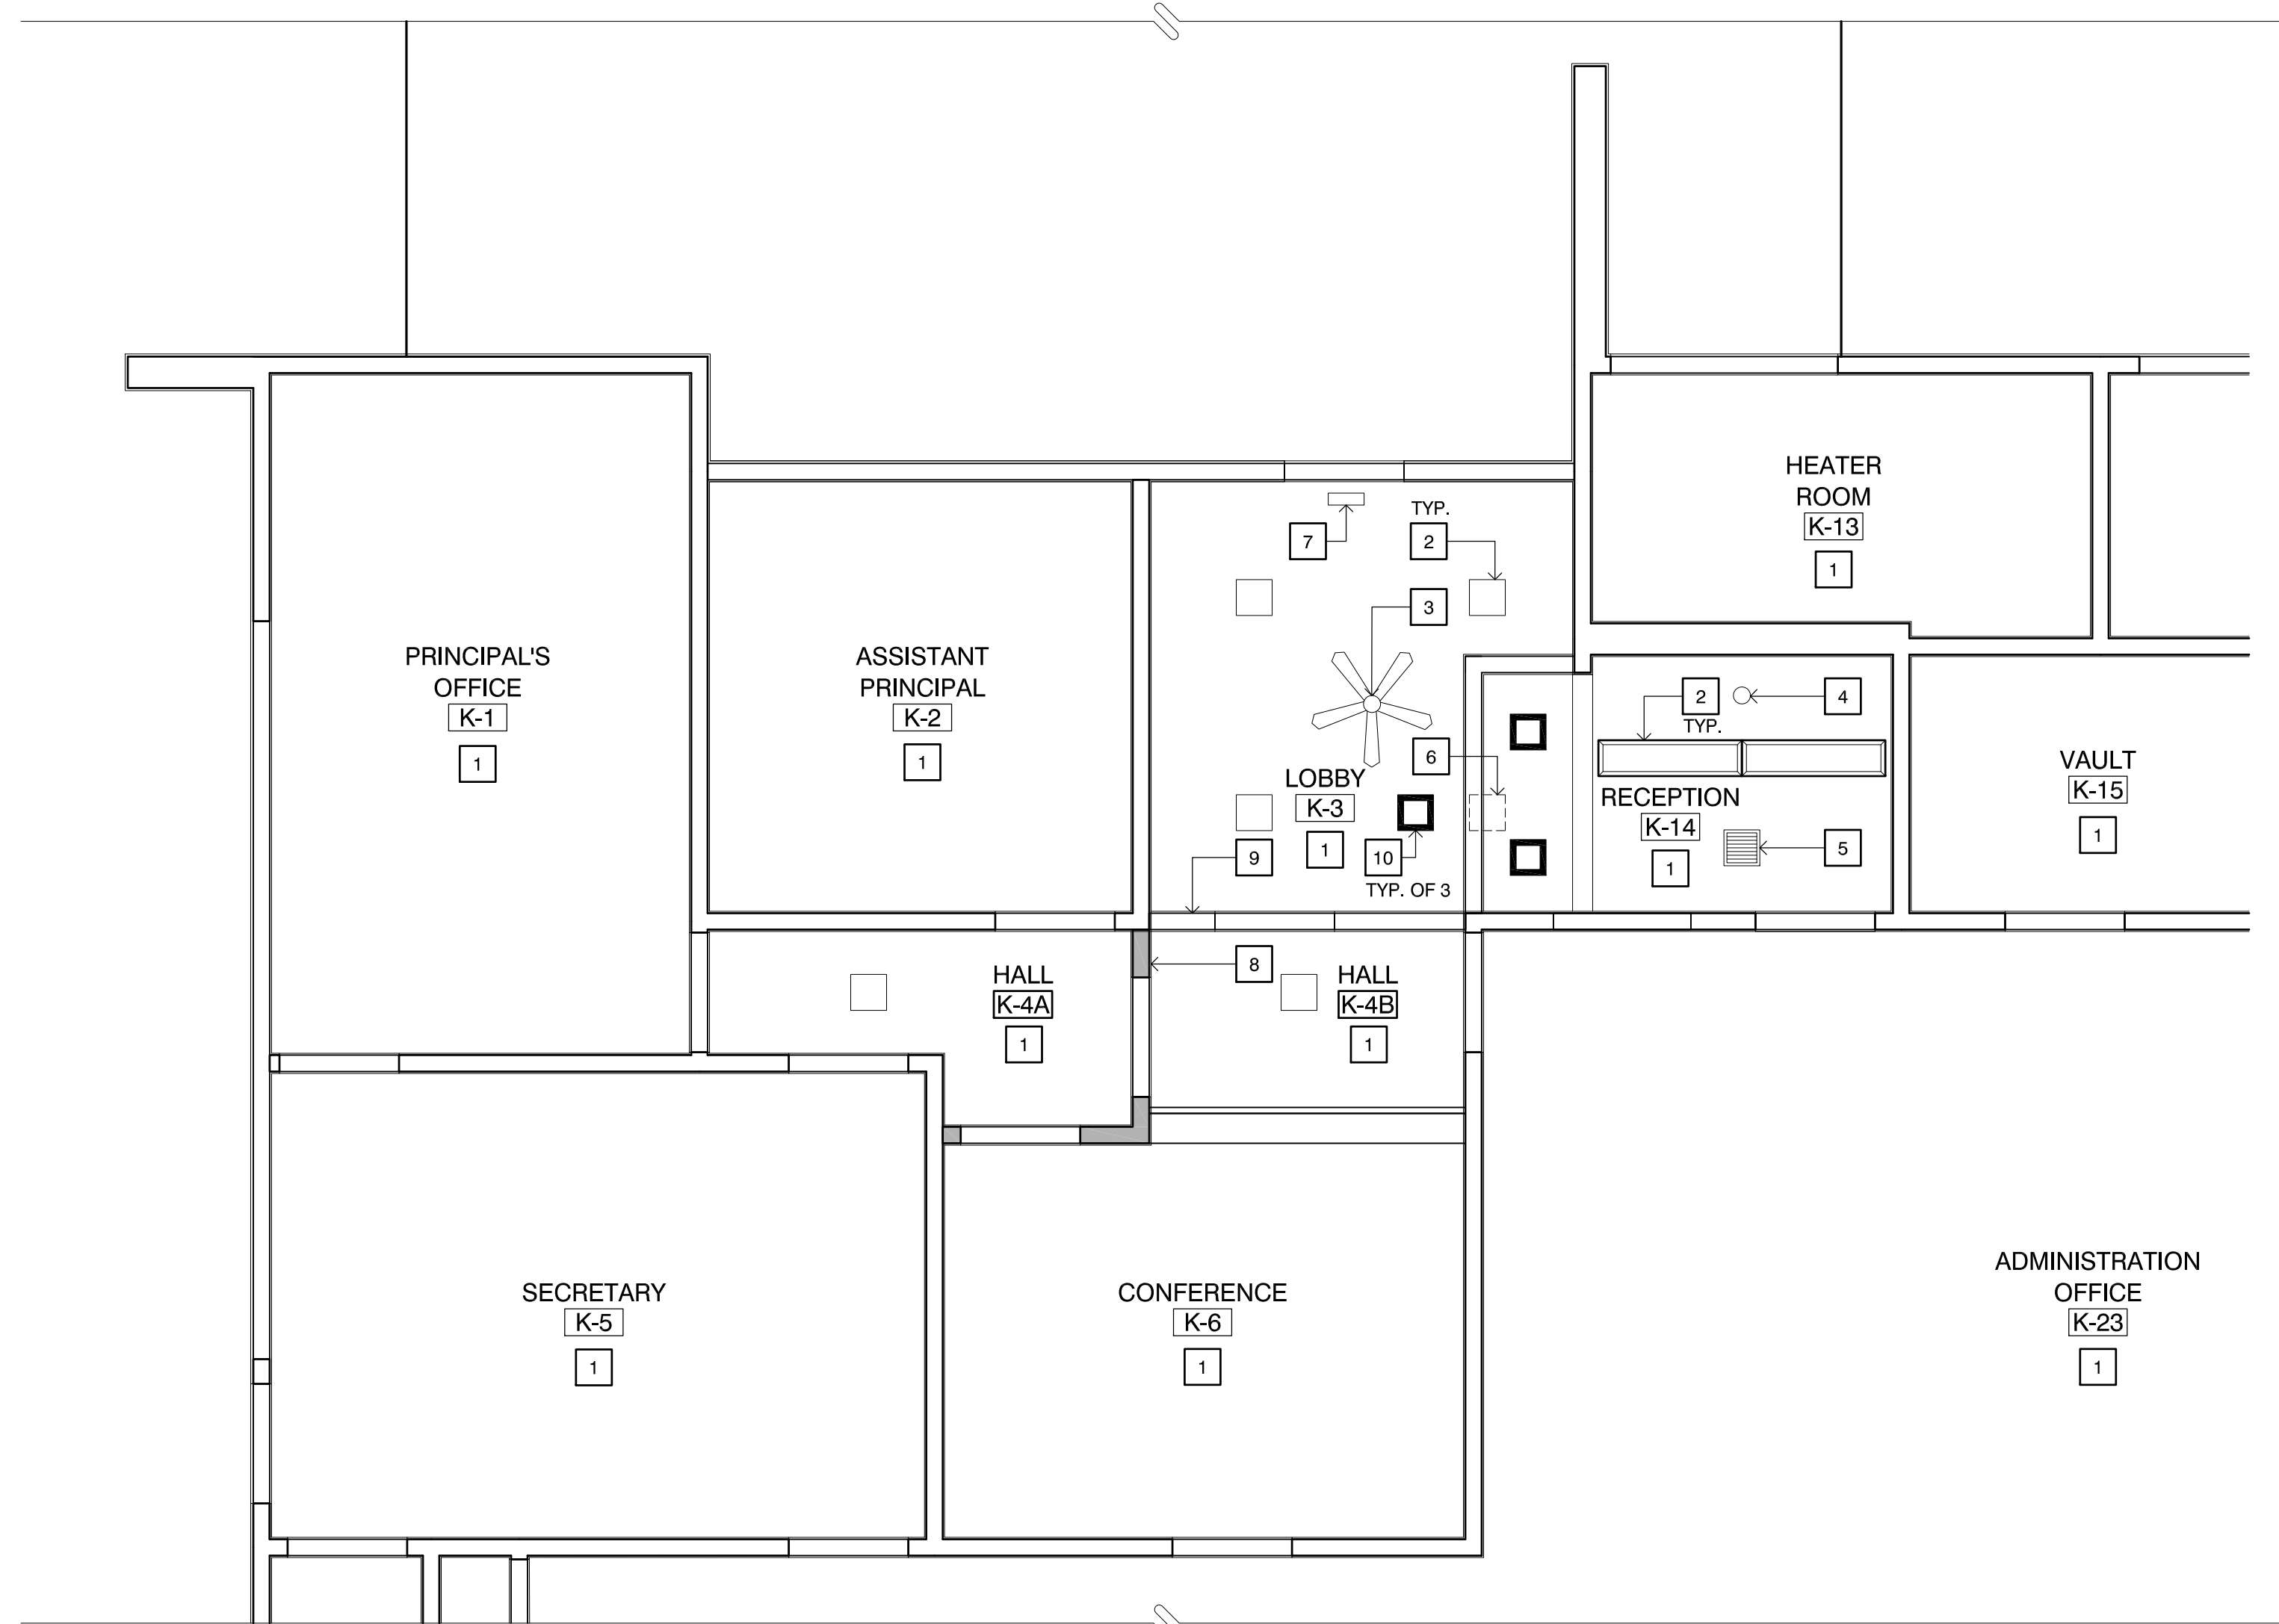
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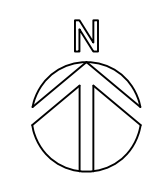
DRAWN: JL  
CHECKED: TJ  
DATE: 1/18/2019  
JOB NO.: 18016

SHEET TITLE: ROOM FINISH SCHEDULE

SHEET

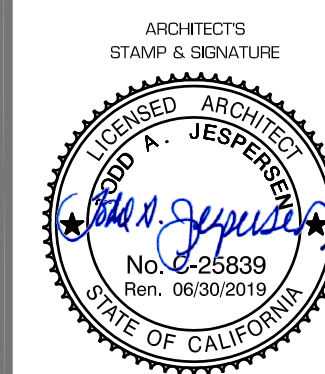

**1 REFLECTED CEILING PLAN**  
SCALE: 1/4" = 1'-0"



**CEILING PLAN KEYNOTES**

- 1 (E) CEILING TO REMAIN
- 2 (E) LIGHT FIXTURE TO REMAIN
- 3 (E) CEILING FAN TO REMAIN
- 4 (E) SMOKE DETECTOR TO REMAIN
- 5 (E) GRILLE TO REMAIN
- 6 REMOVE (E) LIGHT FIXTURE, PATCH CEILING TO MATCH (E)
- 7 (E) EXIT SIGN TO REMAIN
- 8 (N) WALL - FROM FLOOR TO CEILING
- 9 (N) SECURITY STOREFRONT
- 10 (N) LIGHT FIXTURE: LITHONIA WF6-SQ-S-LED-3500K-MW WITH WFJBU HANGER & WFEX CABLE AS REQUIRED

**LEGEND**

(N) WALL, MATCH (E) ADJACENT FINISHES

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APP. 03-119340 INC.  
REVIEWED FOR  
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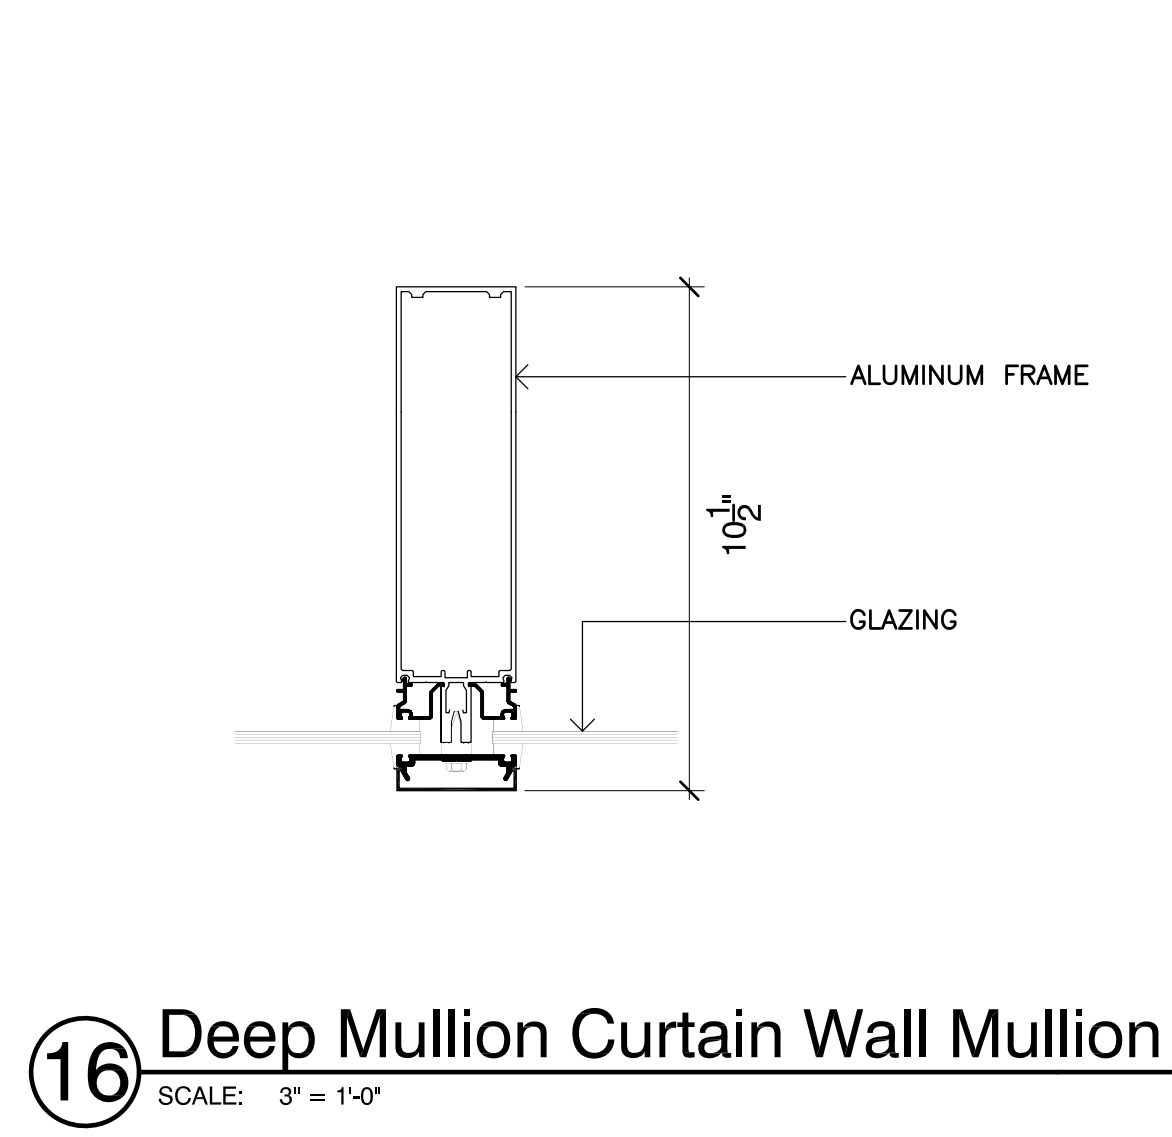
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REVISION	DESCRIPTION	DATE	BY
DRAWN	JL		
CHECKED	TJ		
DATE		1/16/2019	
JOB. NO.		18016	


SHEET REFLECTED CEILING PLAN  
TITLE

SHEET  
TITLE  
**A-600**







16 Deep Mullion Curtain Wall Mullion  
SCALE: 3" = 1'-0"

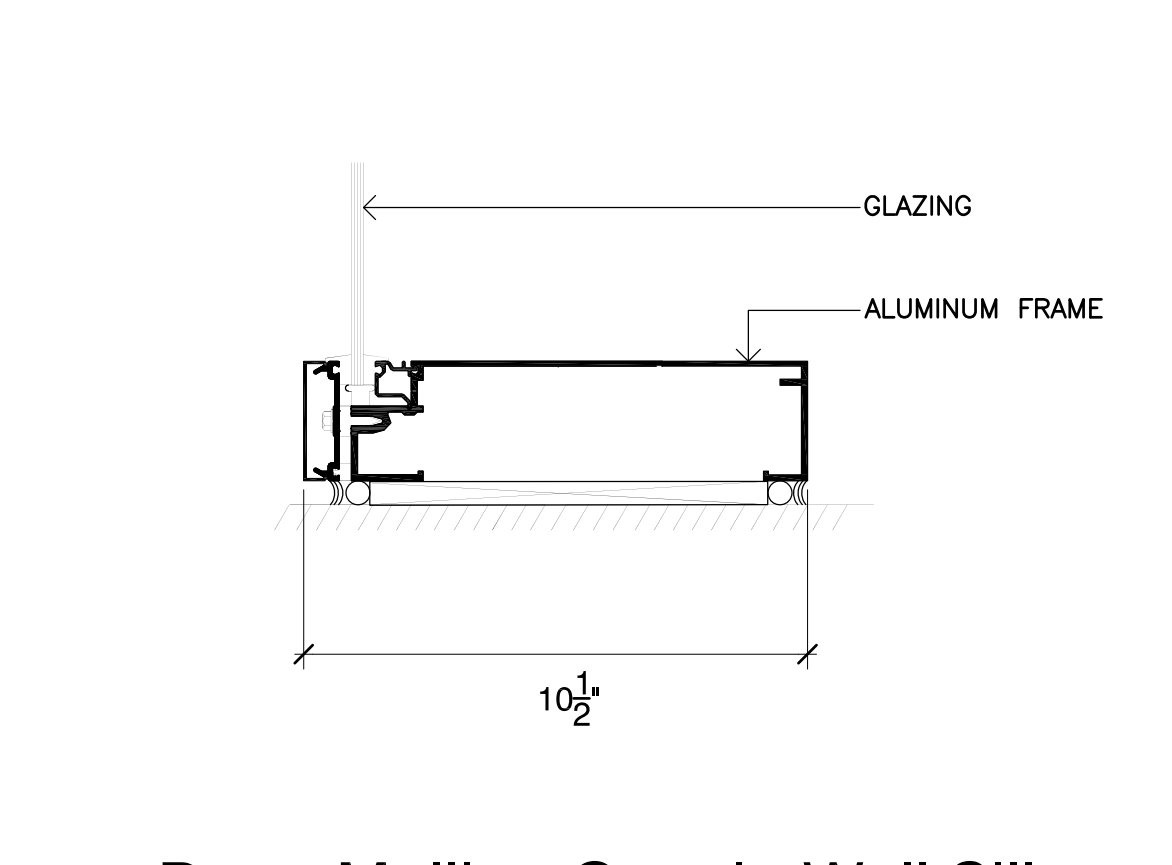


17 Deep Mullion Curtain Wall Sill  
SCALE: 3" = 1'-0"

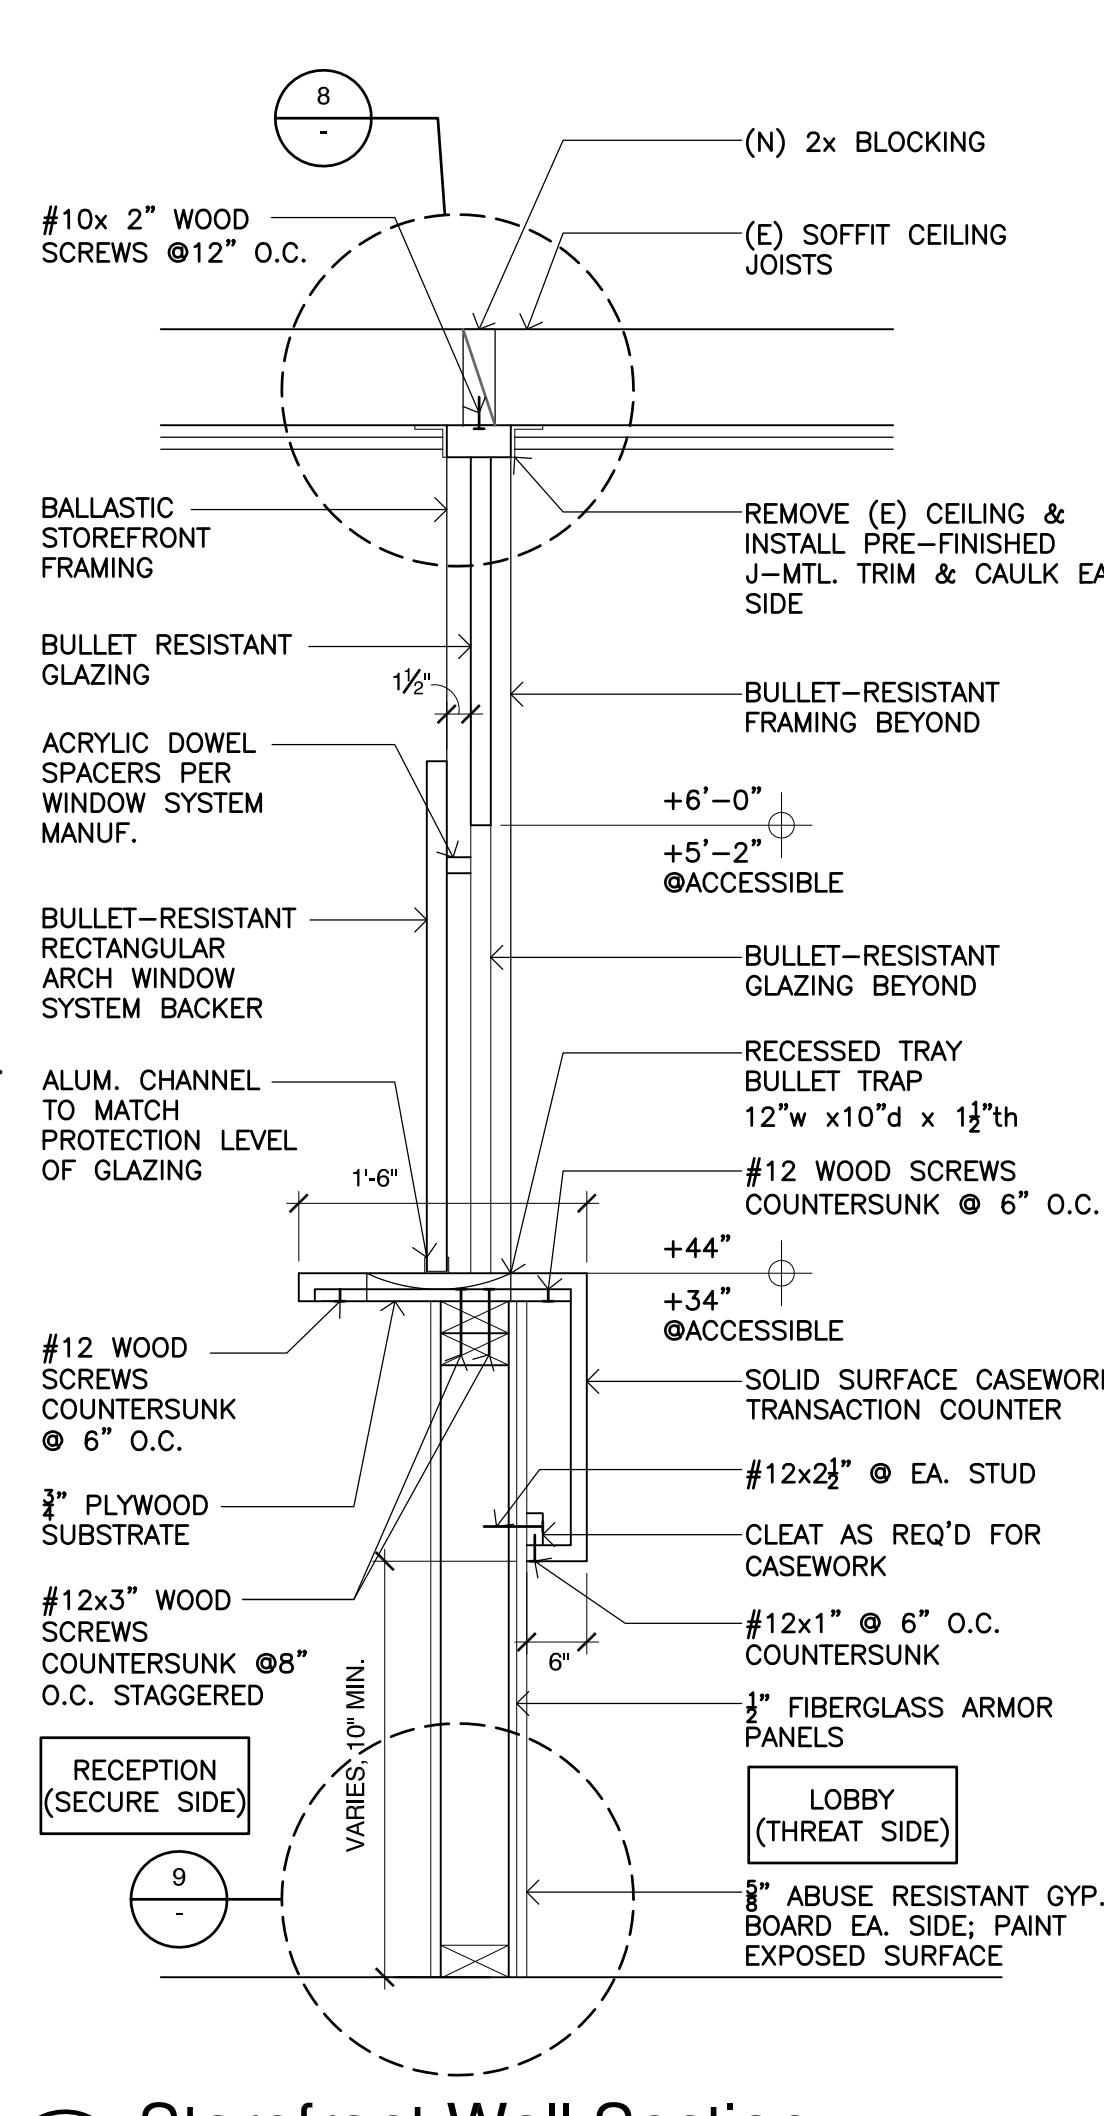


12 Storefront Wall Section  
SCALE: 1" = 1' - 0"

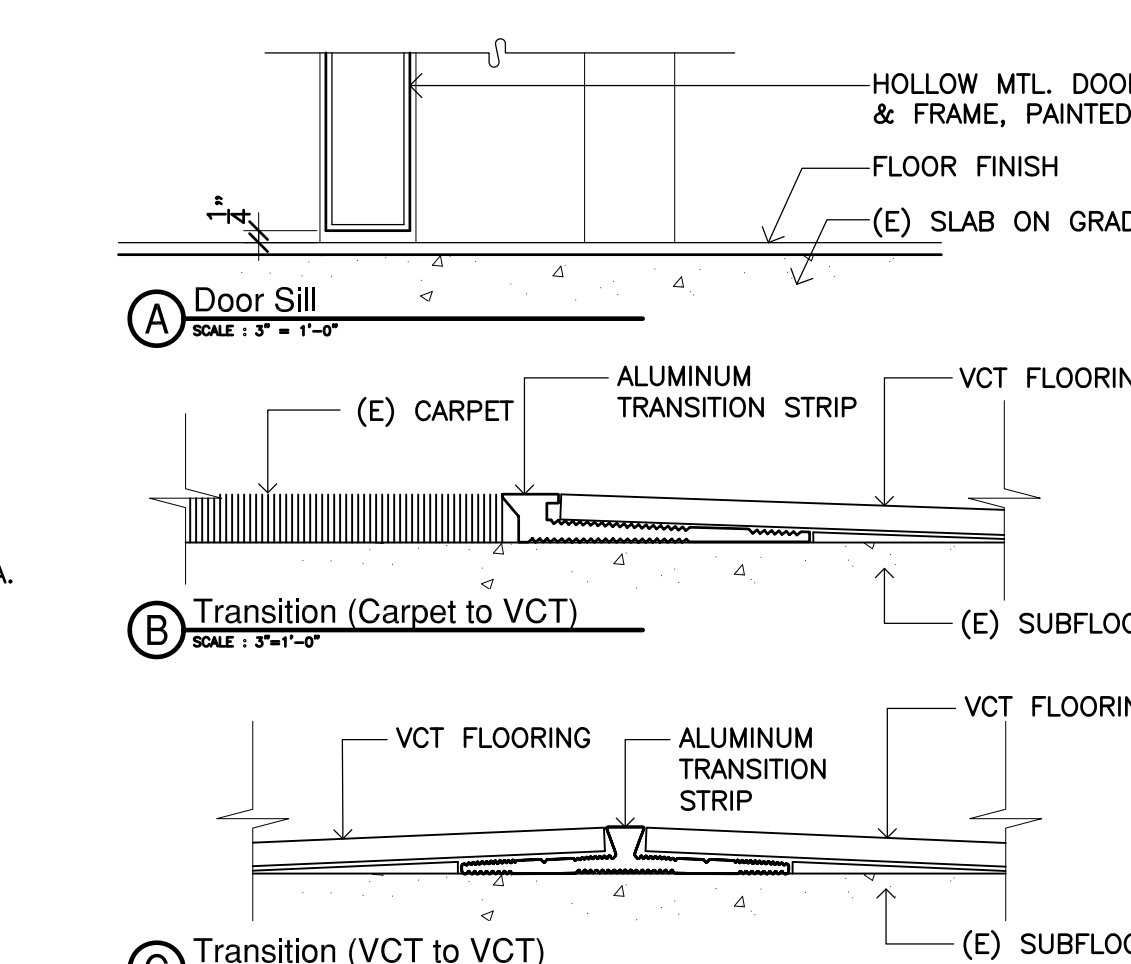


7 Door Sill & Transition Strip  
SCALE: 3" = 1'-0"

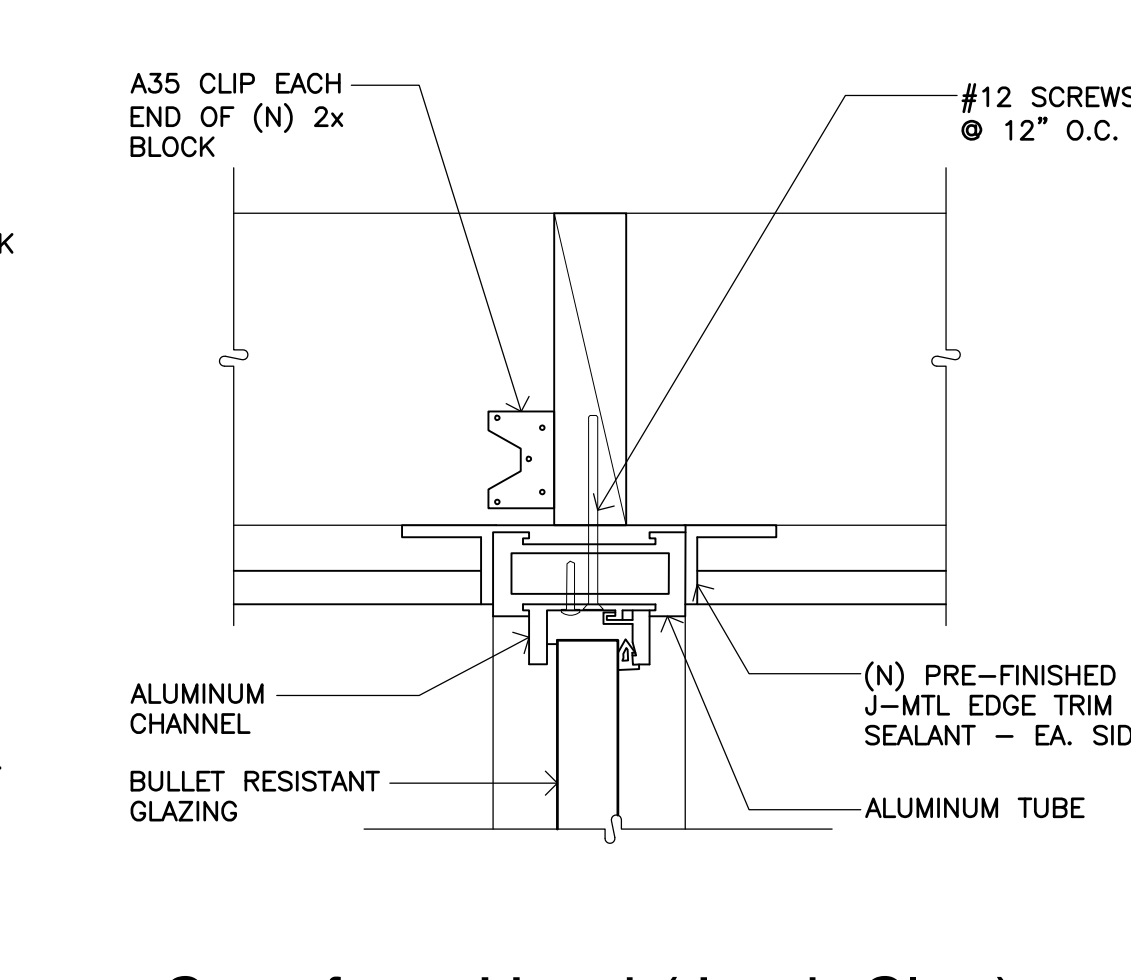


8 Storefront Head (Jamb Sim.)  
SCALE: 3" = 1'-0"

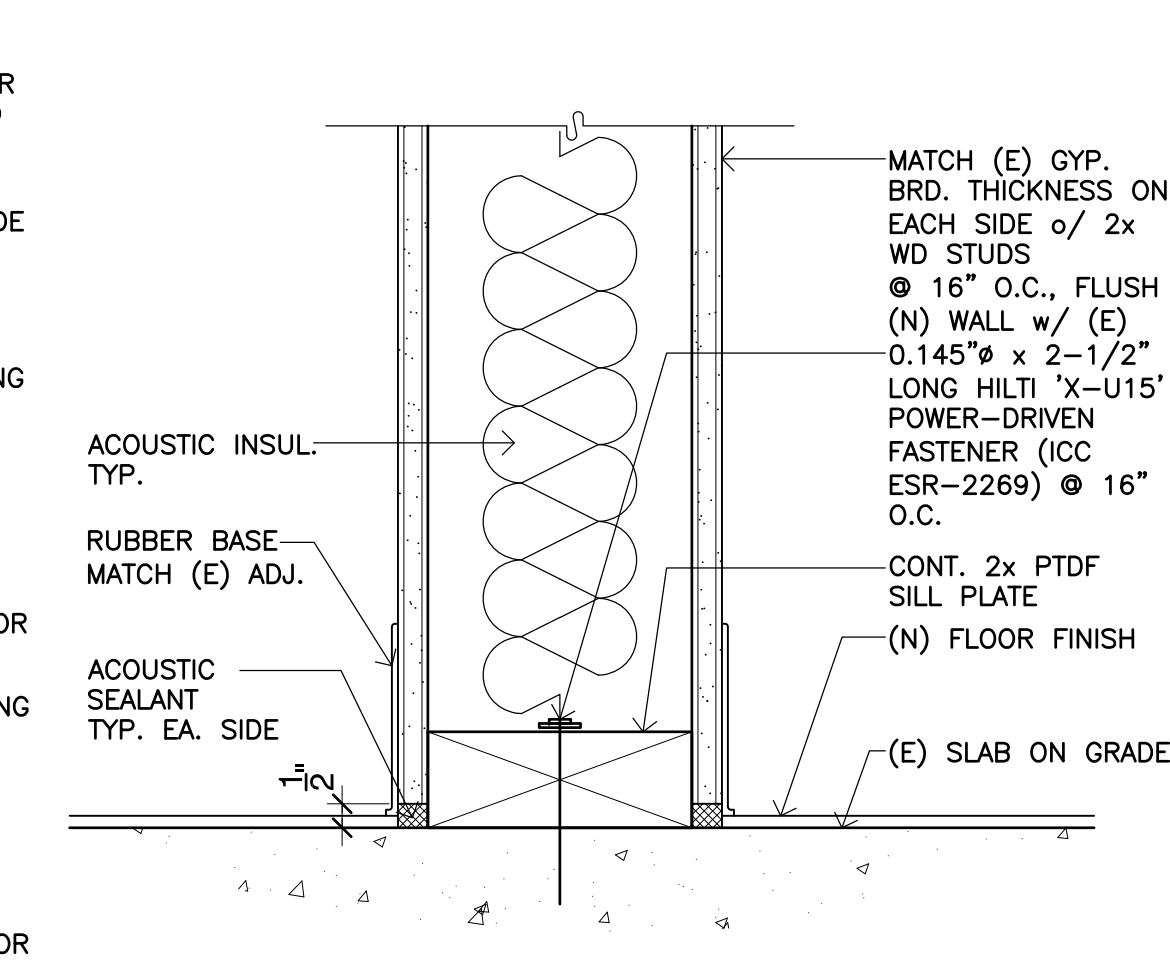


2 Non-bearing Interior Wall to Conc.  
SCALE: 3" = 1'-0"

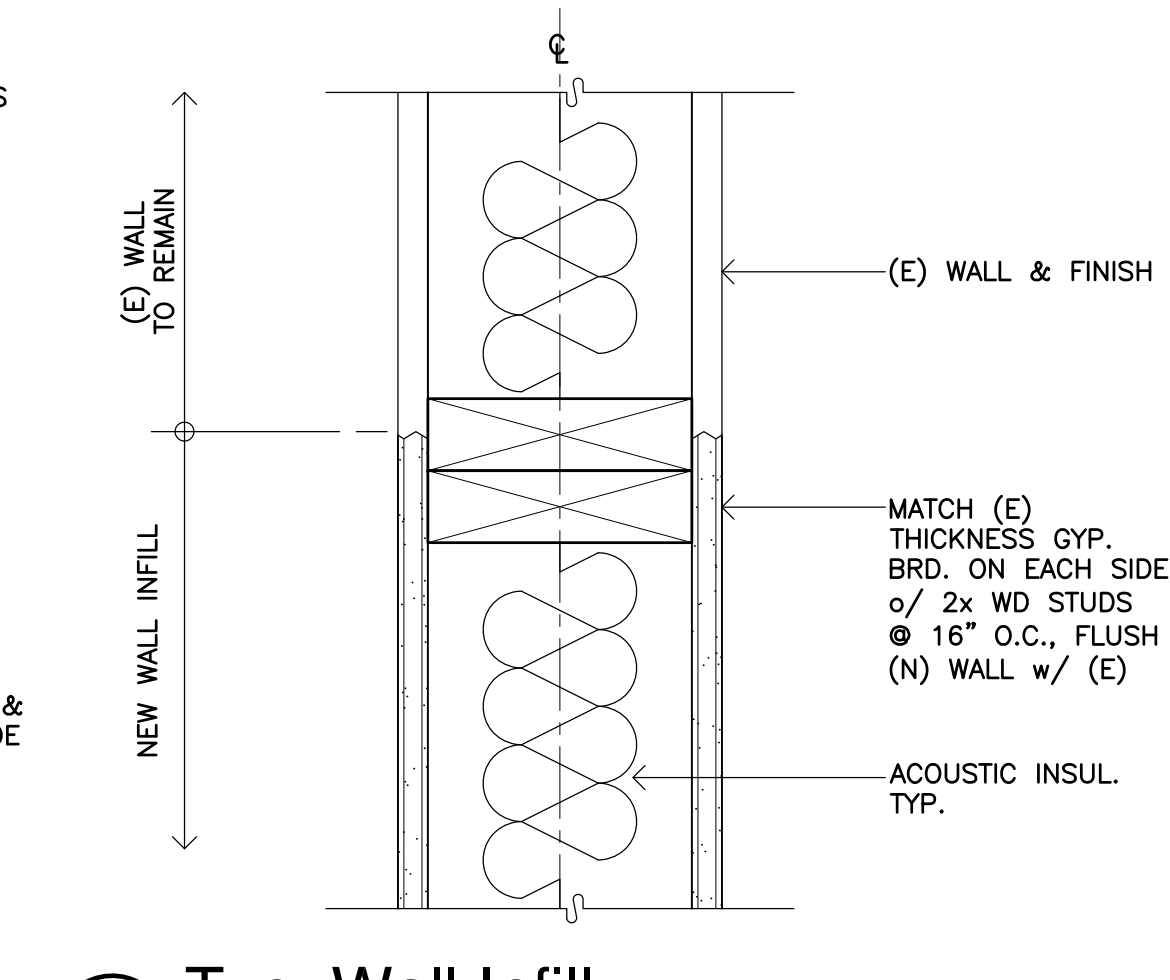

3 Typ. Wall Infill  
SCALE: 3" = 1'-0"

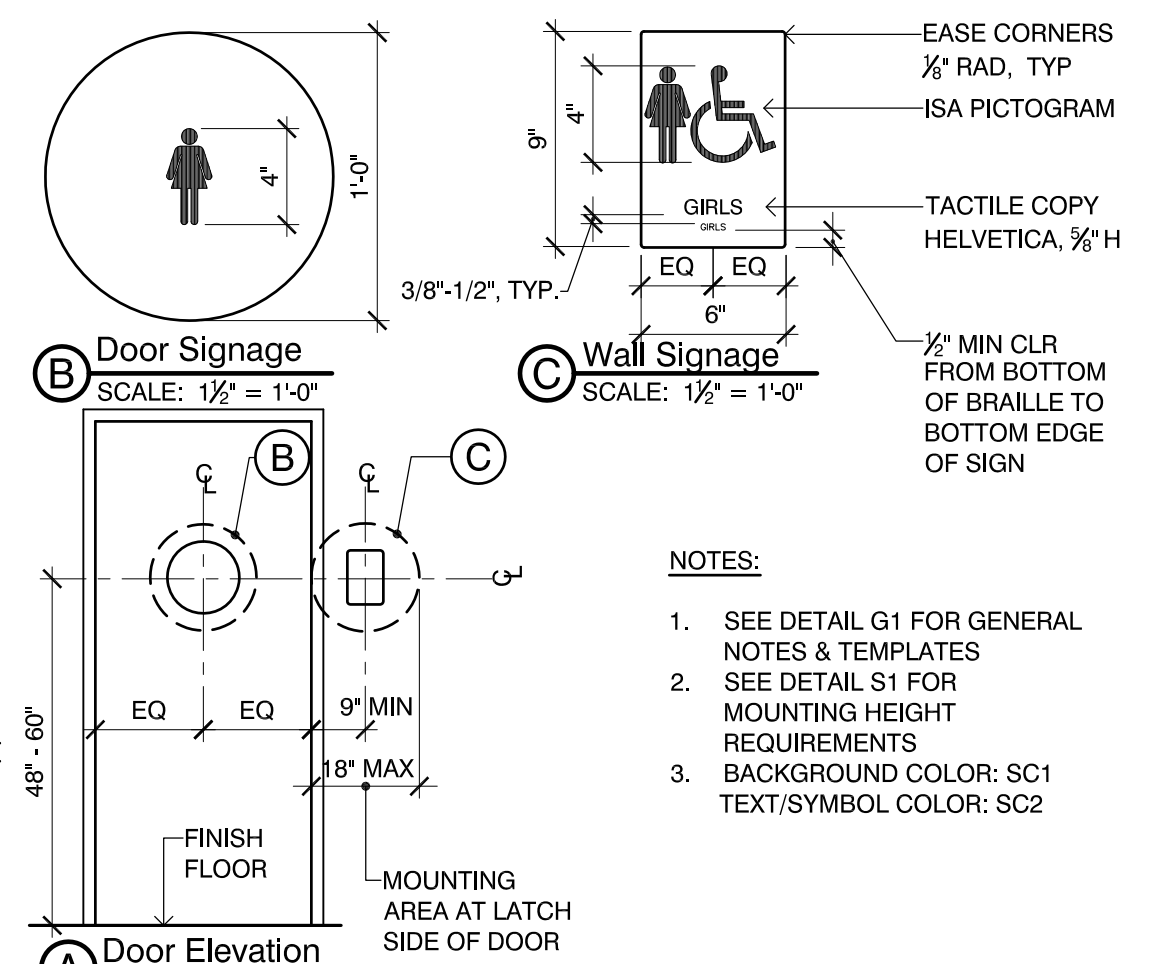

S2 Girls Restroom Signage  
SCALE: AS NOTED

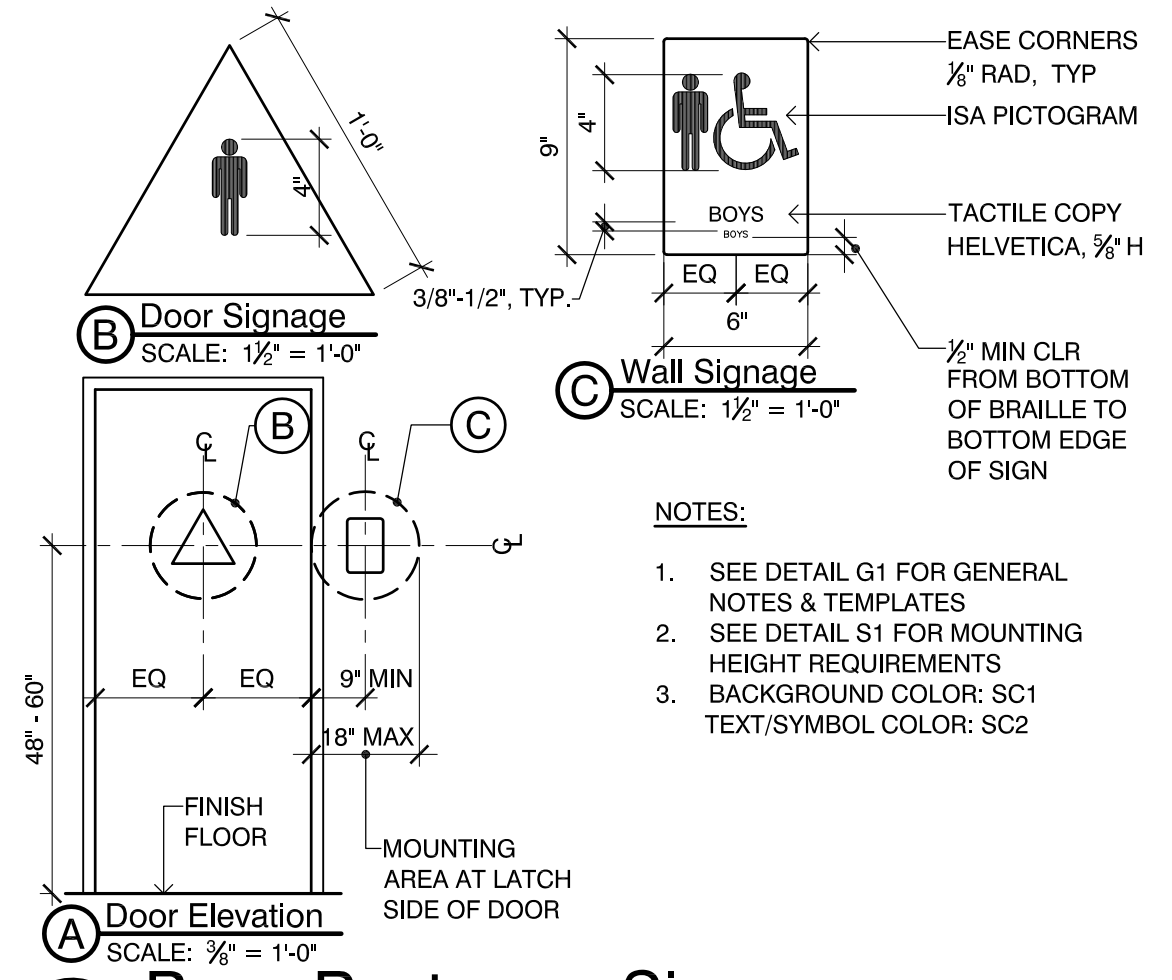

S3 Boys Restroom Signage  
SCALE: AS NOTED

- A. RAISED CHARACTERS PER CBC 11B-703.2**
- DEPTH: RAISED CHARACTERS SHALL BE 1/2" MINIMUM ABOVE THEIR BACKGROUND.
  - CASE: CHARACTERS SHALL BE UPPERCASE.
  - STYLE: CHARACTERS SHALL BE SANS SERIF. CHARACTERS SHALL NOT BE ITALIC, OBLIQUE, SCRIPT, HIGHLY DECORATIVE, OR OF OTHER UNUSUAL FORMS.
  - CHARACTER PROPORTIONS: CHARACTERS SHALL BE SELECTED FROM FONTS WHERE THE WIDTH OF THE UPPERCASE LETTER 'O' IS 60% MINIMUM AND 110% MAXIMUM OF THE HEIGHT OF THE UPPERCASE LETTER 'T'.
  - CHARACTER HEIGHT: CHARACTER HEIGHT MEASURED VERTICALLY FROM THE BASELINE OF THE CHARACTER SHALL BE 1/2" MINIMUM AND 2" MAXIMUM BASED ON THE HEIGHT OF THE UPPERCASE LETTER 'T'.
  - STROKE THICKNESS: STROKE THICKNESS OF THE UPPERCASE LETTER 'I' SHALL BE 15% MAXIMUM OF THE HEIGHT OF THE CHARACTER.
  - CHARACTER SPACING: CHARACTER SPACING SHALL BE MEASURED BETWEEN THE TWO CLOSEST POINTS OF ADJACENT RAISED CHARACTERS WITHIN A MESSAGE, EXCLUDING WORD SPACES. WHERE CHARACTERS HAVE RECTANGULAR CROSS SECTIONS, SPACING BETWEEN INDIVIDUAL RAISED CHARACTERS SHALL BE 1/2" MINIMUM AND 4 TIMES THE RAISED CHARACTER STROKE WIDTH MAXIMUM WHERE CHARACTERS HAVE OTHER CROSS SECTIONS. SPACING BETWEEN INDIVIDUAL RAISED CHARACTERS SHALL BE 1/2" MIN AND 4 TIMES THE RAISED CHARACTER STROKE WIDTH MAX AT THE BASE OF THE CROSS SECTIONS, AND 1/2" MINIMUM AND 4 TIMES THE RAISED CHARACTER STROKE WIDTH MAXIMUM AT THE TOP OF THE CROSS SECTIONS. CHARACTERS SHALL BE SEPARATED FROM RAISED BORDERS AND DECORATIVE ELEMENTS 1/2" MIN.
  - LINE SPACING: SPACING BETWEEN THE BASELINES OF SEPARATE LINES OF RAISED CHARACTERS WITHIN A MESSAGE SHALL BE 135% MINIMUM AND 170% MAXIMUM OF THE RAISED CHARACTER HEIGHT.
  - FORMAT: TEXT SHALL BE IN A HORIZONTAL FORMAT.

- B. BRAILLE: CONTRACTED (GRADE 2) PER 11B-703.3 & 11B-703.4**
- DIMENSIONS AND CAPITALIZATION: BRAILLE DOTS SHALL HAVE A DOMED OR ROUNDED SHAPE AND SHALL COMPLY WITH TABLE 11B-703.3.1. THE INDICATION OF AN UPPERCASE LETTER OR LETTERS SHALL ONLY BE USED BEFORE THE FIRST WORD OF SENTENCES, PROPER NOUNS AND NAMES, INDIVIDUAL LETTERS OF THE ALPHABET, INITIALS, AND ACRONYMS.
  - POSITION: BRAILLE SHALL BE POSITIONED BELOW THE CORRESPONDING TEXT IN A HORIZONTAL FORMAT, FLUSH LEFT OR CENTERED. IF TEXT IS MULTI-LINED, BRAILLE SHALL BE PLACED BELOW THE ENTIRE TEXT. BRAILLE SHALL BE SEPARATED 1/2" MINIMUM AND 1/2" MAXIMUM FROM ANY OTHER TACTILE CHARACTERS AND 1/2" MIN FROM RAISED BORDERS AND DECORATIVE ELEMENTS. EXCEPTION: BRAILLE PROVIDED ON ELEVATOR CAR CONTROLS SHALL BE SEPARATED BY 1/2" MINIMUM AND SHALL BE LOCATED EITHER DIRECTLY BELOW THE CORRESPONDING RAISED CHARACTERS OR SYMBOLS.
- C. VISUAL CHARACTERS PER CBC 11B-703.5**
- SHALL COMPLY WITH CBC 11B-703.2 & 11B-703.3
  - FINISH & CONTRAST: CHARACTERS AND THEIR BACKGROUND SHALL HAVE A NON-GLARE FINISH. CHARACTERS SHALL CONTRAST WITH THEIR BACKGROUND WITH EITHER LIGHT CHARACTERS ON A DARK BACKGROUND OR DARK CHARACTERS ON A LIGHT BACKGROUND.
  - STROKE THICKNESS: STROKE THICKNESS OF THE UPPERCASE LETTER 'I' SHALL BE 10% MINIMUM AND 20% MAXIMUM OF THE HEIGHT OF THE CHARACTER.





MEASUREMENT RANGE      MINIMUM IN INCHES  
MAXIMUM IN INCHES

MEASUREMENT RANGE	MINIMUM IN INCHES MAXIMUM IN INCHES
DOT BASE DIAMETER	0.059 to 0.063
DISTANCE BETWEEN TWO DOTS IN THE SAME CELL	0.100
DISTANCE BETWEEN CORRESPONDING DOTS IN ADJACENT CELLS	0.300
DOT HEIGHT	0.025 to 0.037
DISTANCE BETWEEN CORRESPONDING DOTS FROM ONE CELL DIRECTLY BELOW	0.395 to 0.400




**B. NOT USED**


MEASUREMENT RANGE	MINIMUM IN INCHES MAXIMUM IN INCHES
DOT BASE DIAMETER	0.059 to 0.063
DISTANCE BETWEEN TWO DOTS IN THE SAME CELL	0.100
DISTANCE BETWEEN CORRESPONDING DOTS IN ADJACENT CELLS	0.300
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DISTANCE BETWEEN CORRESPONDING DOTS FROM ONE CELL DIRECTLY BELOW	0.395 to 0.400

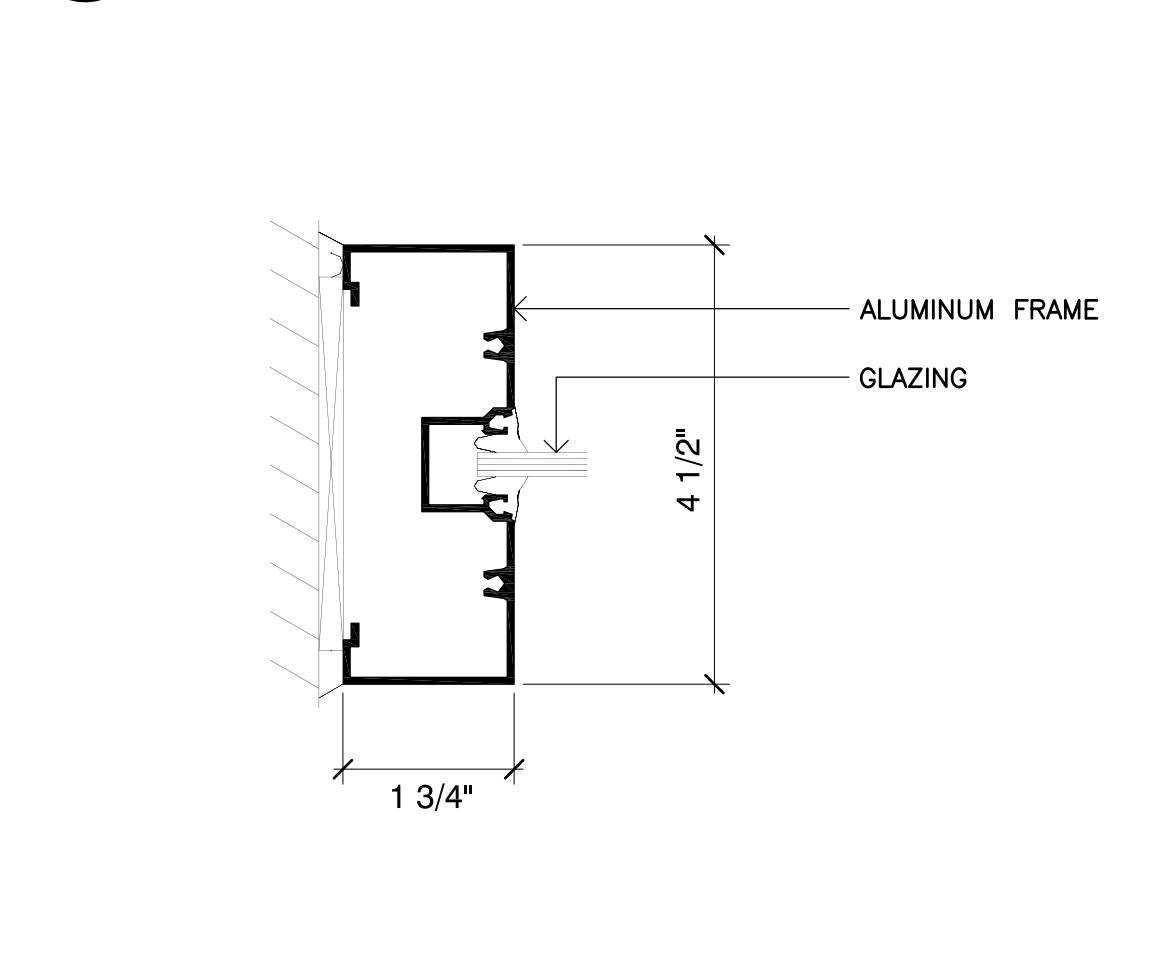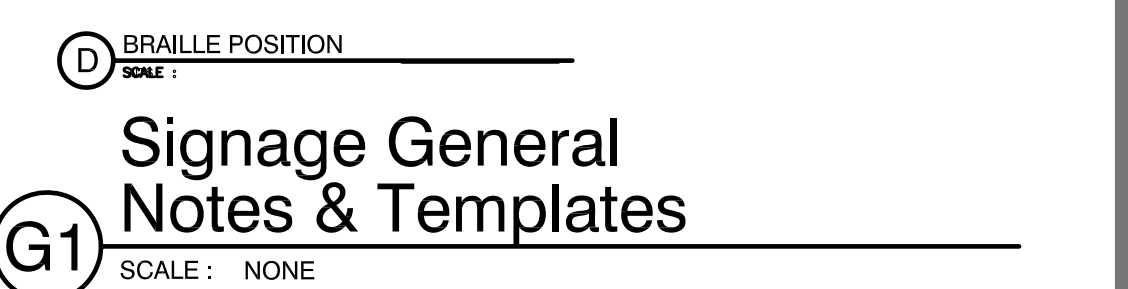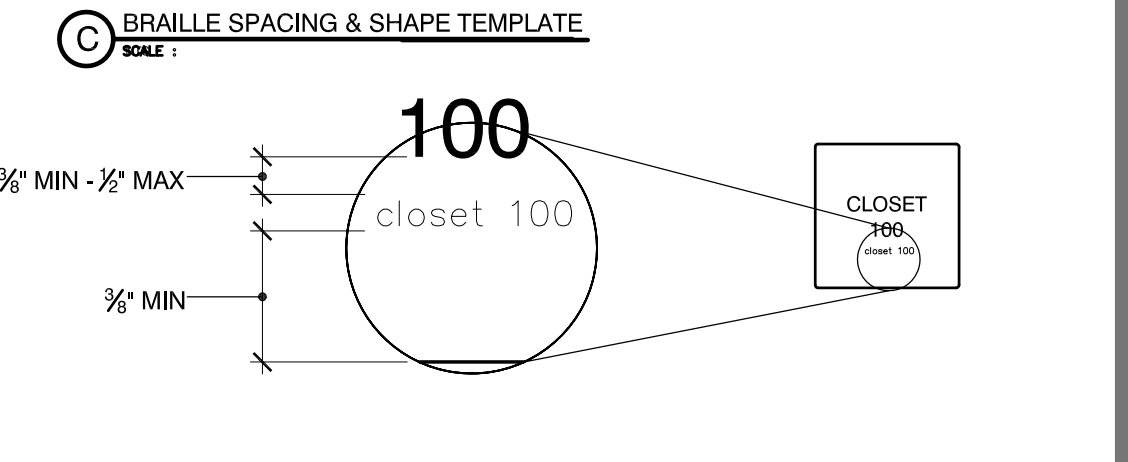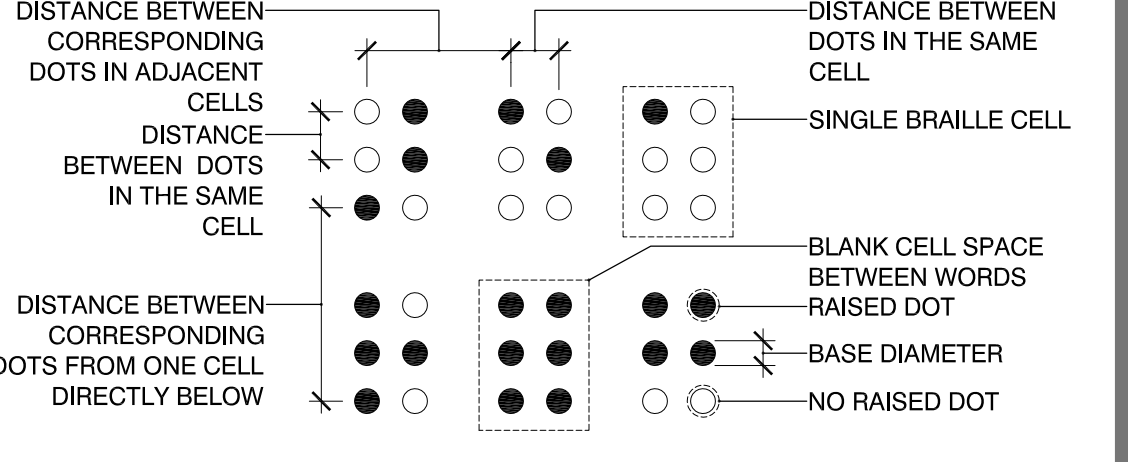


18 Fixed Storefront  
SCALE: 6" = 1'-0"

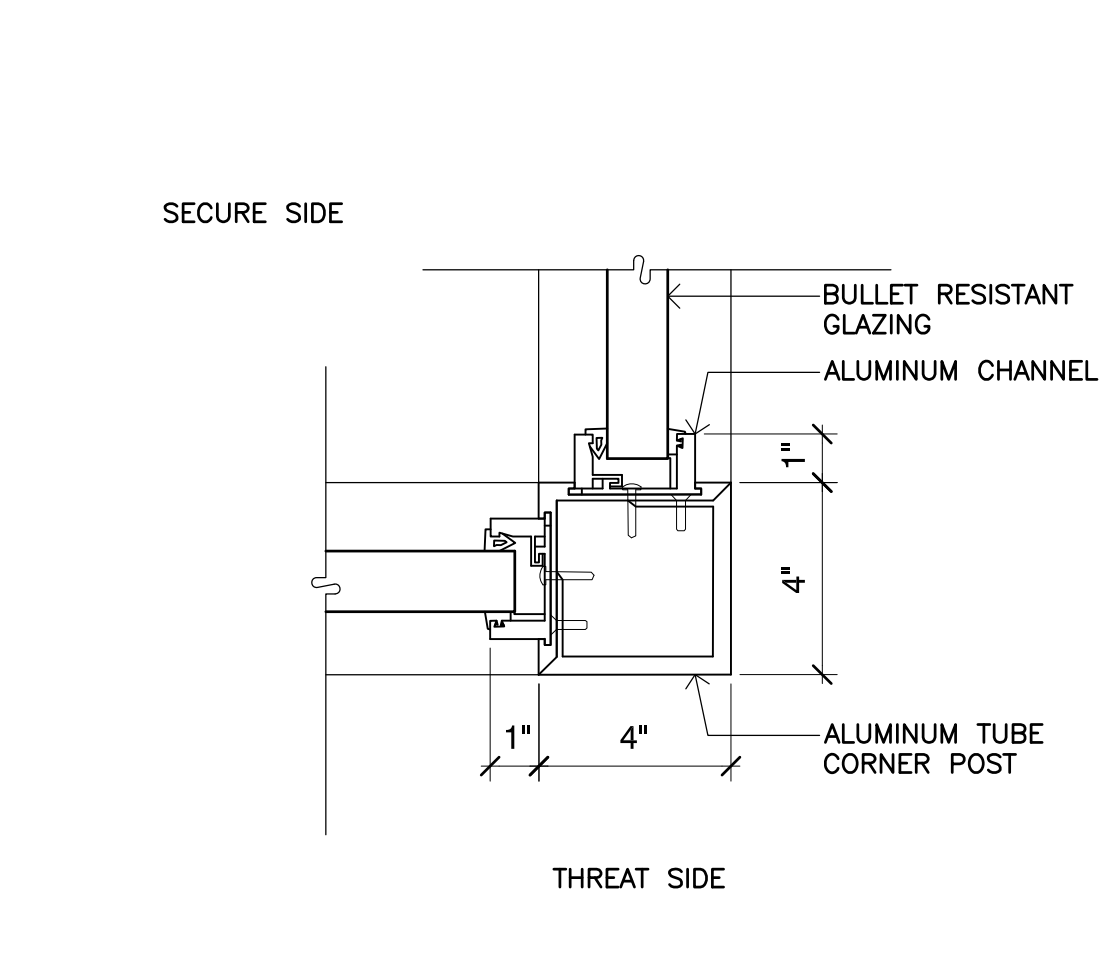


13 Storefront Corner  
SCALE: 3" = 1'-0"

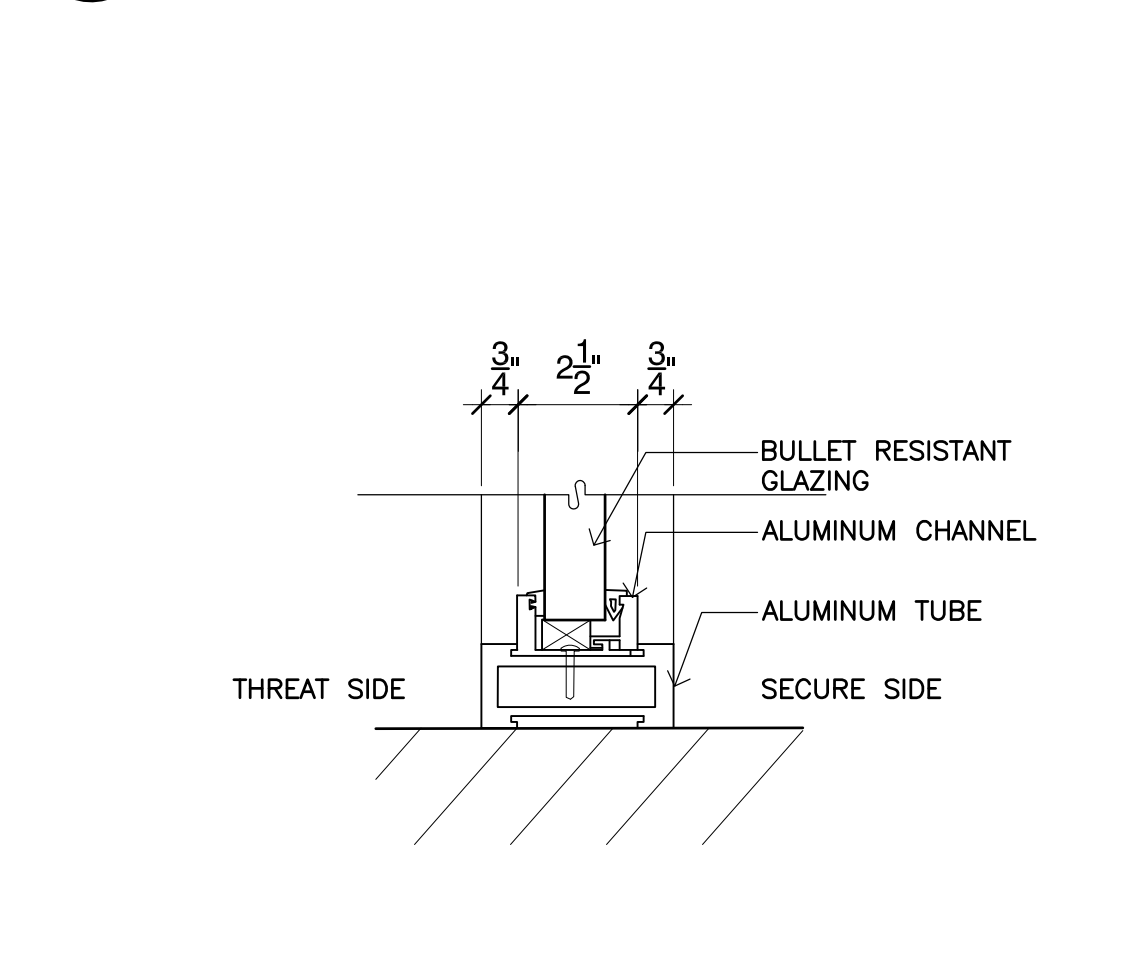





9 Storefront Sill  
SCALE: 3" = 1'-0"

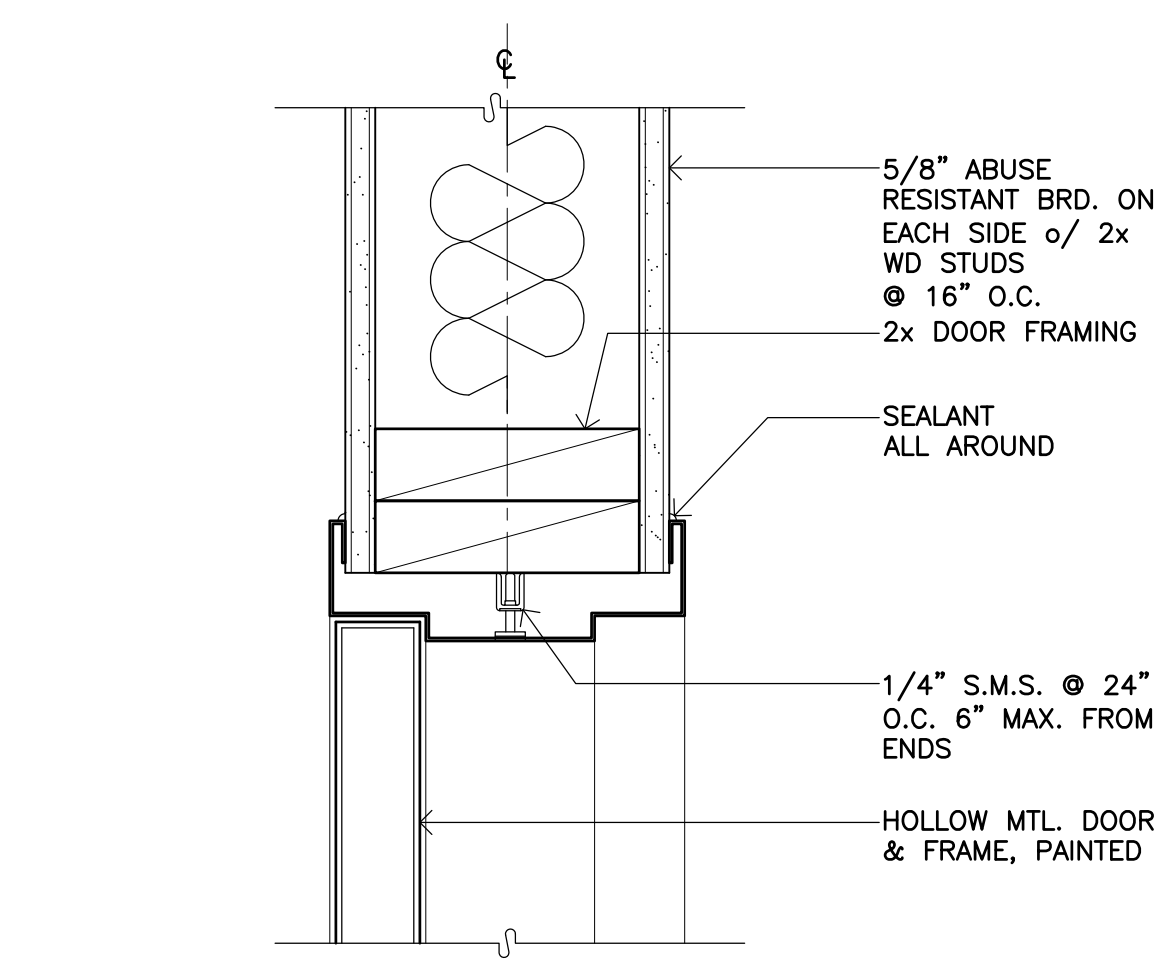


4 Head at Interior Door (Jamb Sim.)  
SCALE: 3" = 1'-0"

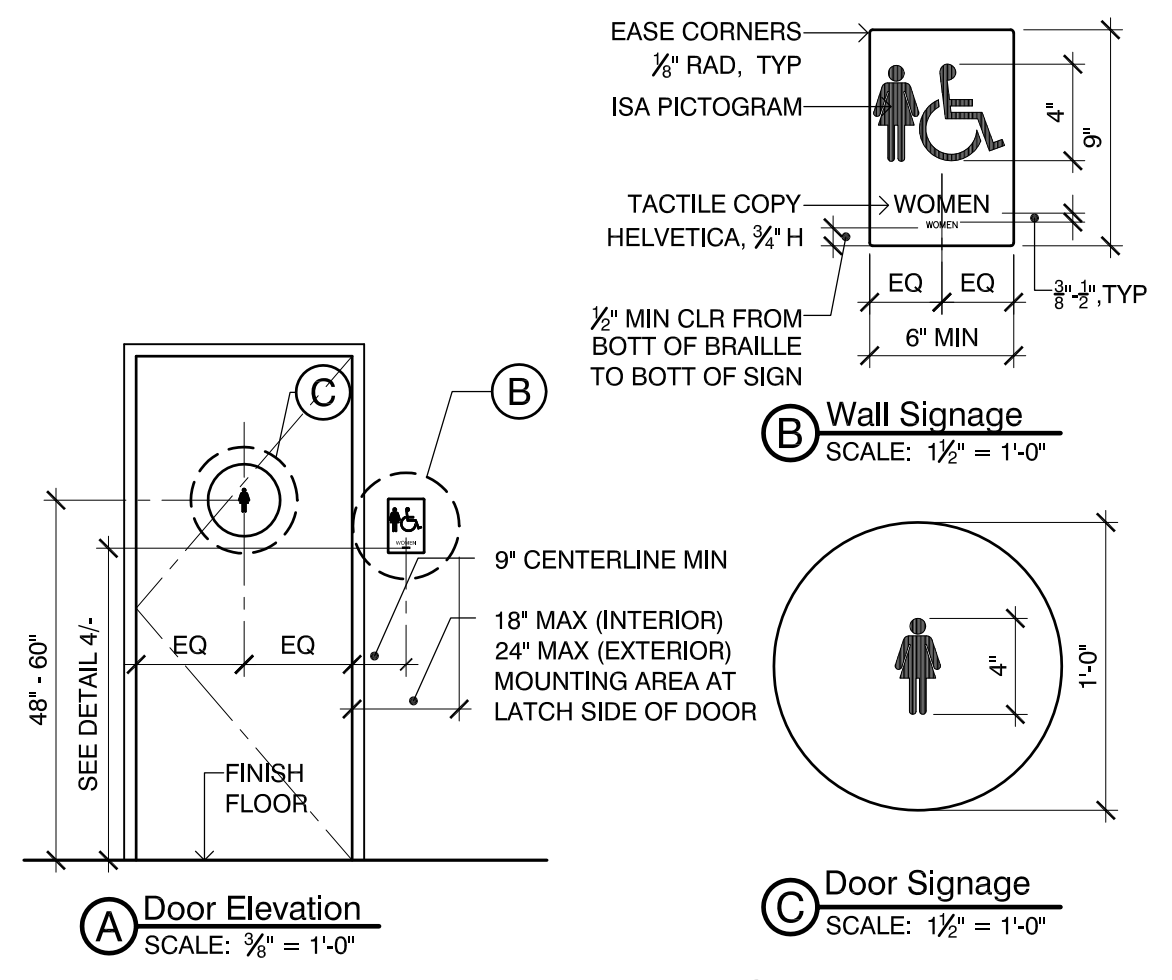


S4 Womens Restroom Signage  
SCALE: AS NOTED

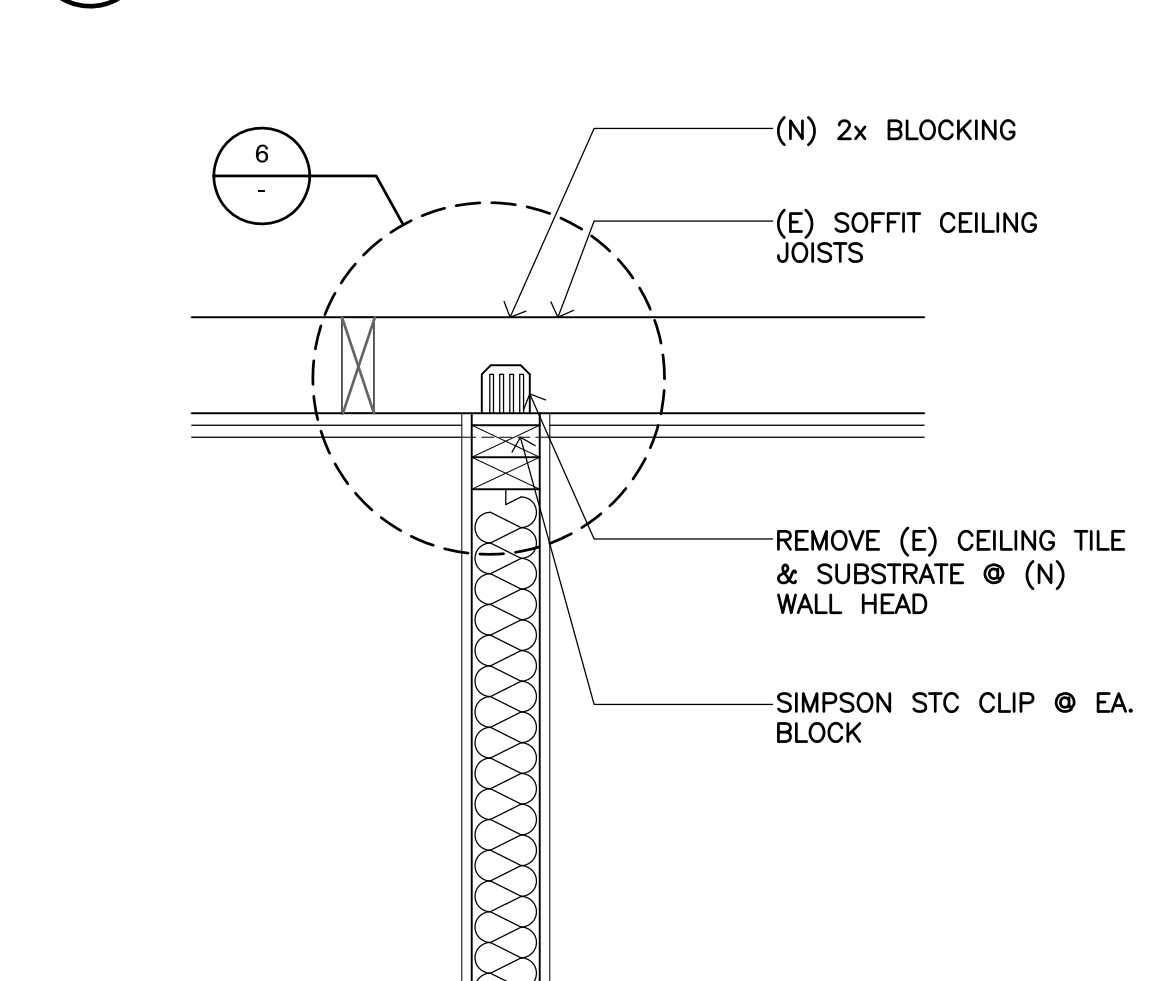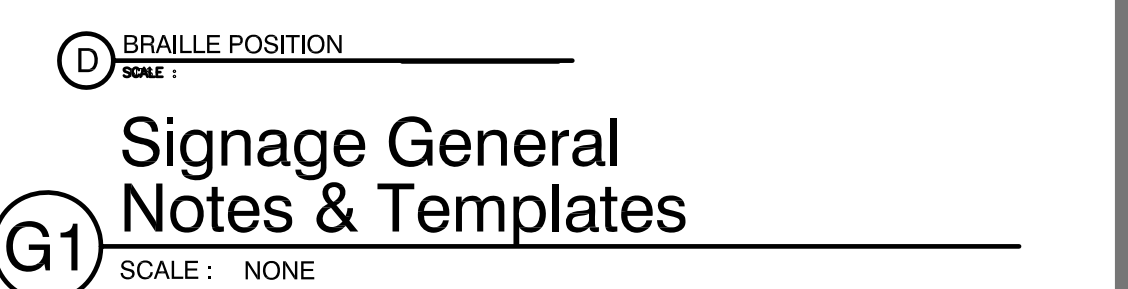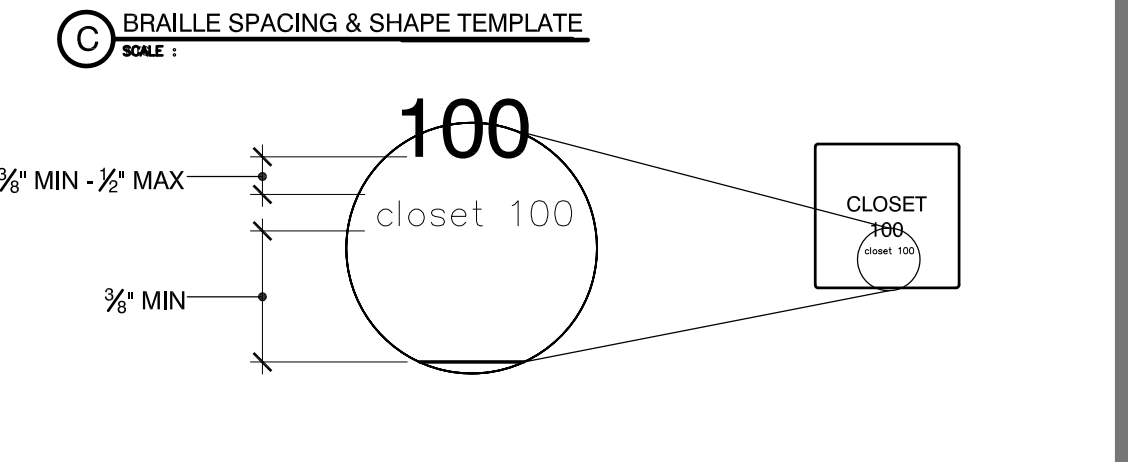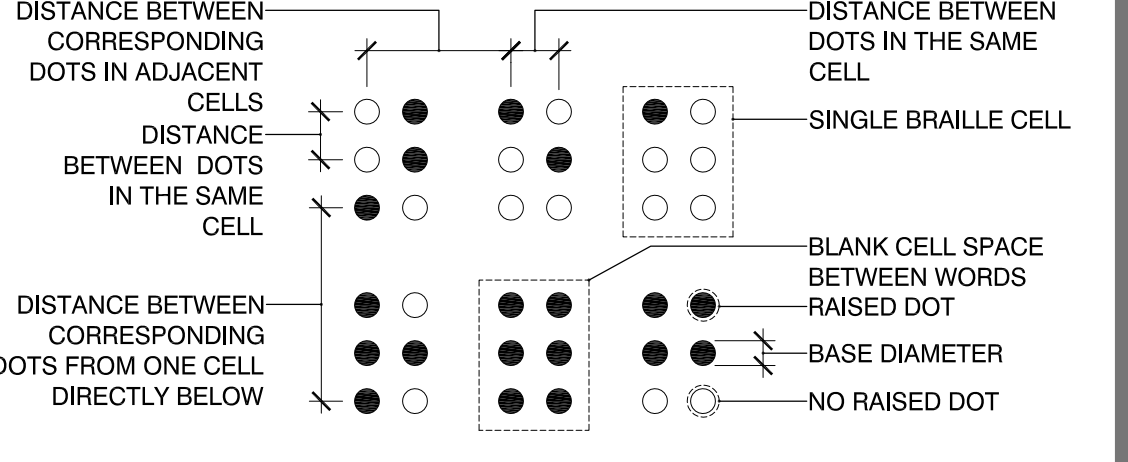


19 Wall Section  
SCALE: 1" = 1' - 0"

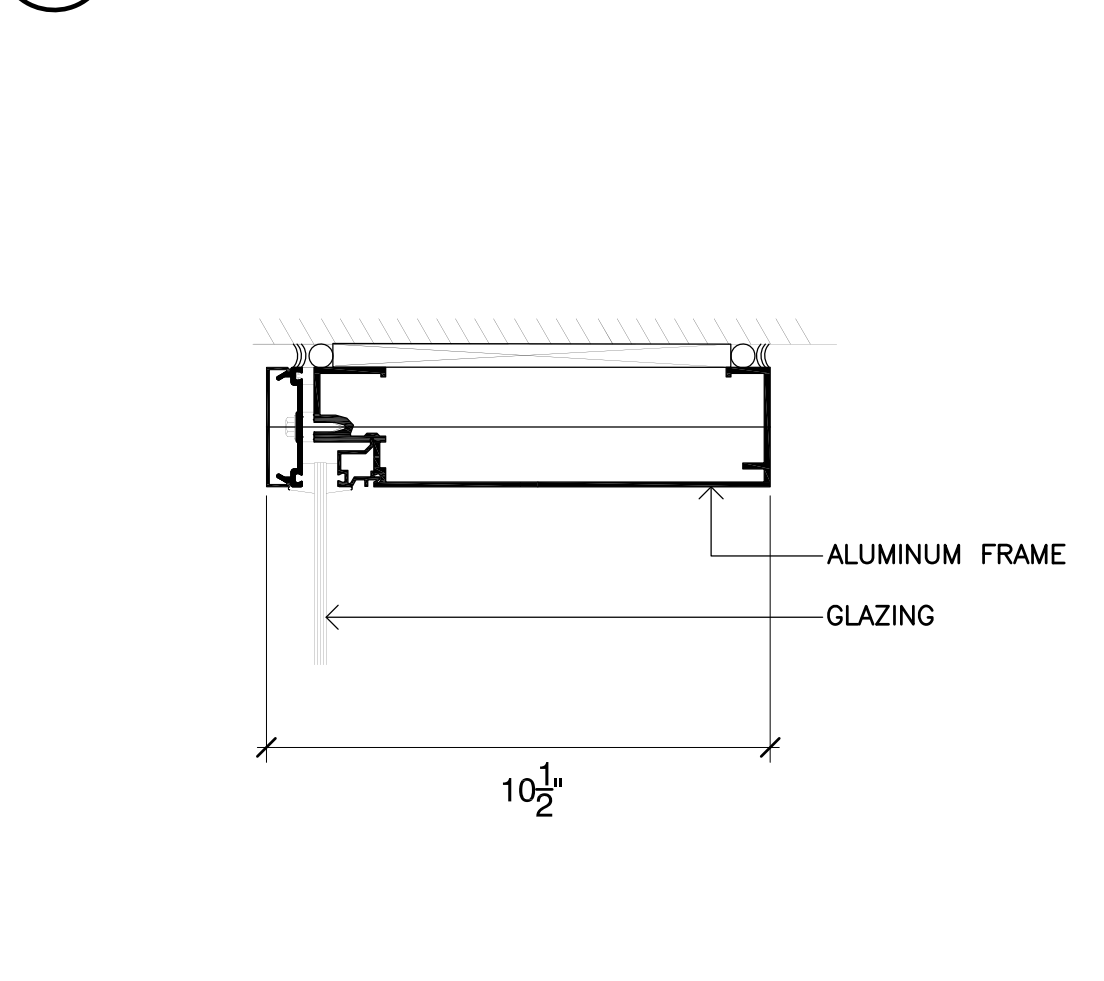


14 Deep Mullion Curtain Wall Head  
SCALE: 3" = 1'-0"

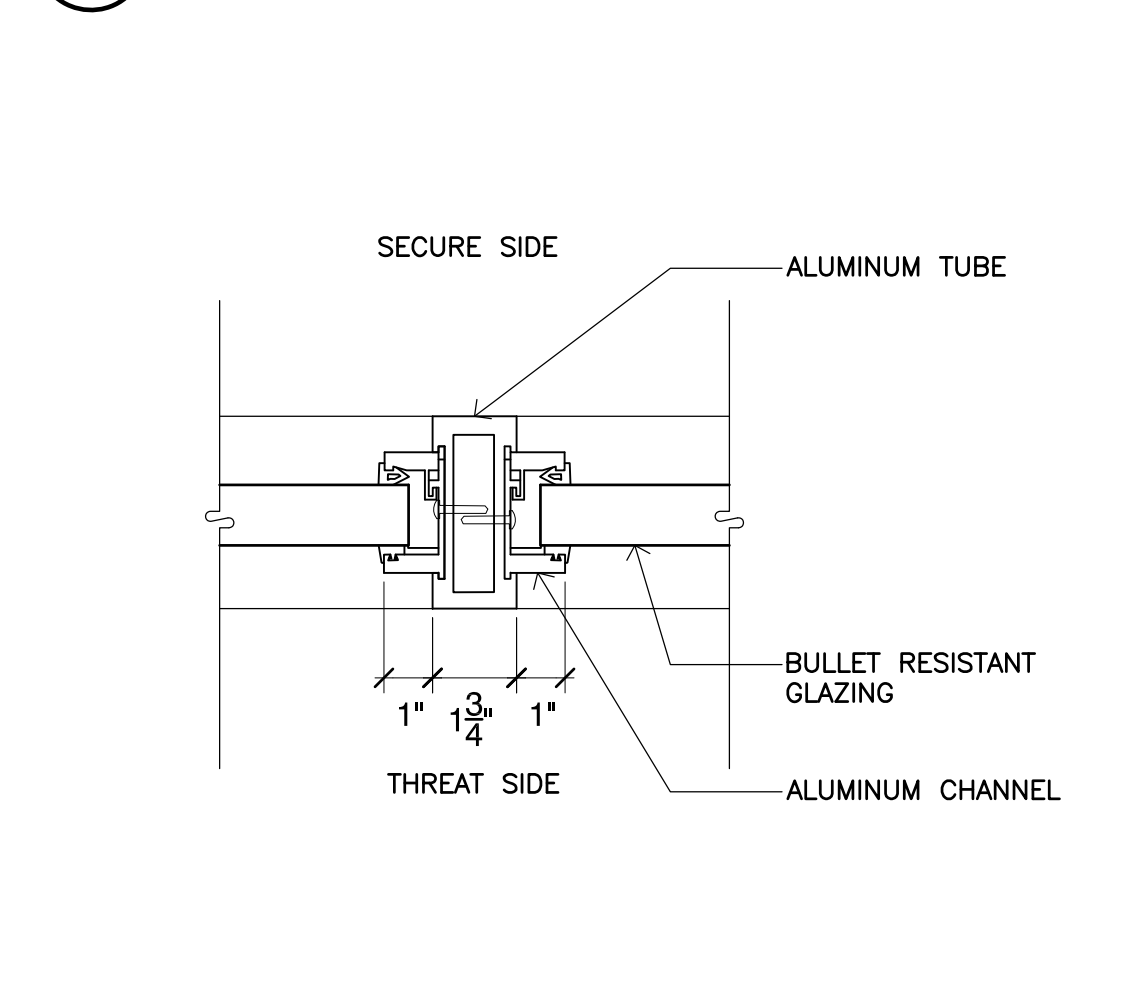


10 Storefront Mullion  
SCALE: 3" = 1'-0"

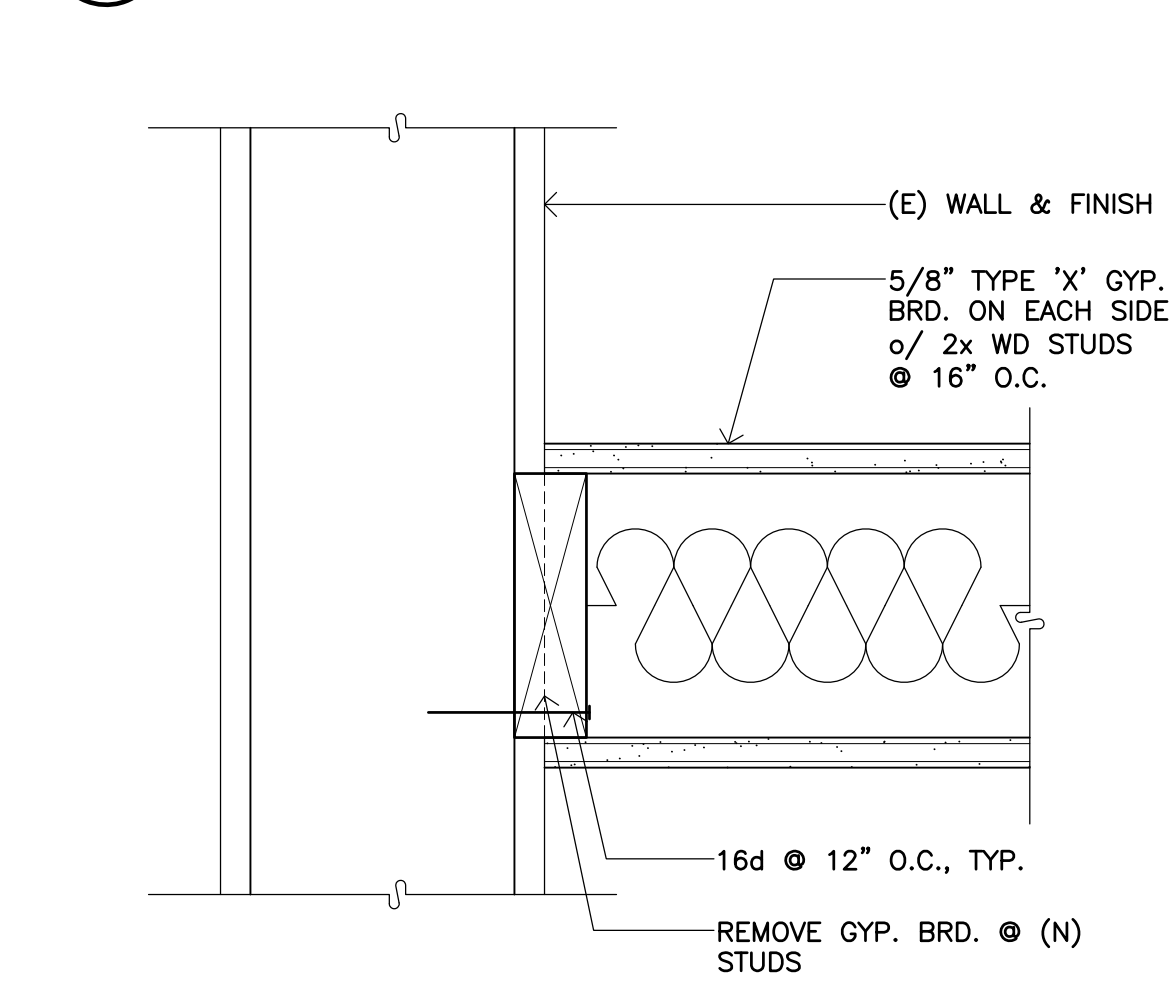


5 Wall Detail  
SCALE: 3" = 1'-0"

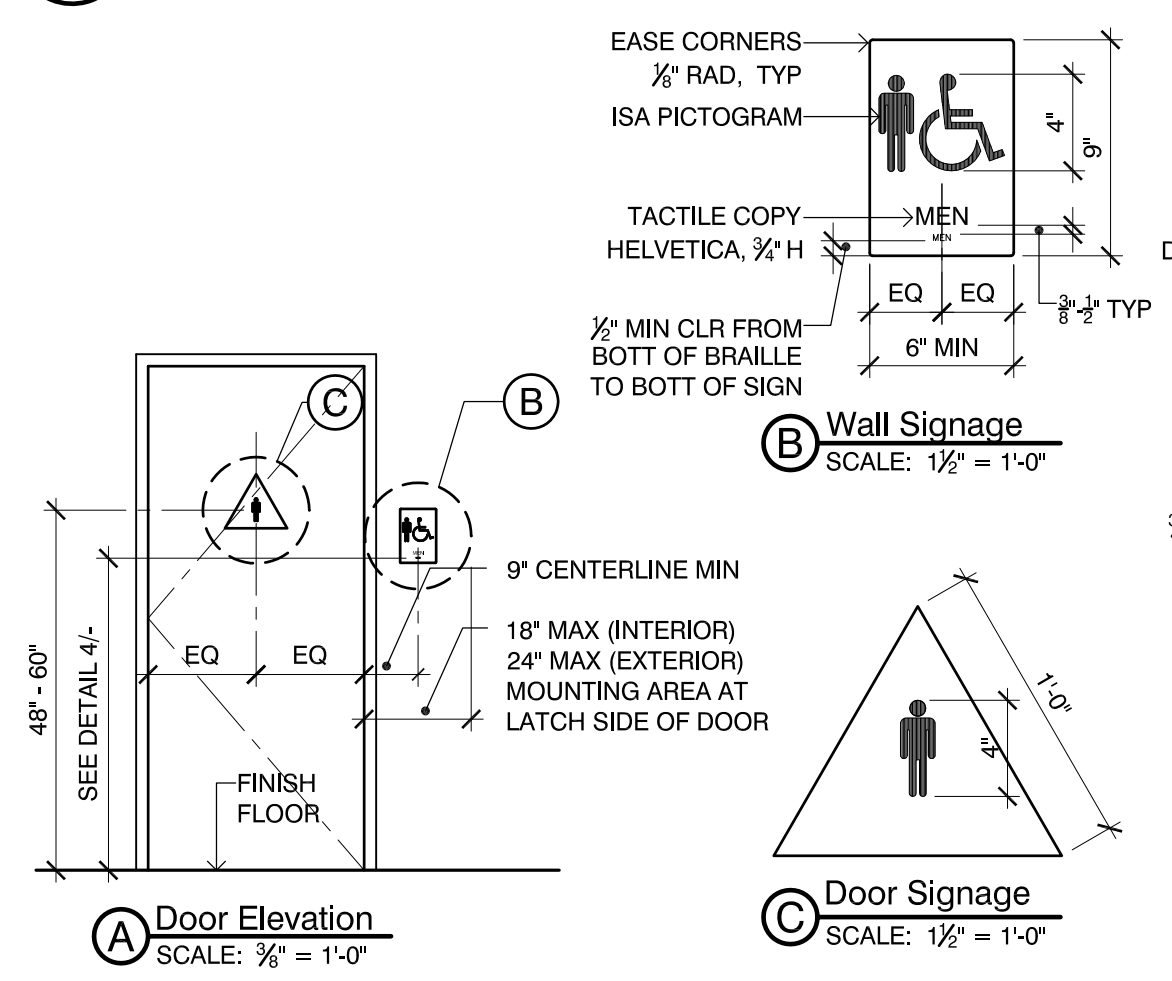


S5 Mens Restroom Signage  
SCALE: AS NOTED

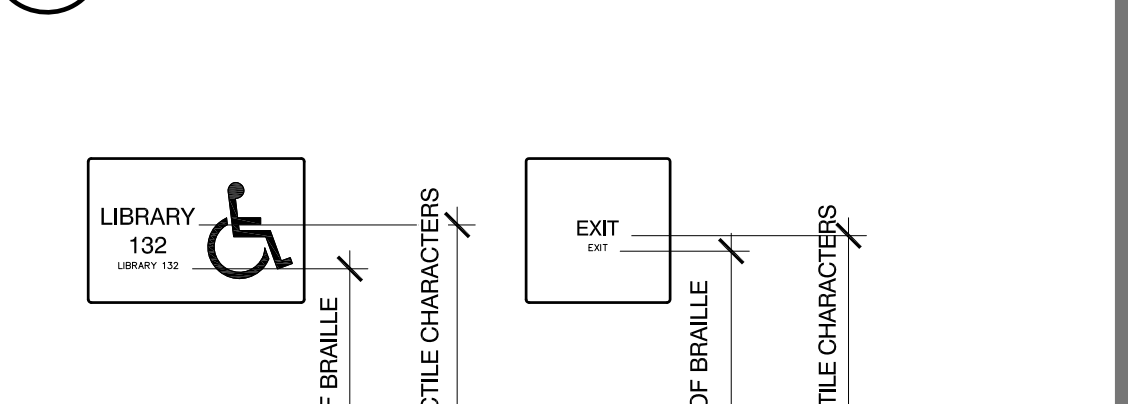


S1 Typ Mounting Hgt. Requirements  
SCALE: AS NOTED

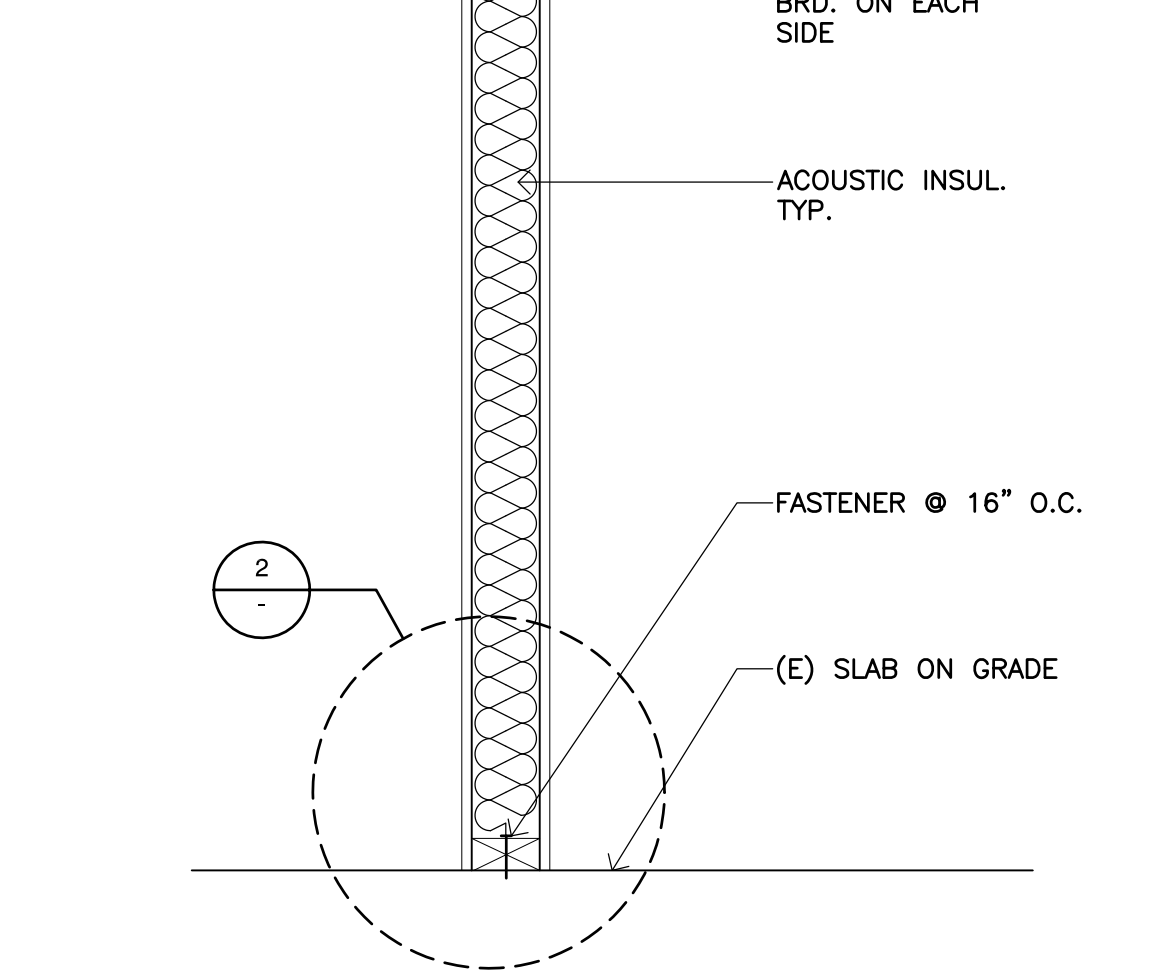


15 Deep Mullion Curtain Wall Jamb  
SCALE: 3" = 1'-0"

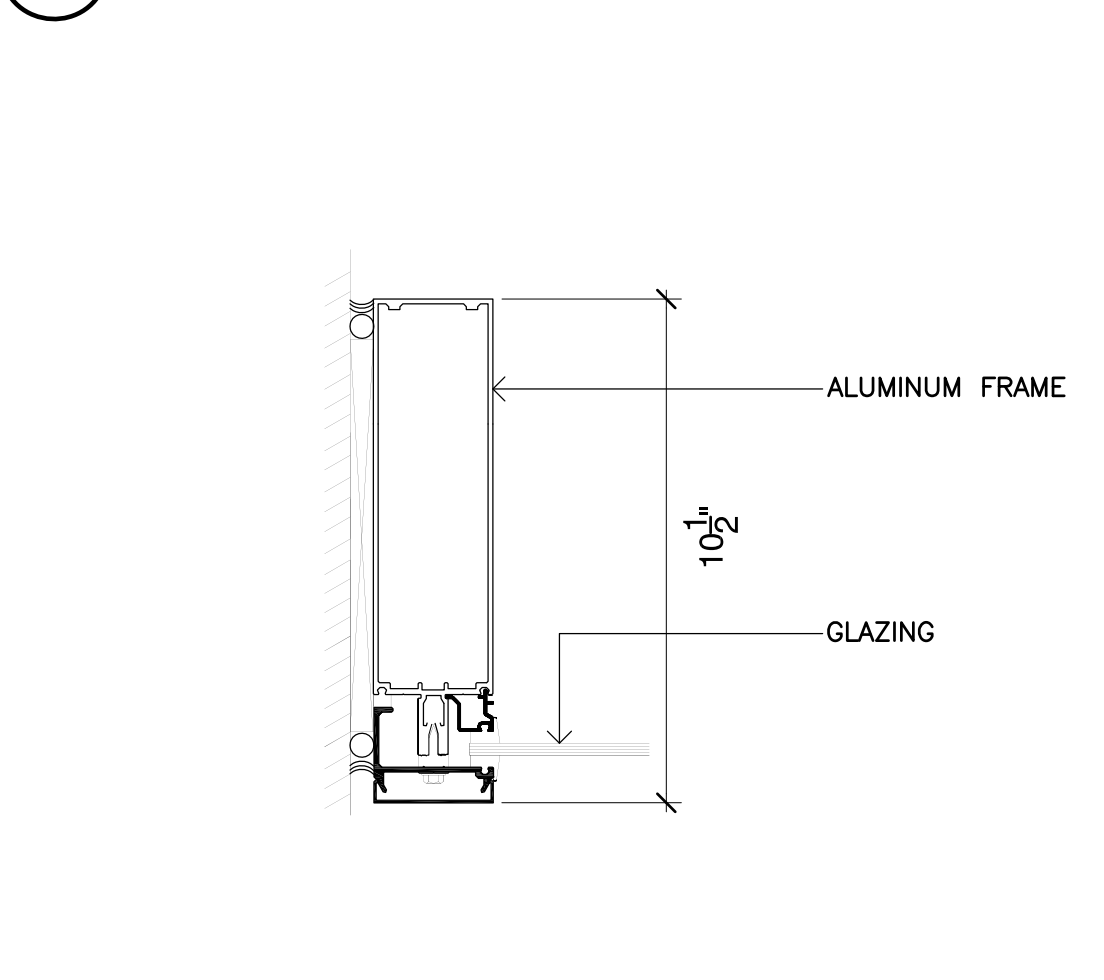


11 Wall Corner Detail  
SCALE: 3" = 1'-0"

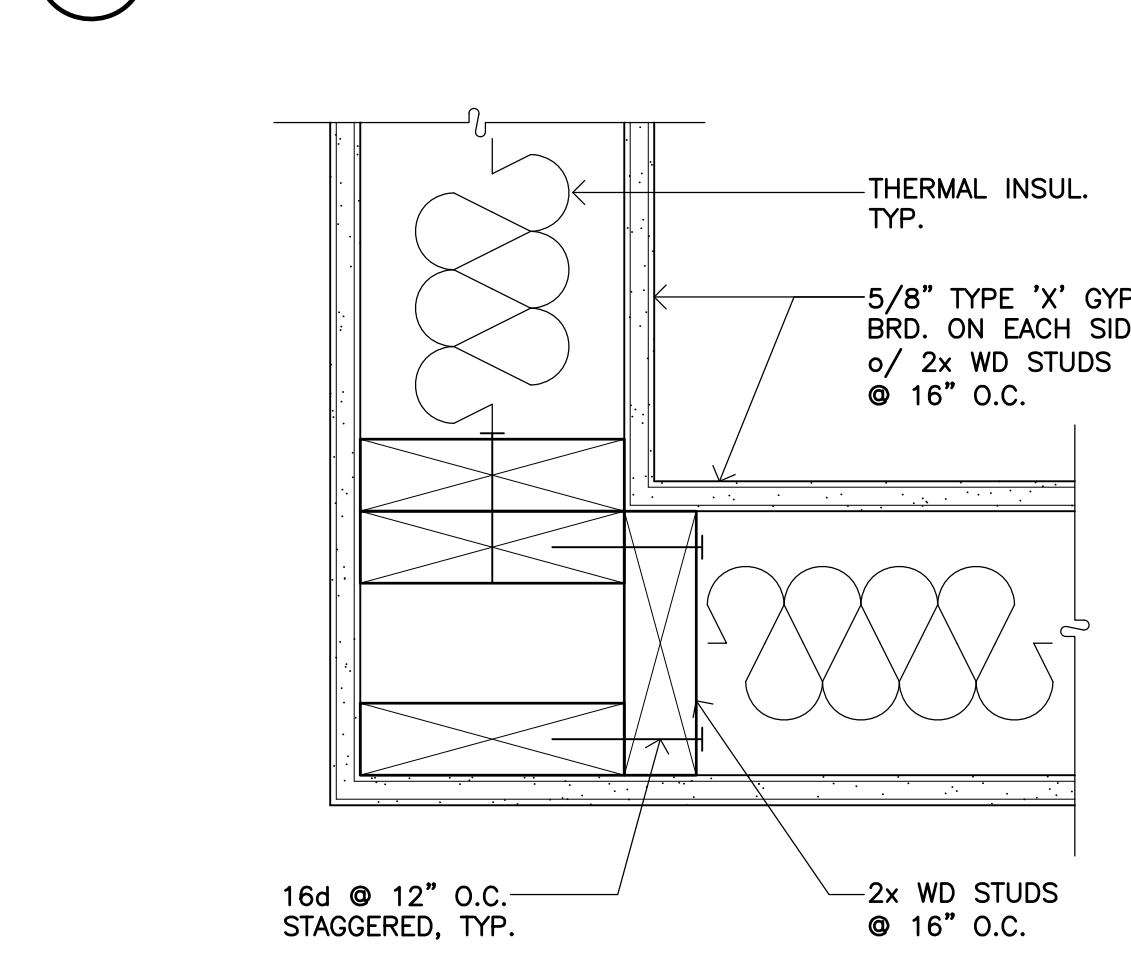


6 Wall Detail  
SCALE: 3" = 1'-0"

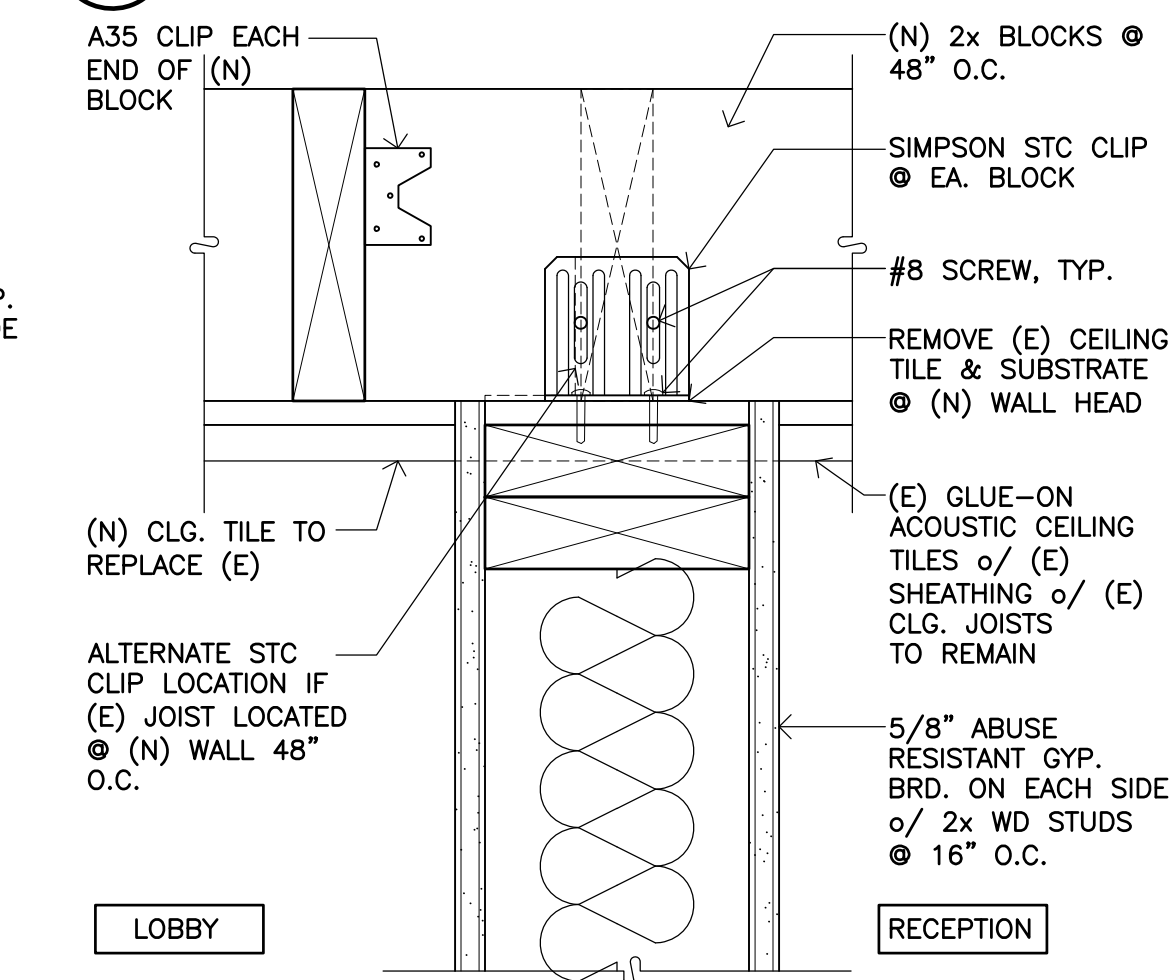


1 (N) Door Framing Detail  
SCALE: N.T.S.

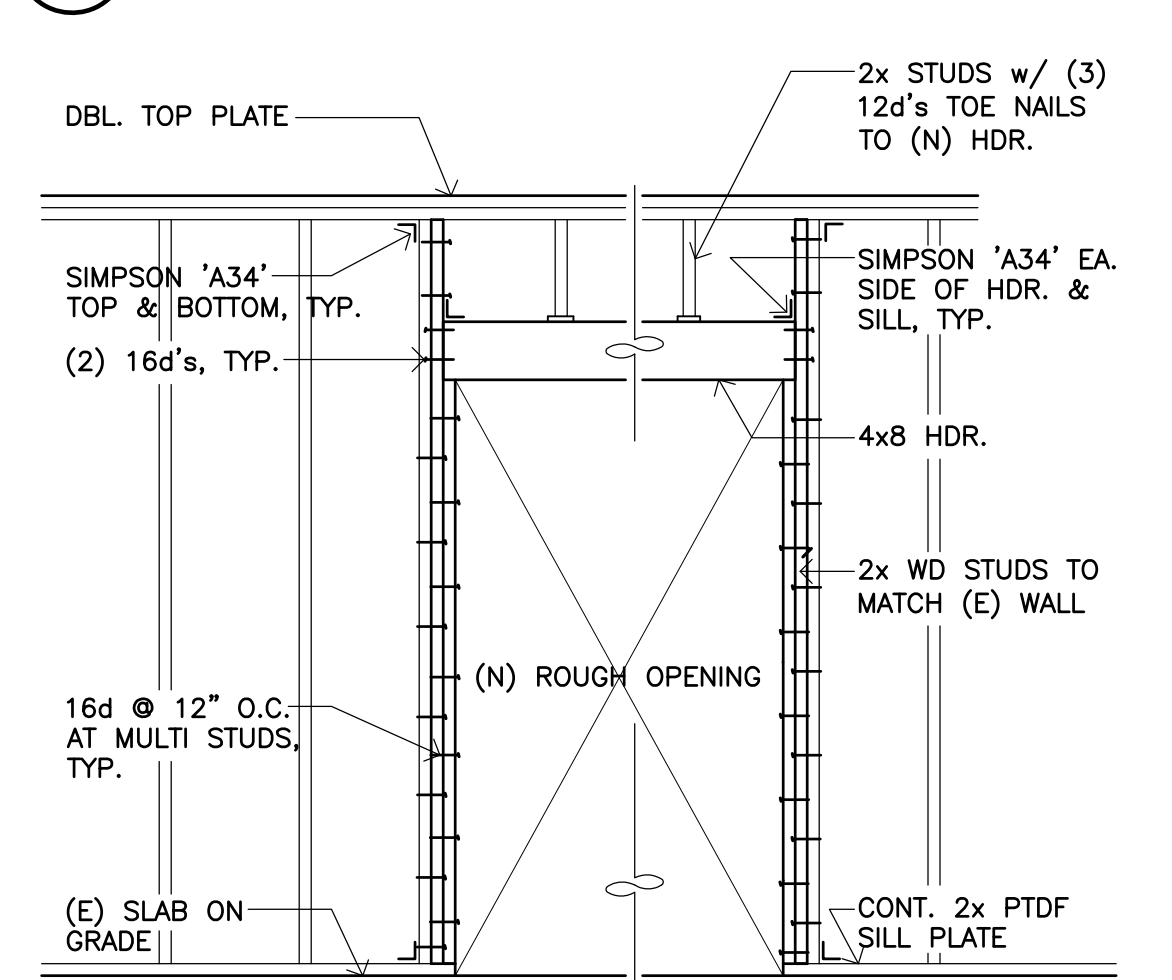

1 (N) Door Framing Detail  
SCALE: N.T.S.

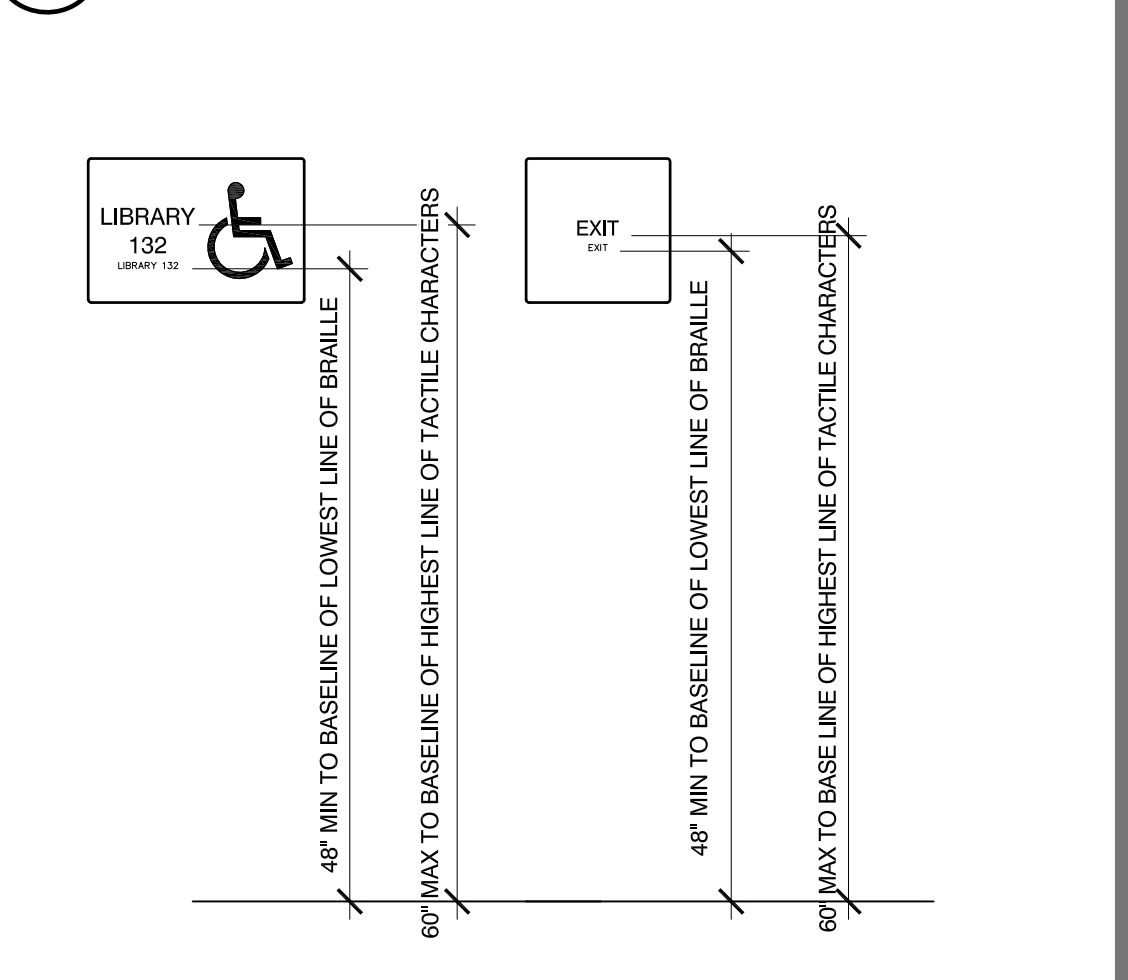

S1 Typ Mounting Hgt. Requirements  
SCALE: AS NOTED

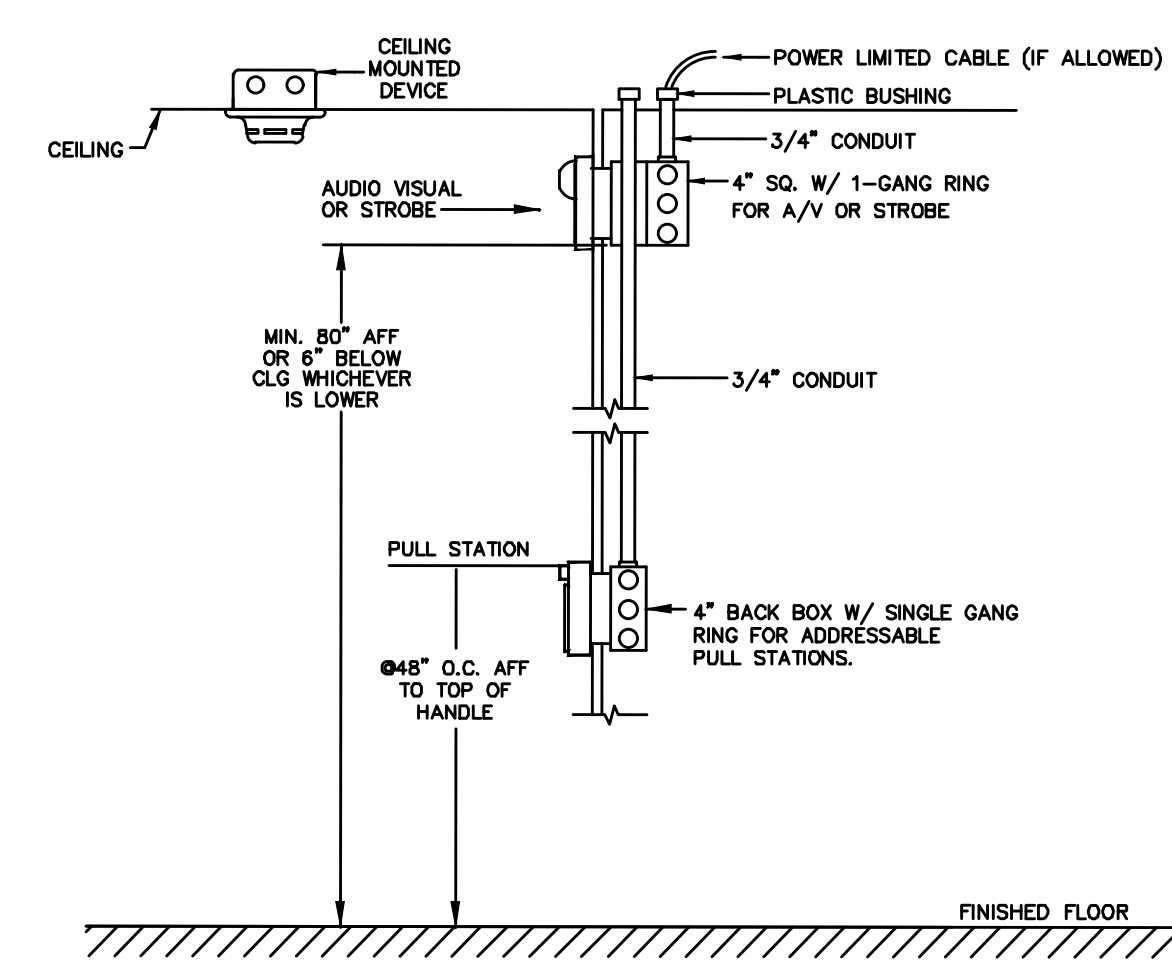

COMMON AREA  
 ③ MOUNTING HEIGHT & ROUGH-IN DETAIL  
 SCALE: NONE

### FIRE ALARM SYSTEM LEGEND

SYMBOL	DESCRIPTION	MODEL #	C.S.F.M. #	BACK BOX REQUIREMENTS
SP-3	HORN/STROBE 30CD	GENTEX GEC24-30WR	7135-0569-122	4" SQUARE DEEP BOX

### WIRE CHART

SYMBOL	CIRCUIT USE	1/2" C. & WIRE DESCRIPTION
S	INITIATION SIGNALING LINE CIRCUIT	2#14 THHN IN CONDUIT OR FPLR
A	AUDIBLE NOTIFICATION CIRCUIT	2#12 TWISTED SHIELDED PAIR
V	VISUAL NOTIFICATION CIRCUIT	2#12 THHN IN CONDUIT OR FPLR

### SEQUENCE OF OPERATION

BUILDING W/ ONLY	BUILDING POWER FAILURE	SMOKE DETECTOR	TEMP. DETECTION	WOOD DETECTION
APPLICABLE AT FIRE ALARM CONTROL PANEL, ALARM AND TROUBLE	YES	YES	YES	YES
ACTIVATE AUDIBLE AND VISUAL SIGNALS	YES	YES	YES	YES

### BUILDING K BATTERY CALCULATIONS

DEVICE TYPE	QTY	CURRENT STAND-BY	TOTAL CURRENT STAND-BY	CURRENT ALARM	TOTAL CURRENT ALARM
(EXISTING) HORN OUTDOOR	4	-	-	0.038	0.152
(EXISTING) STROBE 30CD	11	-	-	0.046	0.506
(NEW ADDED 2) STROBE 30CD	5	-	-	0.083	0.315
(NEW ADDED 2) HORN	2	-	-	0.006	0.112
(EXISTING) SMOKE DETECTOR	3	0.0003	0.0009	0.001	0.004
(EXISTING) FACP-K	1	0.000	0.000	0.000	0.000
<b>TOTALS</b>			<b>0.0009</b>	<b>0.146</b>	<b>1.219</b>

### COMPUTATIONS

TOTAL APPS USED IN STAND-BY: 0.0009 APP X 24 HOURS = 0.0242 APP-HOUR  
 TOTAL APPS USED IN ALARM: 1.219 APPS X 0.009 (9 MINUTES) = 0.1011 APP-HOUR  
 TOTAL STAND-BY BATTERY REQUIREMENTS: 1.541 APP-HOUR  
 TOTAL BACKUP BATTERY PROVIDED: 1.000 APP-HOUR  
 TOTAL BACKUP BATTERY REQUIRED: 1.828 APP-HOUR  
 TOTAL BACKUP BATTERY RESERVED: 5.07 APP-HOUR

### BUILDING K VOLTAGE DROP CALCULATION


DEVICE TYPE	QUANTITY	CURRENT ALARM	TOTAL CURRENT ALARM
(EXISTING) STROBE 30CD	11	0.021	0.231
(NEW ADDED 2) STROBE 30CD	5	0.097	0.228
(EXISTING) STROBE 30CD	-	0.000	-
(EXISTING) STROBE 30CD	-	0.000	-
(NEW ADDED 2) HORN	2	0.056	0.112
<b>TOTALS</b>			<b>0.571</b>

LENGTH OF RUN TO LAST DEVICE: 100 FEET  
 WIRE: #12 THHN COPPER  
 CIRCULAR MIL: 4000  
 CONSTANT: 216 FOR COPPER

### COMPUTATIONS

VOLTAGE DROP FORMULA:  
 $V_{D} = \frac{APPS \times LENGTH \times 216}{CIRCULAR MIL}$   
 $V_{D} = \frac{0.571 \times 100 \times 216}{4000} = 0.308$   
 $V_{D} - VOLTAGE \times 100 = 0.308 \times 100 = 30.8$

BUILDING K REVISED CALCULATIONS FROM  
 ① APPROVED DSA RECORD DRAWINGS APPL #03 103017  
 SCALE: NONE

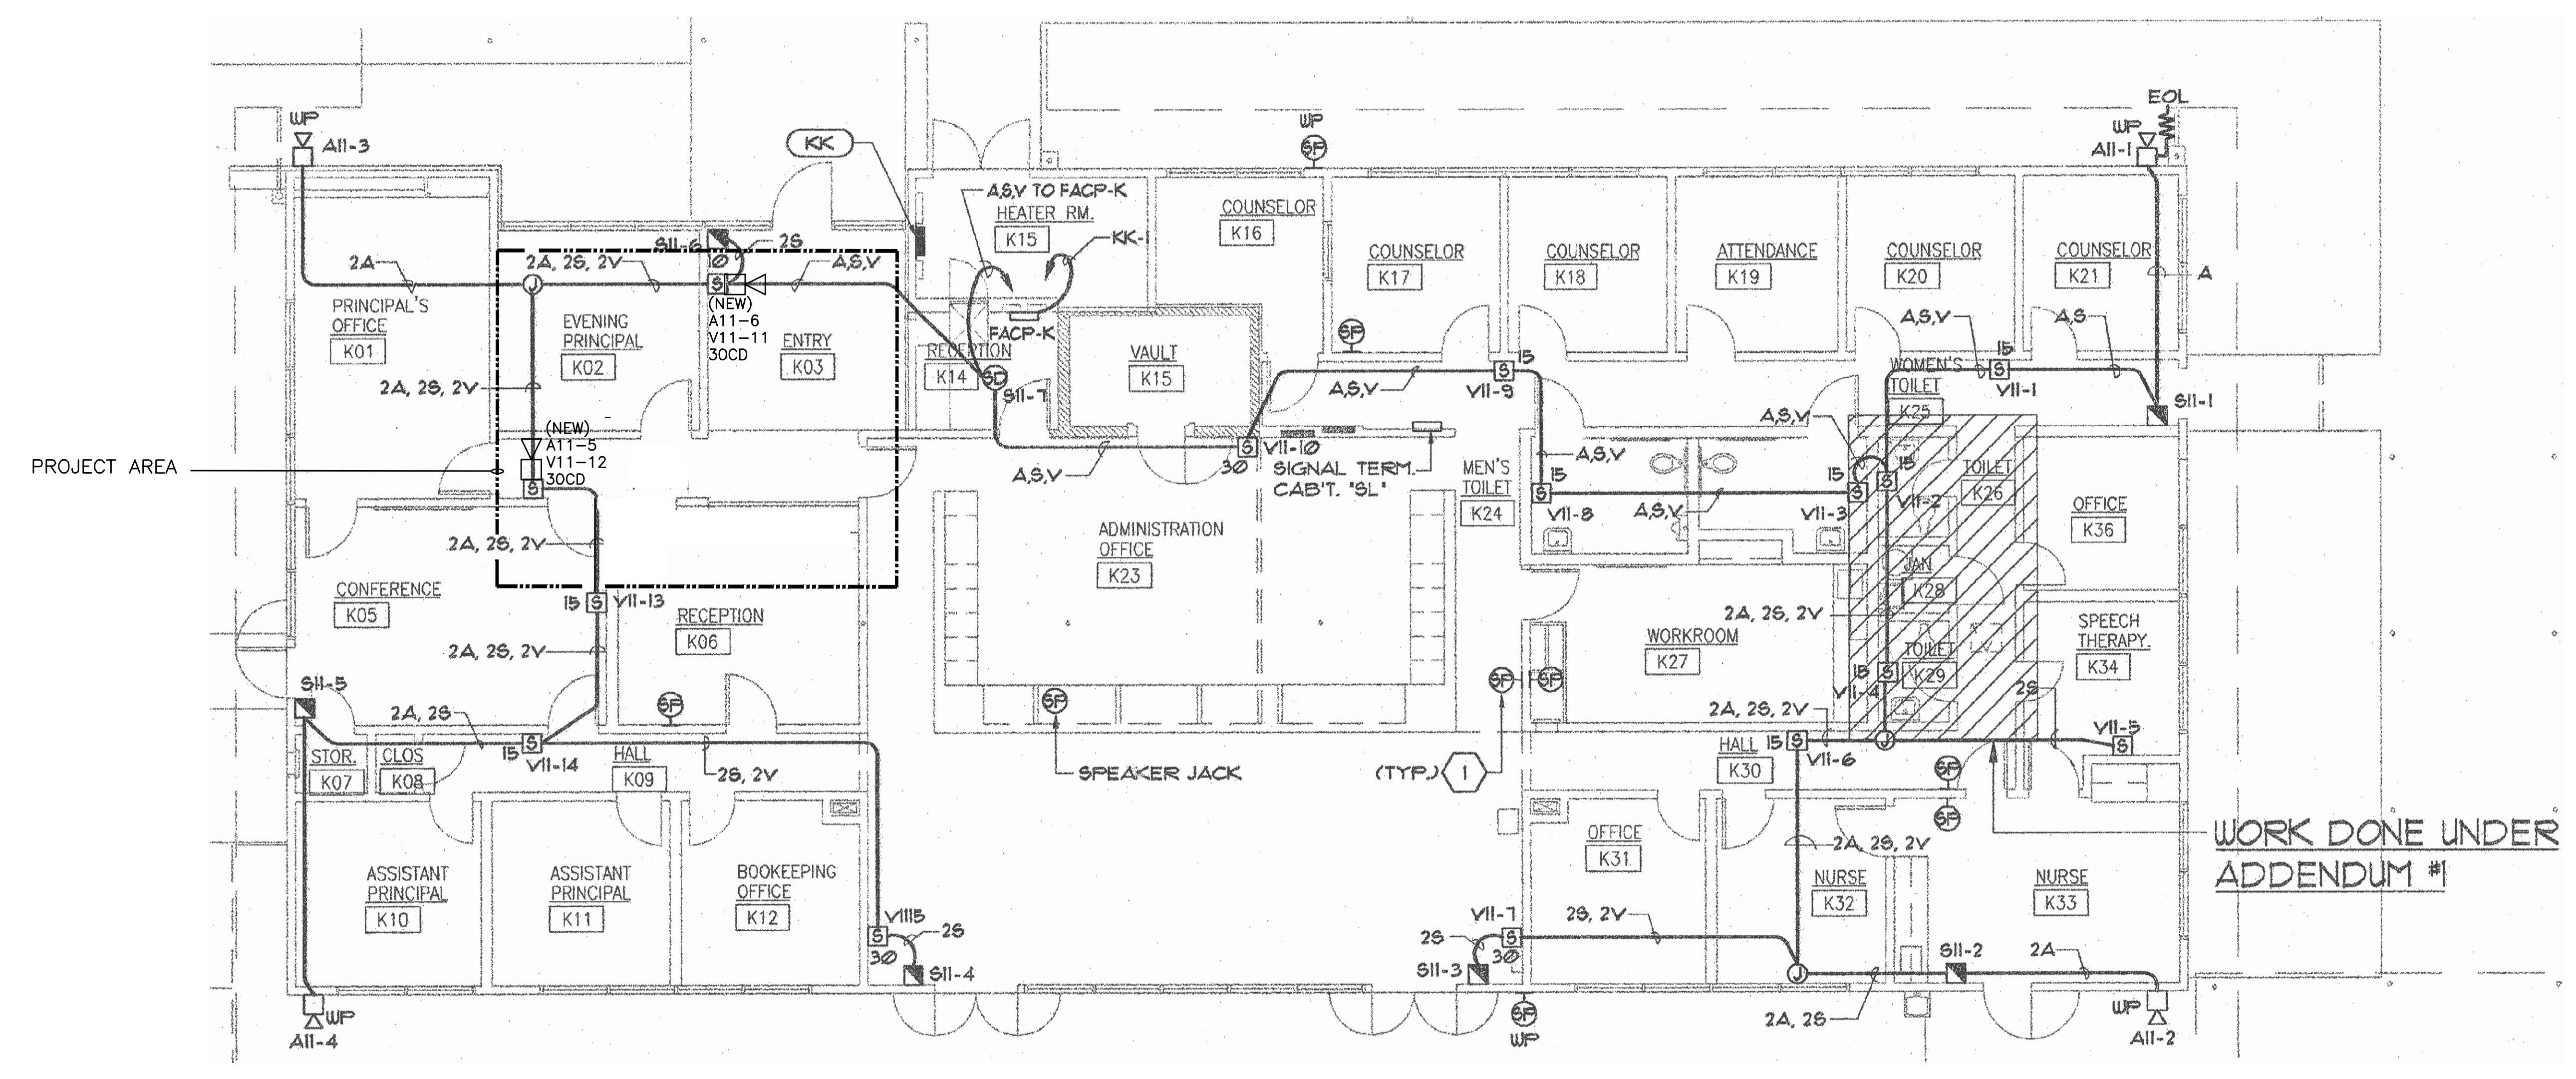


BUILDING K REVISED FIRE ALARM RISER DIAGRAM  
 ② SCALE: NONE



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 ARCHITECTURAL ASSISTANT

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REVISION	DESCRIPTION	DATE	BY
1	AM		XX
2	CH		XX
3	CH		XX
4	CH		XX
5	CH		XX

DRAWN: AM  
 CHECKED: CH  
 DATE: 3/8/2019  
 JOB NO: 18014  
 CHA NO: 19-919  
 SHEET: FIRE ALARM CALCULATIONS SHEET  
 TITLE: FIRE ALARM CALCULATIONS SHEET

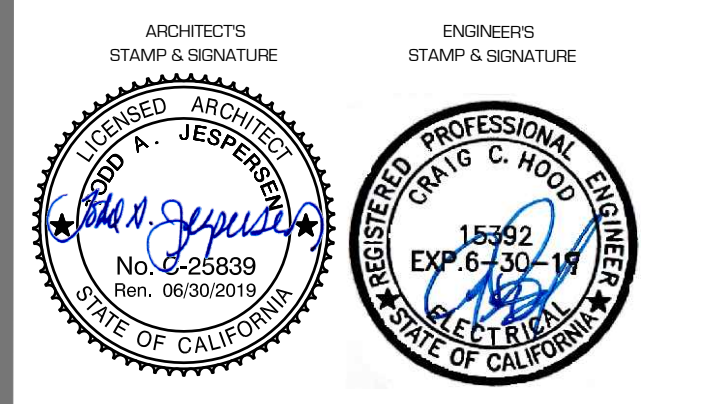