2. THE CONTRACTOR SHALL VERIFY ALL DIMENSIONS PRIOR TO STARTING WORK THE ARCHITECT SHALL BE NOTIFIED OF ANY DISCREPANCIES OR INCONSISTENCIES. THE CONTRACTOR IS RESPONSIBLE FOR CHECKING AND COORDINATING ALL DIMENSIONS REVIEW BUILDING LAYOUT WITH ARCHITECT BEFORE STARTING ANY FOOTING **EXCAVATION OR FOUNDATION WORK.**

3. THE CONTRACTOR IS RESPONSIBLE FOR VERIFYING ACTUAL SITE CONDITIONS REGARDLESS OF INFORMATION SHOWN ON THE DRAWINGS. DISCREPANCIES BETWEEN CONDITIONS SHOWN OR NOT SHOWN ON DRAWINGS AND ACTUAL EXISTING VISIBLE, DISCERNABLE CONDITIONS AT THE JOB SITE, DO NOT RELIEVE THE CONTRACTOR FROM PERFORMING THE WORK OF THIS CONTRACT IN FULL CONFORMANCE WITH THE CONTRACT DOCUMENTS.

4. IT SHALL BE THE RESPONSIBILTY OF THE GENERAL CONTRACTOR TO INSURE THAT ALL APPLICABLE SAFETY LAWS ARE STRICTLY ENFORCED AND TO MAINTAIN A SAFE

5. BIDDERS MUST VISIT THE BUILDING SITE AND FAMILIARIZE THEMSELVES WITH EXISTING CONDITIONS. THE INTENT OF THESE DRAWINGS AND SPECIFICATIONS IS TO PROVIDE A PROJECT COMPLETE IN EVERY DETAIL AND READY FOR OCCUPANCY. DISCREPANCIES OR DELETIONS MUST BE BROUGHT TO THE ATTENTION OF THE

6. ANY DAMAGE DONE TO THE EXISTING SITE OR FACILITIES DURING THE COURSE OF THE WORK SHALL BE REPAIRED OR REPLACED BY THE CONTRACTOR AT HIS OWN EXPENSE WITH NO ADDITIONAL COST TO THE DISTRICT.

7. BIDDERS SHALL ASSUME THAT ALL ITEMS INDICATED ON THE DRAWINGS ARE NEW CONSTRUCTION IF NOT INDICATED WITH AN (N) OR "NEW", UNLESS INDICATED AS "(E)"

8. ALL NEW WORK SHALL MATCH EXISTING IN KEEPING WITH GOOD CONSTRUCTION PRACTICE. IT IS THE INTENT OF THESE DOCUMENTS THAT THE PORTION OF THE SURFACE WHICH HAS BEEN INSTALLED, REPAIRED OR REPLACED, SHALL MATCH THE EXISTING ADJACENT SURFACES, AND THAT THE NEW WORK WILL NOT BE DISCERNABLE FROM THE EXISTING.

9. WHERE MINIMUM DIMENSIONS ARE INDICATED, EXISTING DIMENSIONS IN EXCESS OF THAT SHOWN MAY BE RETAINED UNLESS OTHERWISE NOTED.

10. CONTRACTOR SHALL NOTIFY THE ARCHITECT IMMEDIATELY OF ALL OMISSIONS AND CONFLICTS BETWEEN THE ELEMENTS OF THE CONTRACT DOCUMENTS BEFORE PROCEEDING WITH THE WORK INVOLVED.

11. CONTRACTOR SHALL PROTECT ALL EXISTING STRUCTURAL, MECHANICAL, PLUMBING ELECTRICAL, LANDSCAPE SITE FEATURES TO REMAIN, ALL DAMAGED WORK SHALL BE REPLACED WITH THE SAME MATERIALS, INCLUDING MATCHING THE EXISTING COLORS AND TEXTURES BY THE CONTRACTOR AT HIS OWN EXPENSE WITH NO ADDITIONAL COST TO THE DISTRICT.

12. ALL WORK SHALL CONFORM TO TITLE 24, CALIFORNIA CODE OF REGULATIONS (CCR).

13. PROVIDE FIRE WATCH WHEN EXITING FIRE ALARM SYSTEM DOES NOT FUNCTION DURING CONSTRUCTION.

GENERAL REQUIREMENTS:

APPROVED BY THE DIVISION OF THE STATE ARCHITECT SHALL PROVIDE CONTINUOUS INSPECTION OF THE WORK. THE DUTIES OF THE INSPECTOR ARE DEFINED IN SECTION 4-342, CALIFORNIA BUILDING STANDARDS ADMINISTRATIVE CODE (PART 1, TITLE 24,

2. A 'DSA CERTIFIED' INSPECTOR WITH CLASS 3 CERTIFICATION IS REQUIRED FOR THIS

APPLICABLE CODES

CONSTRUCTION SHALL COMPLY WITH THE FOLLOWING:

2016 CALIFORNIA ADMINISTRATIVE CODE (CAC), TITLE 24 C.C.R. 2016 CALIFORNIA BUILDING CODE (CBC), TITLE 24 C.C.R. 2016 CALIFORNIA ELECTRICAL CODE (CEC), TITLE 24 C.C.R. 2016 CALIFORNIA MECHANICAL CODE (CMC), TITLE 24 C.C.R. 2016 CALIFORNIA PLUMBING CODE (CPC), TITLE 24 C.C.R. 2016 CALIFORNIA ENERGY CODE, TITLE 24 C.C.R. 2016 CALIFORNIA HISTORICAL BUILDING CODE, TITLE 24 C.C.R. 2016 CALIFORNIA FIRE CODE (CFC), TITLE 24, C.C.R. 2016 CALIFORNIA EXISTING BUILDING CODE (CEBC), TITLE 24, C.C.R. 2016 CALIFORNIA GREEN BUILDING STANDARDS CODE (CALGREEN), TITLE 24, C.C.R.

PART 12 2016 CALIFORNIA REFERENCED STANDARDS CODE, TITLE 24, C.C.R.

PARTIAL LIST OF APPLICABLE STANDARDS:

NFPA 13 AUTOMATIC SPRINKLER SYSTEMS (CALIFORNIA AMENDED) 2013 EDITION NFPA 14 STANDPIPE SYSTEMS (CALIFORNIA AMENDED) 2013 EDITION NFPA 17 DRY CHEMICAL EXTINGUISHING SYSTEMS NFPA 17A WET CHEMICAL EXTINGUISHING SYSTEMS 2013 EDITION NFPA 20 STATIONARY PUMPS 2016 EDITION NFPA 24 PRIVATE FIRE SERVICE MAINS (CALIFORNIA AMENDED) 2016 EDITION NFPA 72 NATIONAL FIRE ALARM & SIGNALING CODE (CA. AMENDED) 2016 EDITION NFPA 80 FIRE DOOR AND OTHER OPENING PROTECTIVES NFPA 253 CRITICAL RADIANT FLUX OF FLOOR COVERING SYSTEMS 2015 EDITION NFPA 2001 CLEAN AGENT FIRE EXTINGUISHING SYSTEM (CA. AMENDED) 2015 EDITION NATIONAL REFERENCE STANDARDS:

AISC SEISMIC PROVISIONS FOR STRUCTURAL STEEL BUILDINGS (ANSI/AISC 341-10) AISC SPECIFICATION FOR STRUCTURAL STEEL BUILDINGS (ANSI/AISC 360-10)

NATIONAL DESIGN SPECIFICATION (NDS) FOR WOOD CONSTRUCTION (ANSI/AWS NDS 2015)


ACI-318-14 BUILDING CODE REQUIREMENTS FOR STRUCTURAL CONCRETE

STATE BUILDING CODE (Part 1, Title 24, C.C.R.)

"The intent of these drawings and specification is that the work of the alteration, rehabilitation or reconstruction is to be in accordance with Title 24. California Code of Regulations. Should any existing conditions such as deterioration or noncomplying construction be discovered which is not covered by the contract documents wherein the finished work will not comply with Title 24, California Code of Regulations, a change order, or a separate set of plans and specifications, detailing and specifying the required work shall be submitted to and approved by the Division of the State Architect before proceeding with the work*

Changes to the approved drawings and specifications shall be made by an addenda or a construction change document (CCD) approved by the Division of the State Architect, as required by Section 4-338, Part 1, Title 24, CCR.

4235 MAR VISTA DR, CAMARILLO, CA 93010

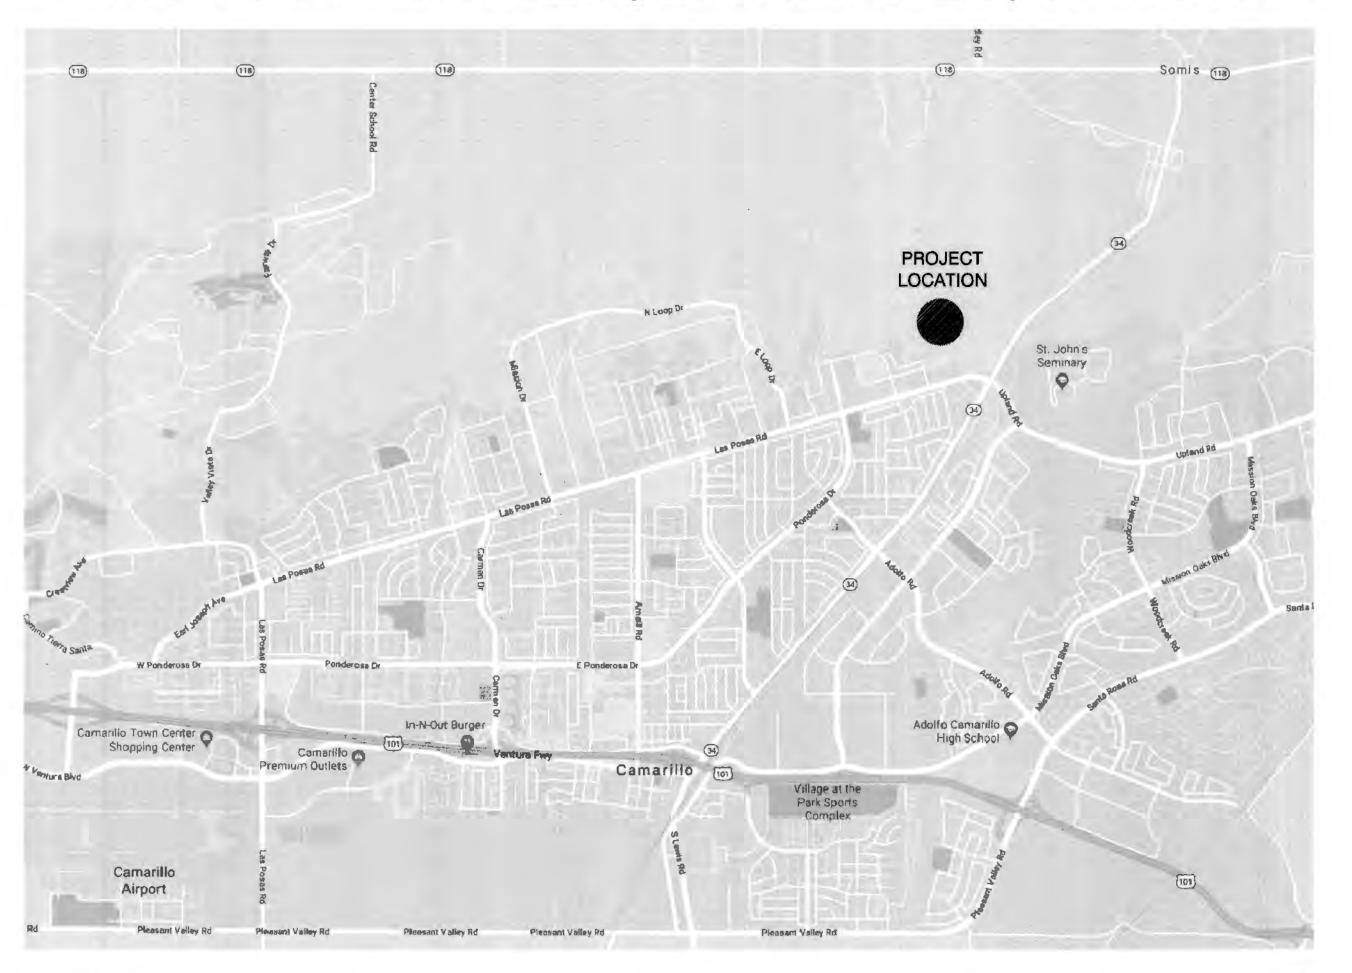

VICINITY MAP

SCALE: N.T.S.

ABBREVIATIONS

FINISH GRADE FIXTURE FLASHING ABOVE FINISHED FLOOR ADJUSTABLE / ADJACENT AIR CONDITIONING FLOOR (ING) FLUORESCENT FOOT OR FEET **FOUNDATION** ANODIZED **FURR APPROXIMATI** ARCHITECT (URAL) GALVANIZED ASPHALT CONCRETE **GYPSUM** AUTOMATIC BLOCKING BOUNDARY NAILING HOLLOW CORE HORIZONTAL CEILING INSULATION CENTERLINE INTERIOR CONCRETE CONCRETE MASONRY UNIT LABORATORY CONNECTION CONSTRUCTION LAVATORY CONSTRUCTION JOINT CONTINUOUS/CONTINUE LINEAR FEET COUNTER SINK LOUVER DEMOLISH / DEMOLITION MANUFACTURE (R) MAXIMUM MECHANIC (AL) DOWN MIN MTD MTG MINIMUM MOUNT (ED) DRINKING FOUNTAIN DOUGLAS FIR MOUNTING NATURAL ELECTRIC (AL) ELEVATOR / ELEVATION NOT IN CONTRACT ENCLOSE (URE) NOT TO SCALE EQUIPMENT NUMBER EXCAVATE ON CENTER (S **EXHAUST** OUTSIDE DIAMETER EXISTING **EXPANSION OPPOSITE EXPANSION JOINT** OVER

FACE OF CONCRETE

PARKING

PARTITION

PAVEMENT

PERFORATE

PERIMETER

PTN PVMT

FACE OF FINISH

FACE OF STUD

FIELD NAILING

FINISH FLOOR

FLATHEAD MACHINE SCREW PLYWD FLATHEAD WOOD SCREW AIR CONDITIONING IRRIGATION CONTROL VALVE INSIDE DIAMETER STRUCT SUSP SYS

PLASTIC LAMINATE PLYWOOD POINT OF CONNECTION POLYVINYL CHLORIDE POUNDS PER SQUARE FOOT PRESSURE TREATED REFRIGERATO REGISTER REINFORCED REQUIRED RESILIENT RETAINING RETURN AIR REVISION(S) ROOFING ROUGH OPENING ROUND HEAD MACHINE SCREW ROUND HEAD WOOD SCREW SHEATHING SHEET METAL SCREW SOLID CORE SPEAKER SPECIFICATION (S) STAINLESS STEEL STANDARD STORAGE STRUCTURE / STRUCTURAL SUSPENDED SYSTEM TELEVISION TOP OF PAVEMENT TOP OF STEEL TOP OF WALL TOP OF... TUBULAR STEEL TYPICAL UNLESS OTHERWISE NOTED VERTICAL GRAIN VINYL COMPOSITION TILE

WATER HEATER

WINDOW

WITHOUT


WOOD


WATERPROOF (ING)


WATER RESISTANT


WEST / WOMEN / WIDE


KEY NOTE SYMBOLS

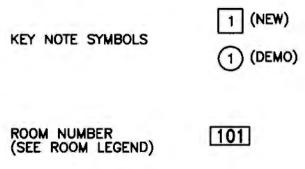


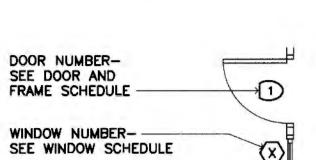

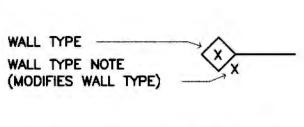

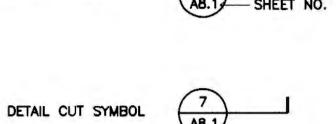

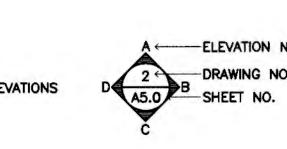

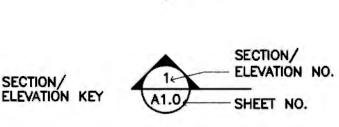

SYMBOLS LEGEND


ACCESSIBLE WHEELCHAIR SPACE, 30"W x 48"D CLEAR FLOOR SPACE. 27"H CLEAR


KNEE SPACE MIN. 34"H MAX.


TO TOP OF TABLE/COUNTER.






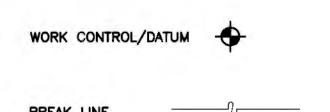

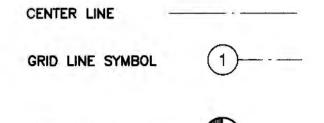

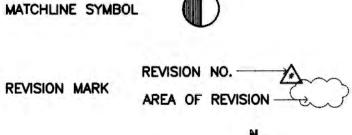

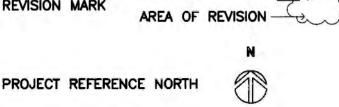

SHEET INDEX

GENERAL G-001 TITLE SHEET

> ARCHITECTURAL A-100 SITE PLAN

SITE DETAILS A-101 EXISTING RESTROOM PLANS A-200 BUILDING 'A' FLOOR PLAN A-201 ENLARGED DEMO FLOOR PLAN ENLARGED NEW FLOOR PLAN

INTERIOR ELEVATION

A-401 DOOR SCHEDULE A-600 REFLECTED CEILING PLAN A-800 DETAILS

TOTAL SHEET COUNT: 8

GENERAL NOTES CONT'D

14. CHANGE TO THE APPROVED DRAWINGS AND SPECIFICATIONS SHALL BE MADE BY ADDENDA OR CONSTRUCTION CHANGE DOLUMENT (CCD) APPROVER BY DSA, AS REQUIRED BY SECTION 4-338, PART 1, TITLE 24, CCR

15. A DIA ACCEPTED TESTING LABORATORY DIRECTLY EMPLOYED BY THE DISTRICT (DWNER) SHALL CONDUCT ALL THE REQUIRED TESTS AND INSPECTIONS FOR THE PROEDT.

PROJECT TEAM

KRUGER BENSEN ZIEMER ARCHITECTS, INC. 199 FIGUEROA STREET, SUITE 100A, VENTURA, CA 93001 OFFICE: (805) 650-1033

PRINCIPAL-IN-CHARGE: TODD A. JESPERSEN, AIA EMAIL ADDRESS: toddj@kbzarch.com

PROJECT TEAM: JONATHAN D. LEE EMAIL ADDRESS: jonathanl@kbzarch.com

PROJECT DATA

PROJECT LOCATION: 4235 MAR VISTA DRIVE, CAMARILLO, CA 93010 FIRE DISTRICT: COUNTY OF VENTURA **BUILDING OCCUPANCY: B BUILDING CONSTRUCTION TYPE: V-B (NON SPRINKLERED)**

ACTUAL LOBBY AREA: 294 SQ. FT. NO NEW SQUARE FOOTAGE

PROJECT SCOPE

THE PROJECT IS TO PROVIDE A SECURED ADMINISTRATION RECEPTION AREA BY INSTALLING A PERMANENT WALL WITH A SECURITY WINDOW BETWEEN THE LOBBY AND THE RECEPTION AREA. SCOPE OF WORK INCLUDES DEMOLITION, FRAMING, FINISHING, AND ASSOCIATED ELECTRICAL WORK.

OWNER

OXNARD UNION HIGH SCHOOL DISTRICT 309 S. "K" STREET, OXNARD, CA 93030 OFFICE: (805) 385-2500



ARCHITECTS, INC. 199 FIGUEROA ST, SUITE 100A VENTURA CA 93001 TELEPHONE (805) 650-1033

TDDD A. JESPERSEN, AIA JDNATHAN D. LEE

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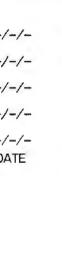
CONSULTANT INFORMATION


DSA STAMP & SIGNATURE DIVISION OF THE STATE ARCHITECT FILE NUMBER: 56-H4 APPL 03-119903

OPSC/DSA TRACKING NUMBER: 72546-70 -/-/--/-/-REVISION DESCRIPTION DATE

DRAWN JL CHECKED TJ DATE 6/5/2019 JOB. NO. 18028

SHEET TITLE SHEET



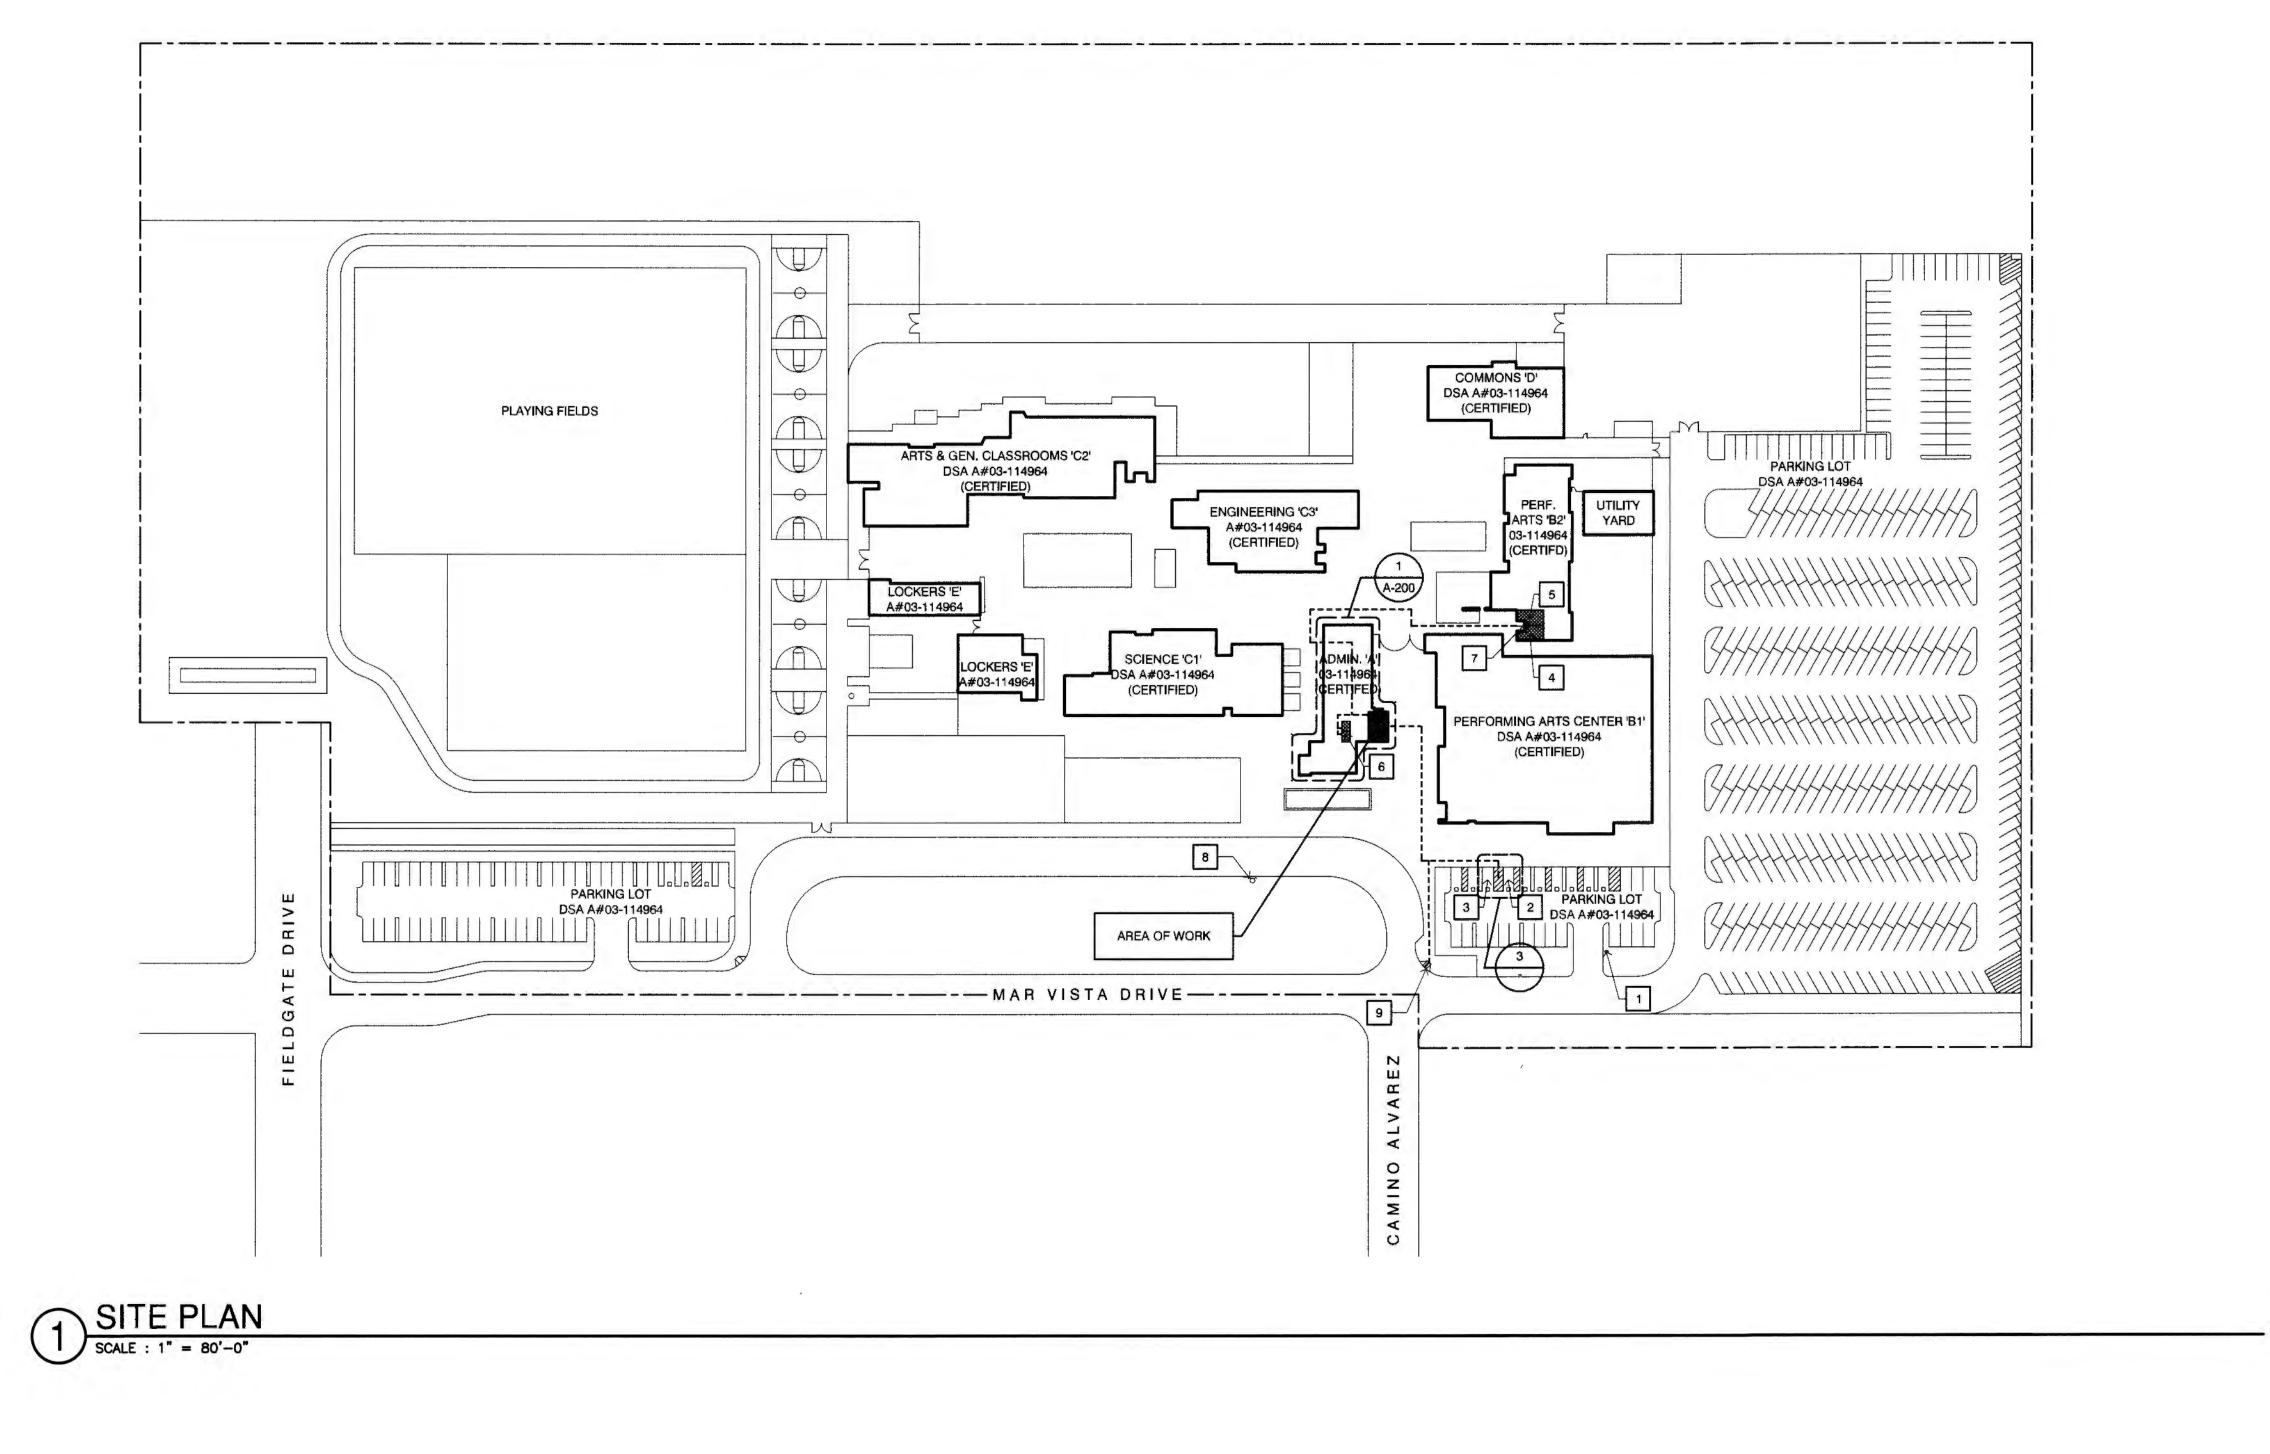

PERIMETER

BLUE, TYP.

—(E) 3" WIDE DIAGONAL STRIPING – BLUE, TYP.

—(E) 12* HIGH WHITE LETTERS

PARKING

(E) 5'-0"

MN. FINE \$250

Van Accessible Parking Sign
 Accessible Parking Sign

Existing Accessible Parking Sign

SCALE: 3/4" = 1'-0"

(E) FLUSH

(E) ACCESSIBLE
PARKING SPACE

TRANSITION, TYP.

REFLECTORIZED SIGN ON 16 GA. GALV.

1/4"Ø STAINLESS STEEL CARRIAGE BOLTS

(MANGLE THREADS AFTER INSTALLATION)

W/ WASHERS TO GALV. STEEL PIPE POST

(E) 4-#4 VERT., EQUALLY SPACED, W/ #3 TIES-2 @ TOP OF VERT. REBAR, 1 @ BOTTOM, AND 1 CENTERED ALONG REBAR

NOTICE: UNAUTHORIZED VEHICLES

SPECIAL LICENSE PLATES ISSUED FOR PERSONS WITH DISABILITIES WILL BE

TOWED AWAY AT OWNER'S EXPENSE.

TOWED VEHICLES MAY BE RECLAIMED

SPACES NOT DISPLAYING

AIRPORT TOWING

DISTINGUISHING PLACARDS OR

(E) VAN-ACCESSIBLE 4

- (E) WHEEL STOP,

(E) VAN-ACCESSIBLE
PARKING SPACE

(E) 36"x36" WHITE SYMBOL OF

ACCESSIBILITY ON A

BLUE BACKGROUND,

(E) 9'-0"

(E) Accessible Parking Spaces

| SCALE : 1/4" = 1'-0"

NO PARKING

(E) 8'-0"

SHEET METAL w/ 1" HIGH MIN. WHITE

LETTERING ON A CONTRASTING

- (E) 2" GALV. IRON SIGN POST

(E) CONCRETE FOOTING

(E) GRADE OR PAVING

SIGN TO READ:

キュロデオ

CONTRACTOR TO ADD -

CONTACT INFORMATION AS

1'-6"Ø

Parking Lot Entrance Sign

SCALE: 3/4" = 1'-0"

BACKGROUND PAINTED TO MATCH FEDERAL ADA BLUE, FASTEN SIGN W/ (3)



SITE PLAN KEYNOTES

(E) ACCESSIBLE GIRLS RESTROOM (03-114964 CERTIFIED)

(E) ACCESSIBLE BOYS RESTROOM (03-114964 CERTIFIED)

6 (03-114964 CERTIFIED)

(E) ACCESSIBLE STAFF RESTROOM

(E) PARKING LOT ENTRANCE SIGN IN COMPLIANCE WITH
THE CURRENT ACCESSIBILITY CODE REQUIREMENTS

2
-

(E) ACCESSIBLE PARKING SPACE IN COMPLIANCE WITH THE CURRENT ACCESSIBILITY CODE REQUIREMENTS

(E) VAN ACCESSIBLE PARKING SPACE IN COMPLIANCE WITH THE CURRENT ACCESSIBILITY CODE REQUIREMENTS

(E) HI-LO DRINKING FOUNTAIN (03-114964 CERTIFIED)

- 1. PROTECT ALL EXISTING STRUCTURES, UTILITIES & LANDSCAPING DURING CONSTRUCTION.
- 2. PLANS WERE PREPARED USING AS-BUILT DRAWINGS RECEIVED FROM THE SCHOOL DISTRICT. THE CONTRACTOR SHALL FIELD VERIFY EXISTING ACTUAL CONDITIONS PRIOR TO START OF WORK AND NOTIFY THE ARCHITECT OF ANY DISCREPANCIES.

NON-FLOOD HAZARD

FLOOD ZONE DESIGNATION: ZONE X (MINIMAL RISK AREA WHERE FLOOD INSURANCE IS NOT MANDATORY) FLOOD INSURANCE RATE MAP (FIRM) PANEL 0980E DESIGNATION: MAP PARCEL NO. EFFECTIVE DATE OF FIRM: **BASE ELEVATION:** 0.2% ANNUAL CHANCE (500 YEAR) FLOODPLAIN COMMUNITY: CITY OF CAMARILLO

PATH OF TRAVEL

COMMUNITY NO.

LANDING AS

(E) CONCRETE -

A CLEAR SPACE OF 48" MIN. X RAMP WIDTH, AS

WITHIN MARKINGS OF ANY

SHOWN BY THIS HEAVY-DASHED

BOUNDARY, SHALL BE LOCATED

CURB, TYP.

\$\$\$\$\$\$\$

SHOWN BY THIS

BOUNDARY SHALL

SHALL ADJOIN AN

ACCESSIBLE

ROUTE

Existing Curb Cut, Typical

SCALE: 1/4" = 1'-0"

HEAVY-DASHED

HAVE 1:48 MAX.

SLOPE IN ALL DIRECTIONS AND - ACCESSIBLE ROUTES

CIRCULATION PATHS

WHERE OCCUR, TYP.

CROSS SLOPE, TYP.

(E) TRUNCARED

OR PEDESTRIAN

----- "ACCESSIBLE" PATH OF TRAVEL (P.O.T.) PER 03-114964 (CERTIFIED) PATH OF TRAVEL (P.O.T.) AS INDICATED IS A BARRIER FREE ACCESS IS AT LEAST 48" WIDE WITHOUT ANY ABRUPT VERTICAL CHANGES EXCEEDING 1/2" BEVELED AT 1:2 MAX. SLOPE, EXCEPT THAT LEVEL CHANGES DO NOT EXCEED 1/4 VERTICAL AND IS AT LEAST 48 INCHES WIDE, SURFACE IS SLIP RESISTANT, STABLE, FIRM AND SMOOTH, CROSS SLOPE DOES NOT EXCEED 2% AND SLOPE IN THE DIRECTION OF TRAVEL IS LESS THAN 5%, UNLESS OTHERWISE NOTED. P.O.T. SHALL BE MAINTAINED FREE OF OVERHANGING OBSTRUCTIONS TO 80" MINIMUM AND PROTRUDING OBJECTS GREATER THAN 4" PROJECTION FROM WALL AND ABOVE 27" AND LESS THAN 80". ARCHITECT TO VERIFY THAT ALL BARRIERS IN THE PATH OF TRAVEL HAVE BEEN REMOVED OR WILL BE REMOVED UNDER THIS PROJECT.

PATH OF TRAVEL (POT) AS VERIFIED BY ARCHITECT IS:

• A COMMON BARRIER FREE ACCESSIBLE ROUTE AT LEAST 48" WIDE WITHOUT ANY ABRUPT VERTICAL CHANGES EXCEEDING 1/2" BEVELED AT 1:2 MAXIMUM SLOPE, EXCEPT THAT LEVEL CHANGES DO NOT EXCEED 1/4"VERTICAL . THE PATH SURFACE IS SUP RESISTANT, STABLE, FIRM, AND SMOOTH. PASSING SPACES AT LEAST 60" X 60" ARE LOCATED NOT MORE THAN 200' APART. CONTINUOUS GRADIENTS HAVE 60" LEVEL AREAS NOT MORE THAN 400" APART. CROSS-SLOPE DOES NOT EXCEED 2%. . SLOPE IN THE DIRECTION OF TRAVEL IS LESS THAN 5% UNLESS OTHERWISE INDICATED AS A RAMP. . MAINTAIN POT FREE OF OVERHANGING OBSTRUCTIONS TO 80" MINIMUM,

PROTRUDING OBJECTS GREATER THAN 4" PROJECTION FROM WALL OR EDGE AND 27" ABOVE FINISH GRADE. FOR GRATINGS LOCATED IN THE SURFACE OF ANY PEDESTRIAN WAYS AT PATH OF TRAVEL, GRID/OPENINGS IN GRATINGS SHALL BE LIMITED TO 1/2" MAX. IN THE DIRECTION OF TRAFFIC FLOW. IF SUCH CONDITION OCCURS, PROVIDE MANUFACTURER CUTSHEETS OF GRATE PROVIDED.

GATES SERVING THE MEANS OF EGRESS SYSTEM SHALL COMPLY WITH THE REQUIREMENTS OF SECTION 1008. GATES USED AS A COMPONENT IN A MEANS OF EGRESS SHALL CONFORM TO THE APPLICABLE REQUIREMENTS FOR DOORS. PROVIDE LEVER HARDWARE AND KICKPLATE. FIRE AND LIFE SAFETY MAY REQUIRE PANIC HARDWARE FOR EMERGENCY EXITING EVEN WITH THE SIGN. COORDINATE WITH FIRE AND LIFE SAFETY REQUIREMENTS. DESIGN PROFESSIONAL IN GENERAL RESPONSIBLE CHARGE STATEMENT THE POT IDENTIFIED IN THESE CONSTRUCTION DOCUMENTS IS COMPLIANT WITH THE


CURRENT APPLICABLE CALIFORNIA BUILDING CODE ACCESSIBILITY PROVISIONS FOR PATH OF TRAVEL REQUIREMENTS FOR ALTERATIONS, ADDITIONS AND STRUCTURAL REPAIRS. AS PART OF THE DESIGN OF THIS PROJECT, THE POT WAS EXAMINED AND ANY ELEMENTS, COMPONENTS OR PORTIONS OF THE POT THAT WERE DETERMINED TO BE NON COMPLIANT 1. HAVE BEEN IDENTIFIED 2. THE CORRECTIVE WORK NECESSARY TO BRING THEM INTO COMPLIANCE HAS BEEN INCLUDED WITHIN THE SCOPE OF THIS PROJECT'S WORK THROUGH DETAILS, DRAWINGS AND SPECIFICATIONS INCORPORATED INTO THESE CONSTRUCTION DOCUMENTS.

DURING CONSTRUCTION, IF POT ITEMS WITHIN THE SCOPE OF THE PROJECT REPRESENTED AS CODE COMPLIANT ARE FOUND TO BE NON CONFORMING BEYOND REASONABLE CONSTRUCTION TOLERANCES, THEY SHALL BE BROUGHT INTO COMPLIANCE WITH THE CBC AS PART OF THIS PROJECT BY MEANS OF A CONSTRUCTION

BOTTOM Ø: 0.9"-0.92"-

(E) Truncated Domes

SECTION VIEW

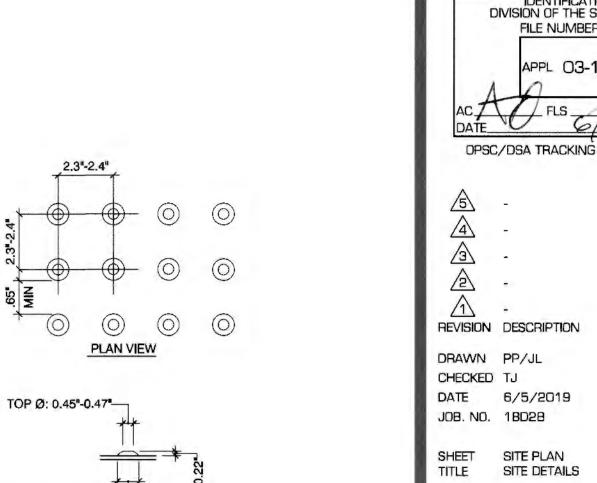

DSA STAMP & SIGNATURE IDENTIFICATION STAMP DIVISION OF THE STATE ARCHITECT FILE NUMBER: 56-H4 APPL 03-119903 OPSC/DSA TRACKING NUMBER: 72546-70 -/-/-

A-100

KRUGER BENSEN ZIEMER

199 FIGUEROA ST, SUITE 100A VENTURA CA 93001

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STAMP & SIGNATURE

ARCHITECTS, INC.

TODD A. JESPERSEN, AIA

TELEPHONE (805) 650-1033

JONATHAN D. LEE


ARCHITECTS

STAMP & SIGNATURE

ARCHITECTURAL ASSISTANT


PRINCIPAL-IN-CHARGE

Kruger-Bensen-Zlemer.

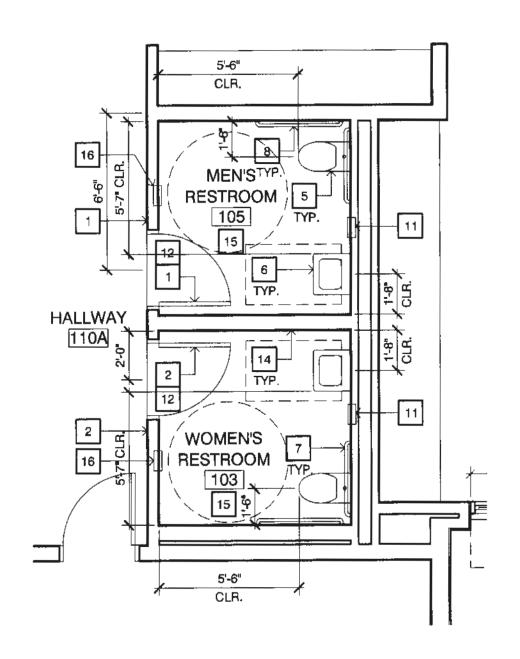

EXISTING STAFF RESTROOM


SCALE: 1/4" = 1'-0"

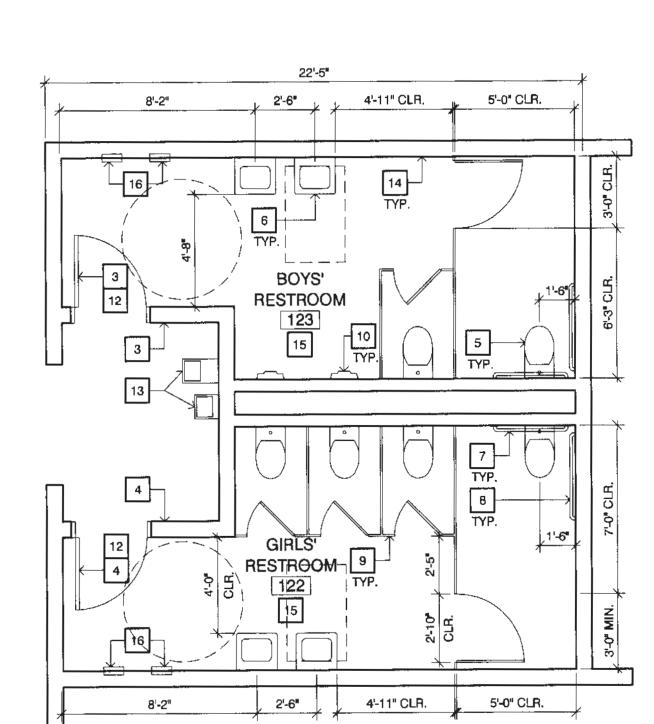

EXISTING BOYS' & GIRLS' RESTROOM

SCALE: 1/4" = 1'-0"



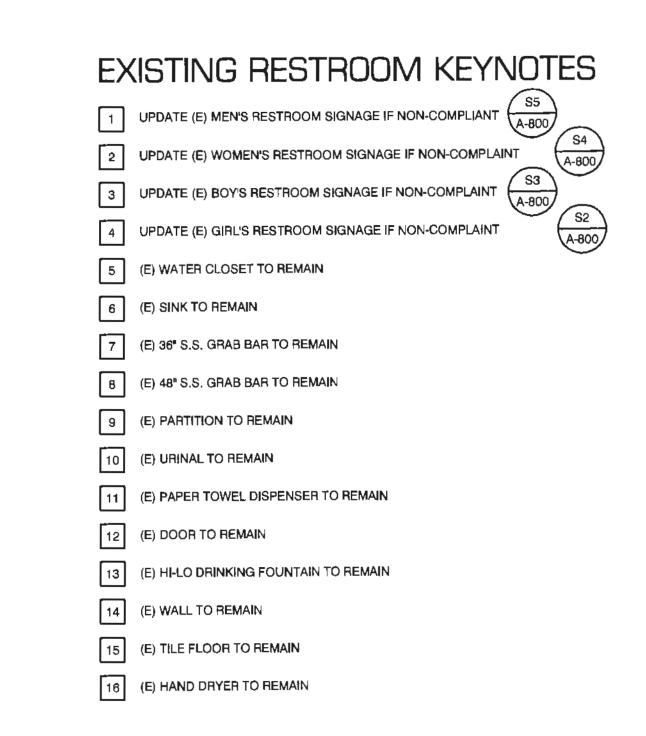




TÉLEPHONE (805) 650-1033 TODD A. JESPERSEN, AIA PRINCIPAL-IN-CHARGE JONATHAN D. LEE

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ENGINEER'S STAMP & SIGNATURE STAMP & SIGNATURE No. C-25839 No. C-25839 No. Ren. 06/30/2019


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-/-/-- REVISION DESCRIPTION

DRAWN JL.
CHECKED TJ
DATE 6/5/2019
JOB. NO. 18028

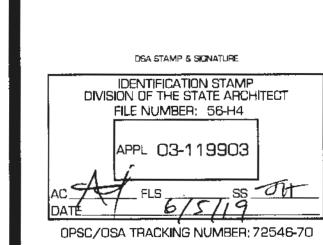
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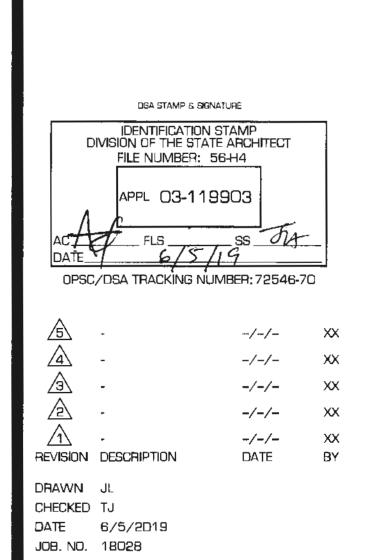


BUILDING 'A' FLOOR PLAN

SCALE: 1/8" = 1'-0"

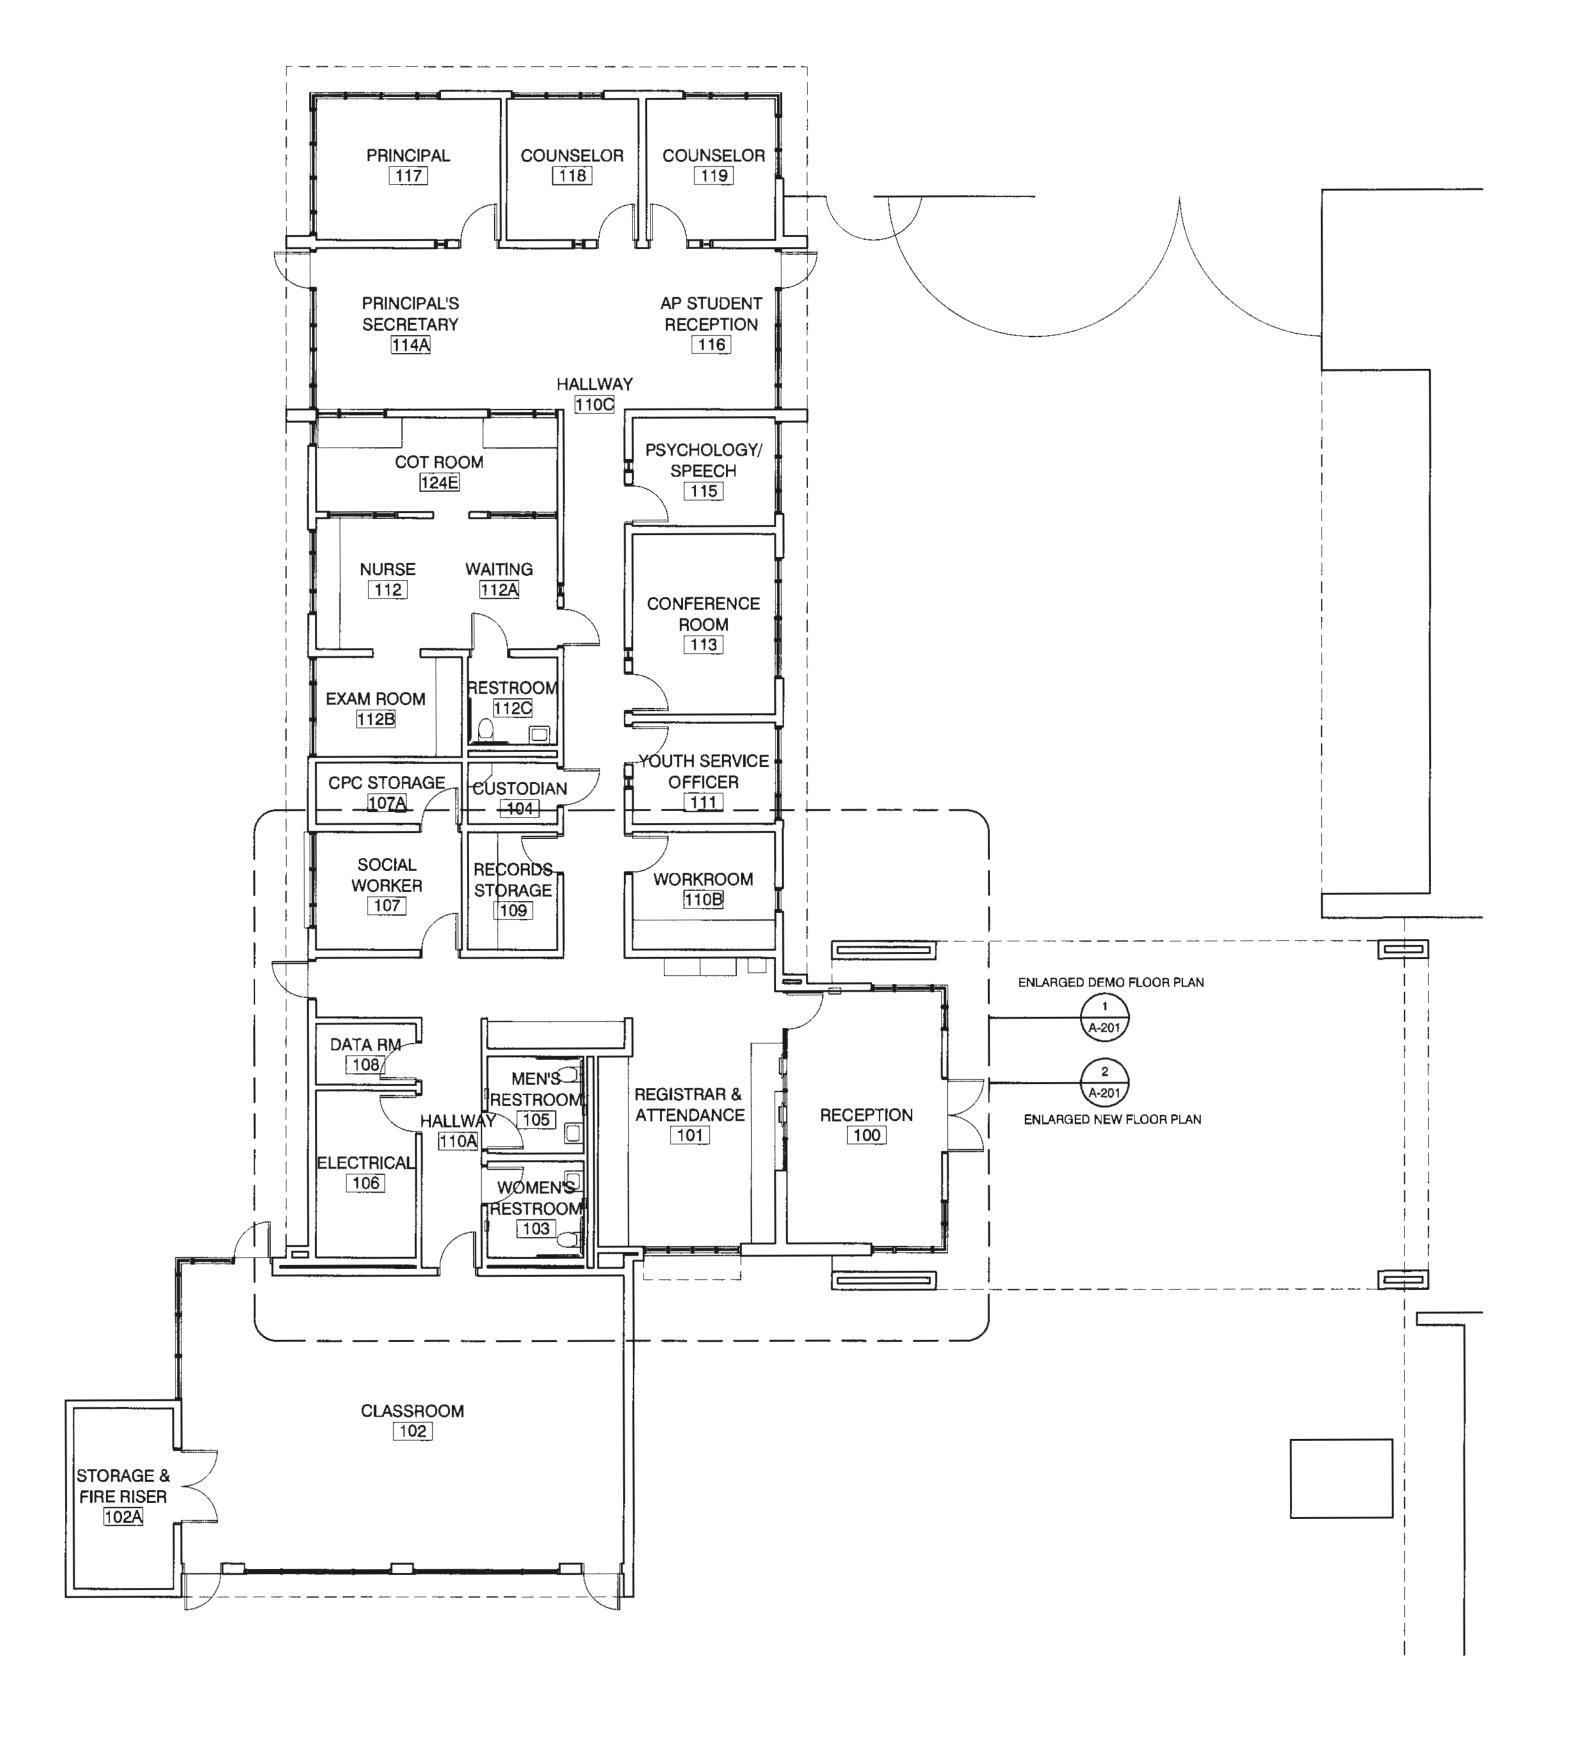




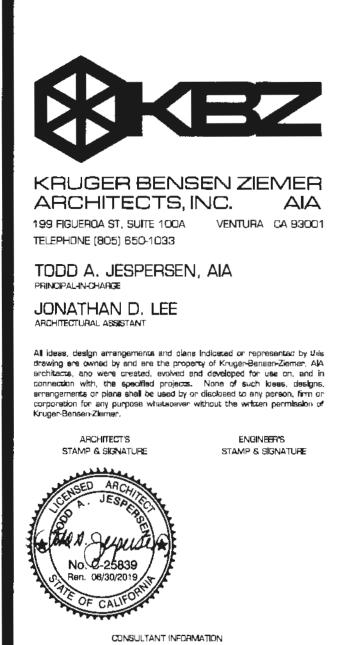


* A-200


SHEET BUILOING 'A' FLODR PLAN TITLE

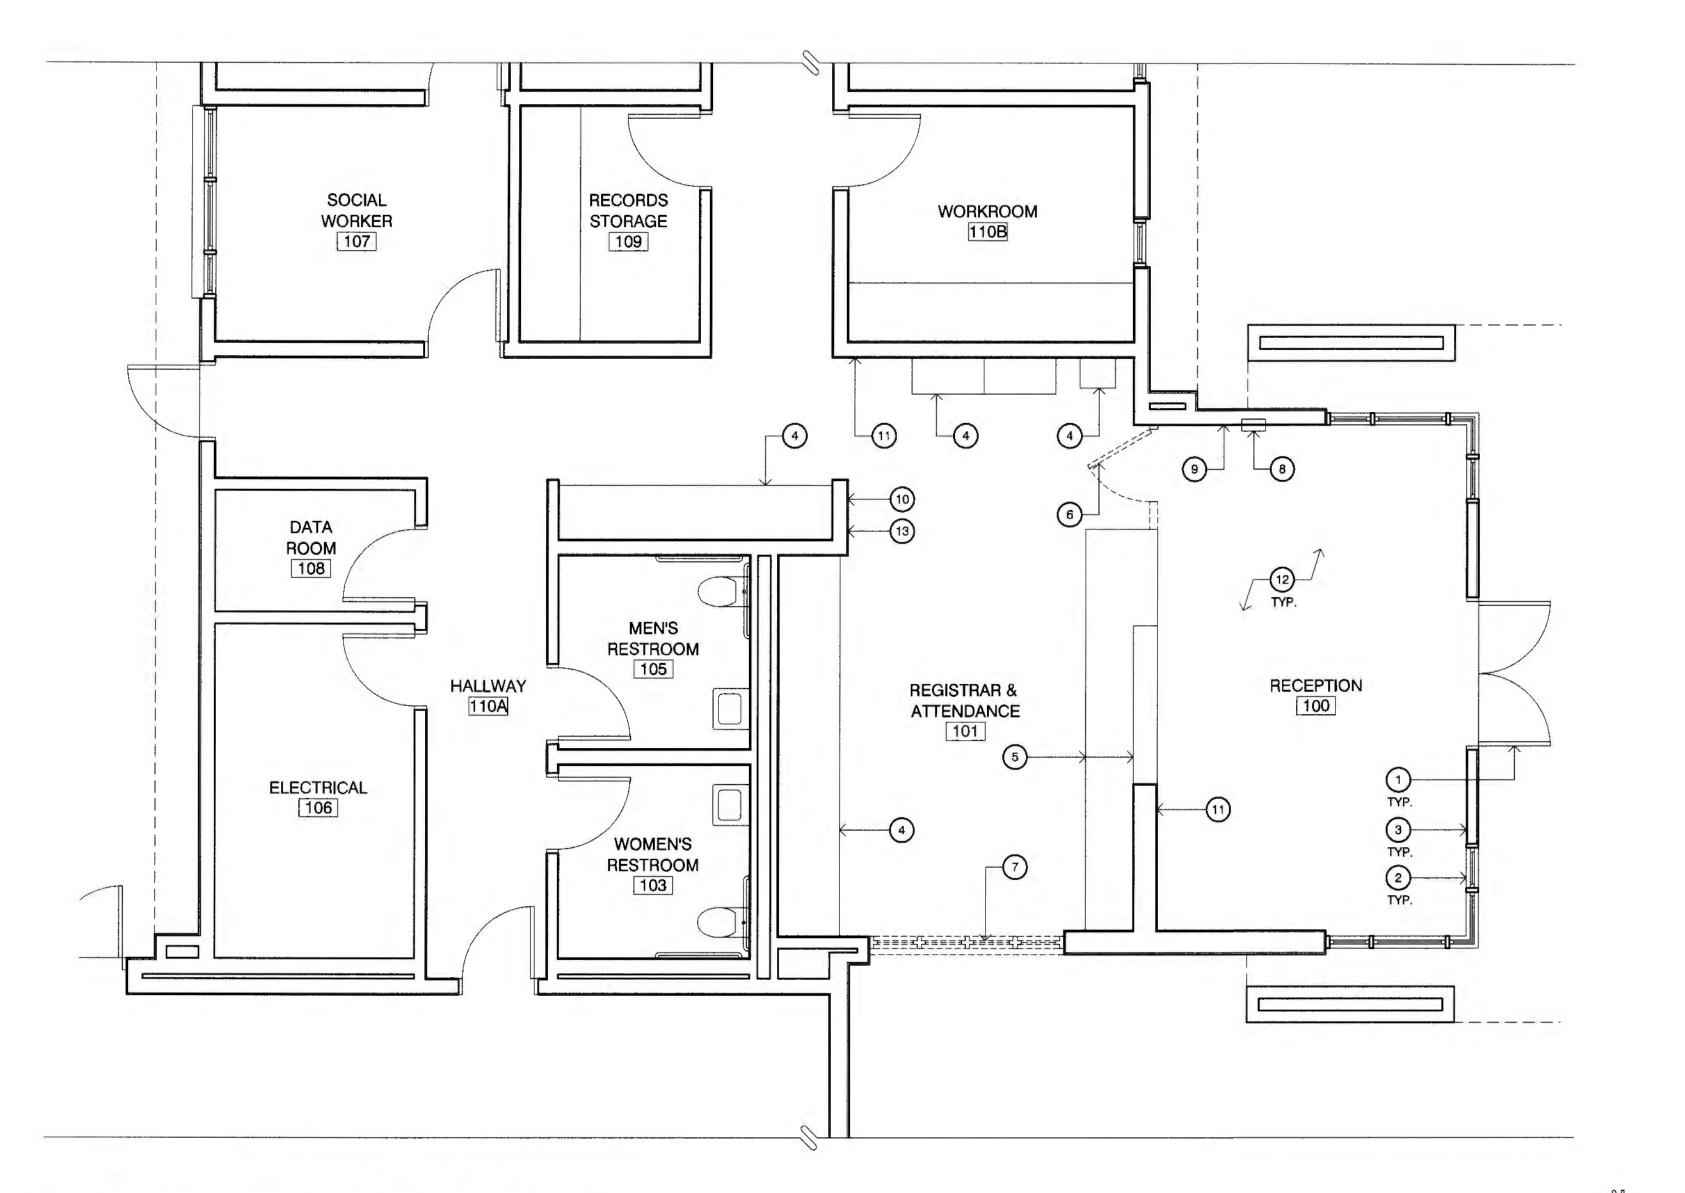



- (E) DOOR TO REMAIN
- (E) WINDOW TO REMAIN
- (E) WALL TO REMAIN
- (E) CABINET TO REMAIN
- (E) DESK WITH HI-LOW TRANSACTION COUNTERTOP TO REMAIN
- 6 REMOVE (E) DOOR
- 7 DEMO (E) WINDOW WITH TRANSACTION COUNTER
- (8) (E) FIRE EXTINGUISHER CABINET TO REMAIN
- (E) WALL OUTLET TO REMAIN
- (E) LIGHT SWITCH TO REMAIN
- (1) (E) FIRE ALARM HORN/STROBE TO REMAIN
- (E) VCT FLOORING TO REMAIN
- (E) FIRE ALARM PULL STATION TO REMAIN

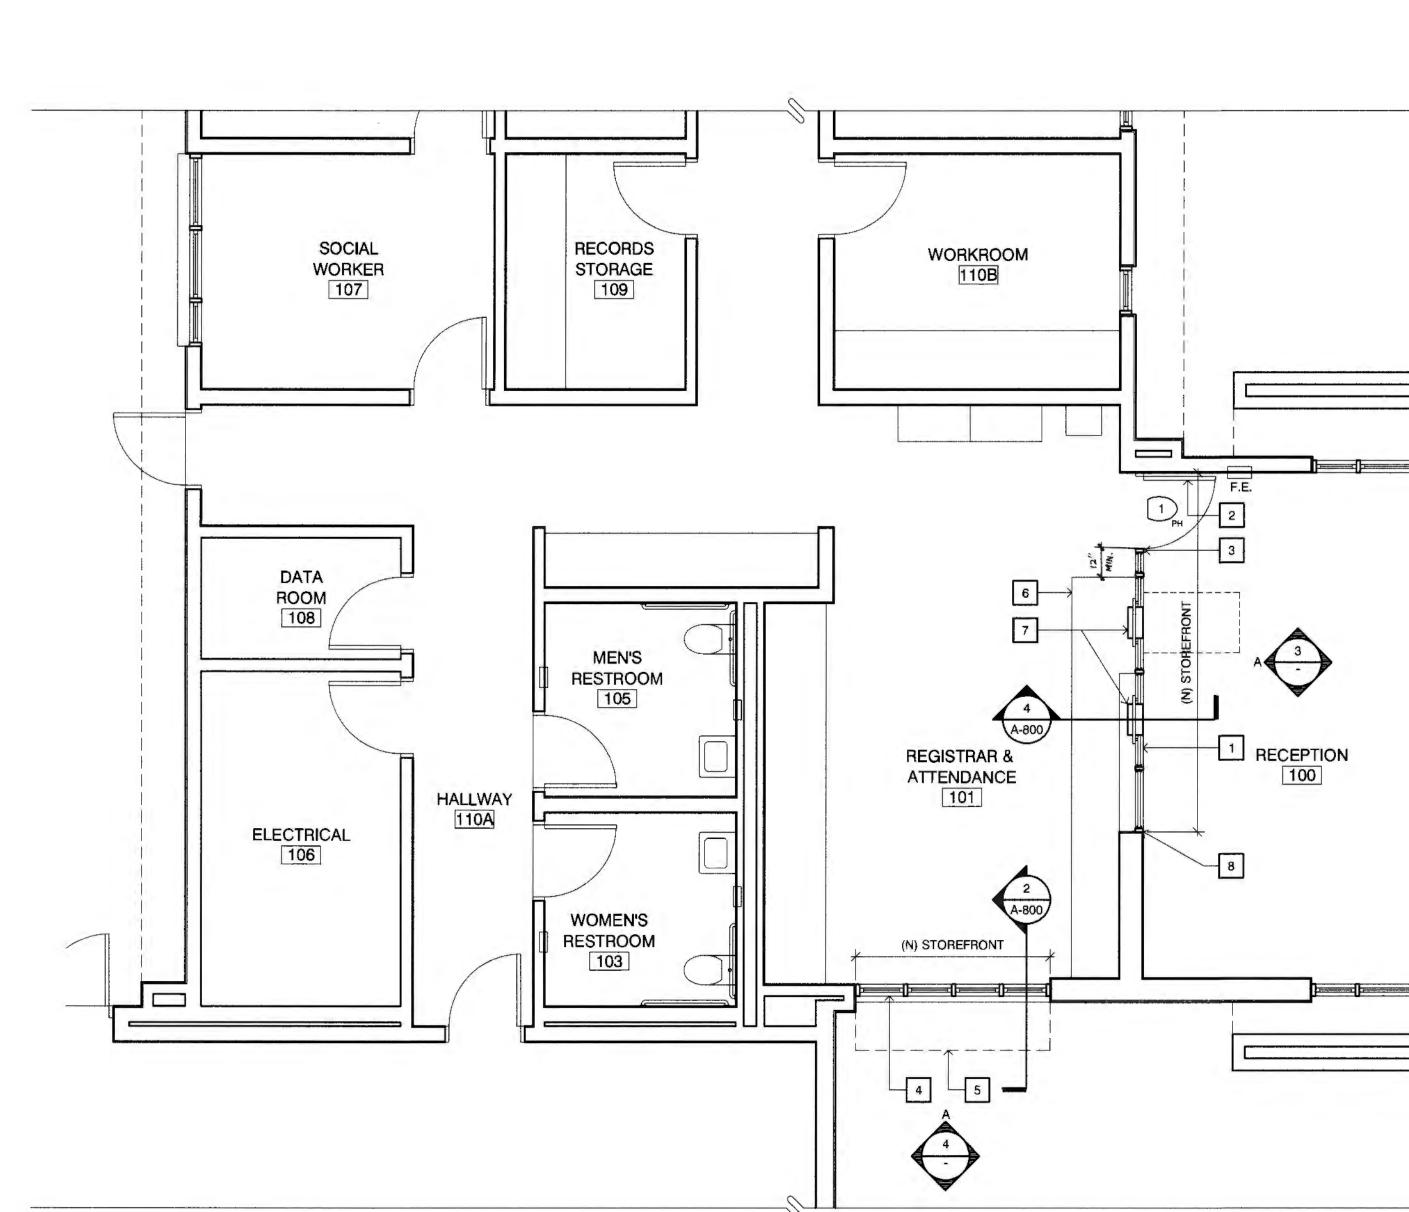

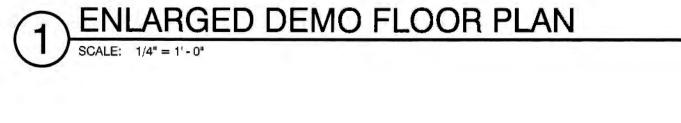

2 ENLARGED NEW FLOOR PLAN
SCALE: 1/4" = 1'-0"




- 1 (N) SECURITY STOREFRONT ASSEMBLY
- 2 (N) STOREFRONT DOOR
- 3 (N) ACCESS CARD READER
- 4 (N) PERMANENT FIXED STOREFRONT & NEW SLOPED SILL (2)
 A-800
- 5 (N) AWNING (A-800)
- 6 (N) DOOR ACCESS CONTROLS MOUNT IN FACE OF (E) CABINET
- 7 (N) BULLET-TRAP RECESSED CURRENCY TRAY INSTALL IN (E) COUNTERTOP
- 8 INSTALL (N) STOREFRONT FACE FLUSH WITH (E) WALL FACE

LEGEND

(E) HI-LO SOLID SURFACE CASEWORK TRANSACTION COUNTER

(E) RUBBER BASE

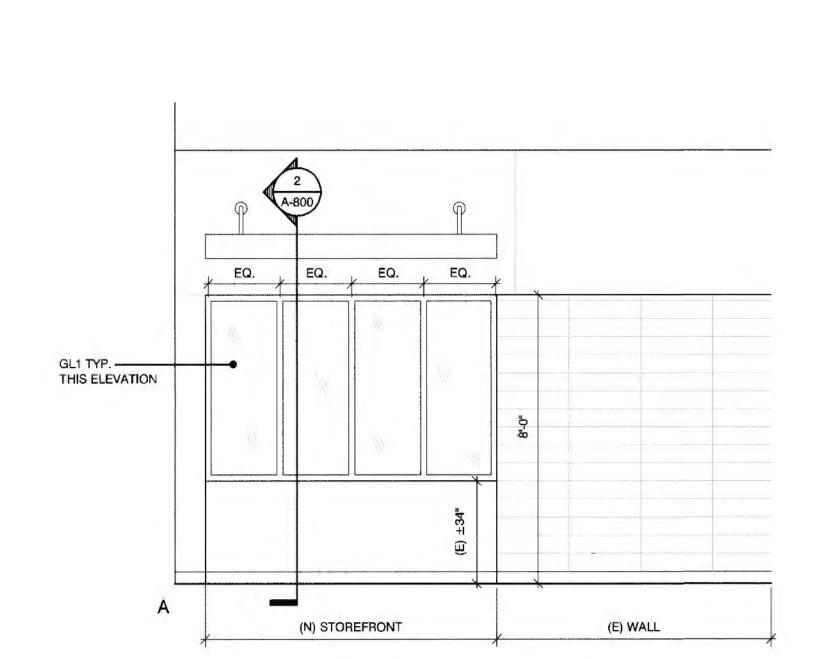

(E) WALL

GL1 TYP. THIS ELEVATION

(E) COUNTERTOP —


3 INTERIOR ELEVATION
SCALE: 3/8" = 1'-0"

6 A-800

(N) SECURITY STOREFRONT

INTERIOR ELEVATION

SCALE: 3/8" = 1'-0"

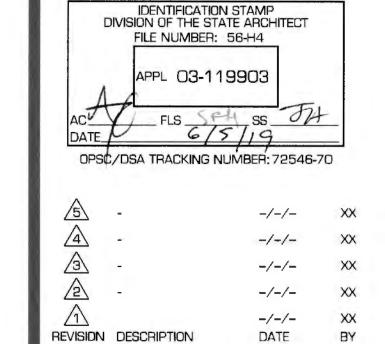

DSA STAMP & SIGNATURE

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199 FIGUEROA ST, SUITE 100A VENTURA CA 93001

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TODD A. JESPERSEN, AIA

JOB. NO. 1802B SHEET ENLARGED DEMO FLOOR PLAN TITLE ENLARGED NEW FLOOR PLAN INTERIOR ELEVATION

DRAWN JL CHECKED TJ

DATE 6/5/2019

A-201

PER SCHEDULE GL1 WHERE OCCUPS 3-6- (43* MAXX.)	
A	1 HM FRAME
DOOR TYPES SCALE: 1/4" = 1'-0"	DOOR FRAME TYPES SCALE: 1/4" = 1'-0"

DOOR SCHEDULE KEYNOTES

1 DOOR HARDWARE PROVIDED BY MODULAR PARTITION MANUFACTURER

SIGNAGE KEYNOTES

1 EXTERIOR PANEL SIGN

2 INTERIOR PANEL SIGN

GLAZING TYPES

GL1 BULLET-RESISTANT 1-1/4" LP 125 - LAMINATED (CLEAR)

ABBREVIATIONS

ALUM ALUMINUM

FF FACTORY FINISH

HM HOLLOW METAL

MFR PER MANUFACTURER

PT PAINTED SC WD SOLID CORE WOOD SS STAINLESS STEEL

GENERAL NOTES

SEE S1/A-800 FOR INTERIOR PANEL SIGNAGE MOUNTING HEIGHTS.

2. SEE DOOR & FRAME SCHEDULE FOR PANEL SIGNAGE ASSOCIATED w/ A DOOR,

SEE SHEET A-800 FOR SIGN DETAILS.

SIGNAGE NOTES

SK1 PANEL WALL MOUNT

DOORS NOTES

VERIFY ALL ROUGH OPENINGS DIMENSIONS PRIOR TO FABRICATION.

2. ALL DOORS SHALL HAVE LEVER HARDWARE U.O.N. DOOR HANDLES, PULLS, LATCHES, LOCKS, AND OTHER OPERATING DEVICES SHALL BE INSTALLED MINIMUM 34" AND MAXIMUM 48" ABOVE FINISH FLOOR. (CBC 1008.1.9.2).

3. ALL EXIT DOORS SHALL BE OPENABLE FROM INSIDE WITHOUT THE USE OF A KEY OR SPECIAL KNOWLEDGE (CBC 1008.1.9) AND THE FORCE REQUIRED TO PUSH OR PULL AN EGRESS DOOR TO THE OPEN POSITION SHALL NOT EXCEED 5 POUND (CBC 1008.1.3).

4. CONTRACTOR SHALL PROVIDE POWER AS NECESSARY FOR FULL OPERATION OF KEYPAD ACCESS.

5. PANIC HARDWARE SHALL CONTAIN A MINIMUM OF TWO LOCKING POINTS ON EACH DOOR. 6. GLAZING IN DOORS OR WITHIN 40" OF ANY DOOR LOCKING MECHANISM SHALL BE FULLY TEMPERED SAFETY GLASS.

7. ALL PEDESTRIAN DOORS AND GATES (EXCEPT SLIDING DOORS) SHALL BE PROVIDED WITH A

KICKPLATE AT THE BOTTOM 10 INCHES OF THE PUSH SIDE OF THE DOOR. 8. PROVIDE STEEL INSERTS AT STOREFRONTS AS REQUIRED.



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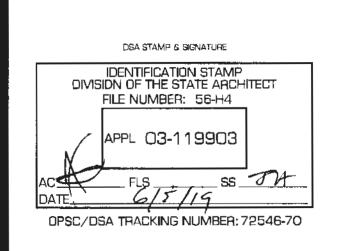
TODD A. JESPERSEN, AIA PRINCIPAL-IN-CHARGE JONATHAN D. LEE ARCHITECTURAL ASSISTANT

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CONSULTANT INFORMATION



REVISION DESCRIPTION

DRAWN JL
CHECKED TJ
DATE 6/5/2019
JOB. NO. 18D28

SHEET DODR SCHEDULE TITLE







PRINCIPAL-IN-CHARGE

JONATHAN D. LEE ARCHITECTURAL ASSISTANT

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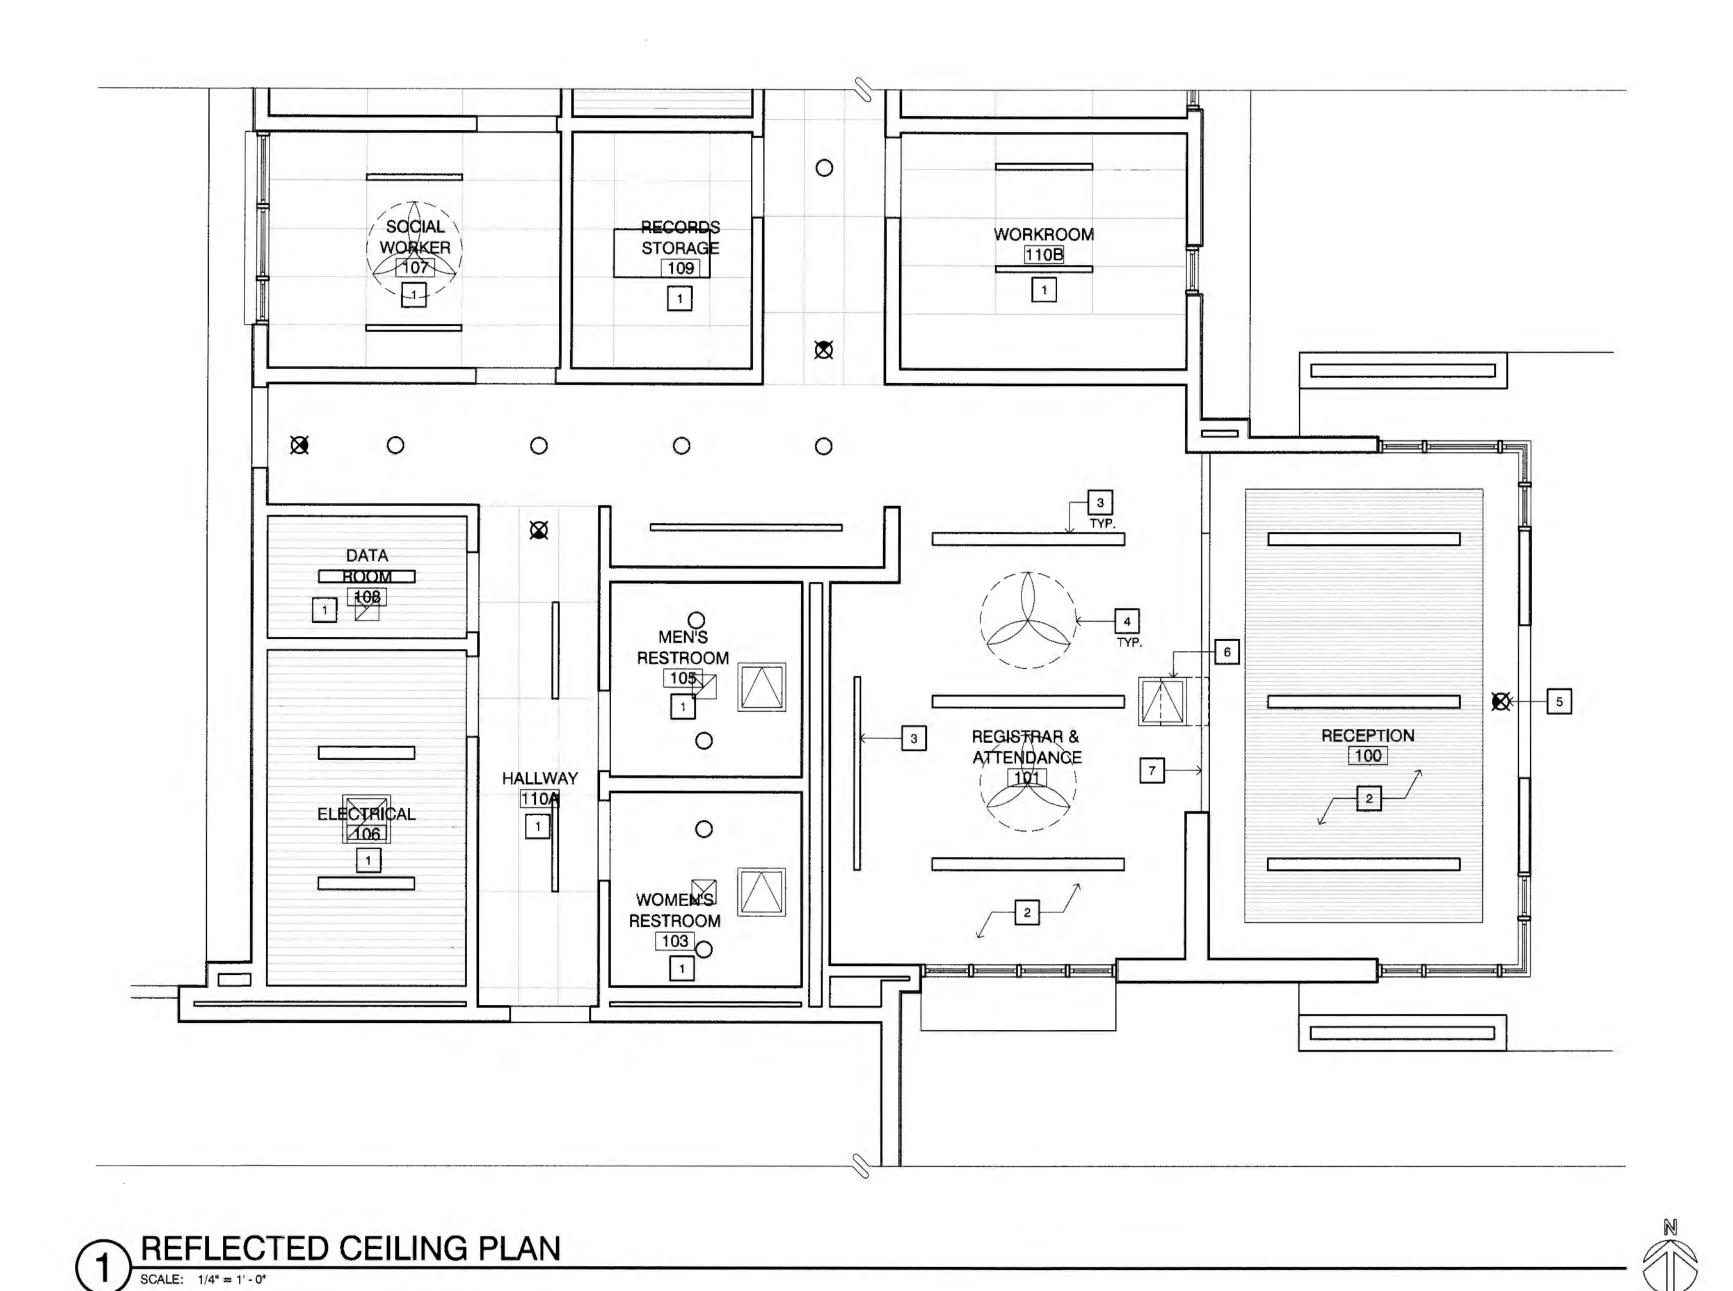
REVISION DESCRIPTION

DRAWN JL CHECKED TJ

DATE 6/5/2D19

JOB. NO. 18028

SHEET REFLECTED CEILING PLAN TITLE



CEILING PLAN KEYNOTES 1 NO WORK IN THIS ROOM

2 (E) CEILING TO REMAIN

3 (E) LIGHT FIXTURE TO REMAIN

4 (E) FAN TO REMAIN 5 (E) EXIT SIGN TO REMAIN

6 RELOCATE (E) ACCESS PANEL AND DAYLIGHT SENSOR

7 (N) SECURITY STOREFRONT ASSEMBLY

LEGEND


(E) LIGHT 1 - LINEAR PENDANT

(E) LIGHT 2 - LINEAR RECESSED

(E) 2'x4' LIGHT

(E) DOWNLIGHT

(E) ILLUMINATED EXIT SIGN

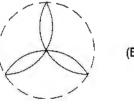

(E) 48" CEILING FAN

(E) ACCESS PANEL

ENGINEER'S

DATE

STAMP & SIGNATURE

