


# OXNARD UNION HIGH SCHOOL DISTRICT ADOLFO CAMARILLO HIGH SCHOOL CAMPUS SECURITY FENCING

4660 MISSION OAKS BLVD, CAMARILLO, CA 93012

## GENERAL NOTES

1. ANY DIFFERENCE BETWEEN THE EXISTING CONSTRUCTION AS OBSERVED IN THE FIELD AND AS SHOWN ON THE DRAWINGS SHALL BE REPORTED TO THE ARCHITECT BEFORE PROCEEDING WITH THE WORK.
2. THE CONTRACTOR SHALL VERIFY ALL DIMENSIONS PRIOR TO STARTING WORK THE ARCHITECT SHALL BE NOTIFIED OF ANY DISCREPANCIES OR INCONSISTENCIES. THE CONTRACTOR IS RESPONSIBLE FOR CHECKING AND COORDINATING ALL DIMENSIONS. REVIEW BUILDING LAYOUT WITH ARCHITECT BEFORE STARTING ANY FOOTING EXCAVATION OR FOUNDATION WORK.
3. THE CONTRACTOR IS RESPONSIBLE FOR VERIFYING ACTUAL SITE CONDITIONS REGARDLESS OF INFORMATION SHOWN ON THE DRAWINGS. DISCREPANCIES BETWEEN CONDITIONS SHOWN OR NOT SHOWN ON DRAWINGS AND ACTUAL EXISTING VISIBLE, DISCERNABLE CONDITIONS AT THE JOB SITE, DO NOT RELIEVE THE CONTRACTOR FROM PERFORMING THE WORK OF THIS CONTRACT IN FULL CONFORMANCE WITH THE CONTRACT DOCUMENTS.
4. IT SHALL BE THE RESPONSIBILITY OF THE GENERAL CONTRACTOR TO INSURE THAT ALL APPLICABLE SAFETY LAWS ARE STRICTLY ENFORCED AND TO MAINTAIN A SAFE CONSTRUCTION PROJECT.
5. ANY DAMAGE DONE TO THE EXISTING SITE, FACILITIES, FINISHES, EQUIPMENTS AND DEVICES DURING THE COURSE OF THE WORK SHALL BE REPAIRED OR REPLACED BY THE CONTRACTOR AT HIS OWN EXPENSE WITH NO ADDITIONAL COST TO THE OWNER.
6. ALL NEW WORK SHALL MATCH EXISTING IN KEEPING WITH GOOD CONSTRUCTION PRACTICE. IT IS THE INTENT OF THESE DOCUMENTS THAT THE PORTION OF THE SURFACE WHICH HAS BEEN INSTALLED, REPAIRED OR REPLACED, SHALL MATCH THE EXISTING ADJACENT SURFACES, AND THAT THE NEW WORK WILL NOT BE DISCERNABLE FROM THE EXISTING.
7. CONTRACTOR SHALL NOTIFY THE ARCHITECT IMMEDIATELY OF ALL OMISSIONS AND CONFLICTS BETWEEN THE ELEMENTS OF THE CONTRACT DOCUMENTS BEFORE PROCEEDING WITH THE WORK INVOLVED.
8. CONTRACTOR SHALL PROTECT ALL EXISTING STRUCTURAL, MECHANICAL, PLUMBING, ELECTRICAL, LANDSCAPE SITE FEATURES TO REMAIN. ALL DAMAGED WORK SHALL BE REPLACED WITH THE SAME MATERIALS, INCLUDING MATCHING THE EXISTING COLORS AND TEXTURES.
9. CFC 1030.1 - THE MEANS OF EGRESS FOR BUILDING OR PORTIONS THEREOF SHALL BE MAINTAINED IN ACCORDANCE WITH THIS SECTION.
10. CFC 1030.4 - EXIT SIGNS SHALL BE INSTALLED AND MAINTAINED IN ACCORDANCE WITH SECTION 1011.
11. CFC 503.1; TITLE 19 DIVISION 1, 3.05 - MAINTAIN FIRE ACCESS ROUTE(S). PUBLIC STREET ACCESS - EXISTING NO PARKING FIRE LANE SIGN TO BE FIELD VERIFIED BY IOR.
12. CFC 506.1 - MAINTAIN KEY BOXES FOR FIRE DEPARTMENT ACCESS, AS APPROPRIATE.
13. THE PROVISIONS OF CFC & CBC & CFC CHAPTER 35 SHALL BE ENFORCED ON THIS PROJECT.

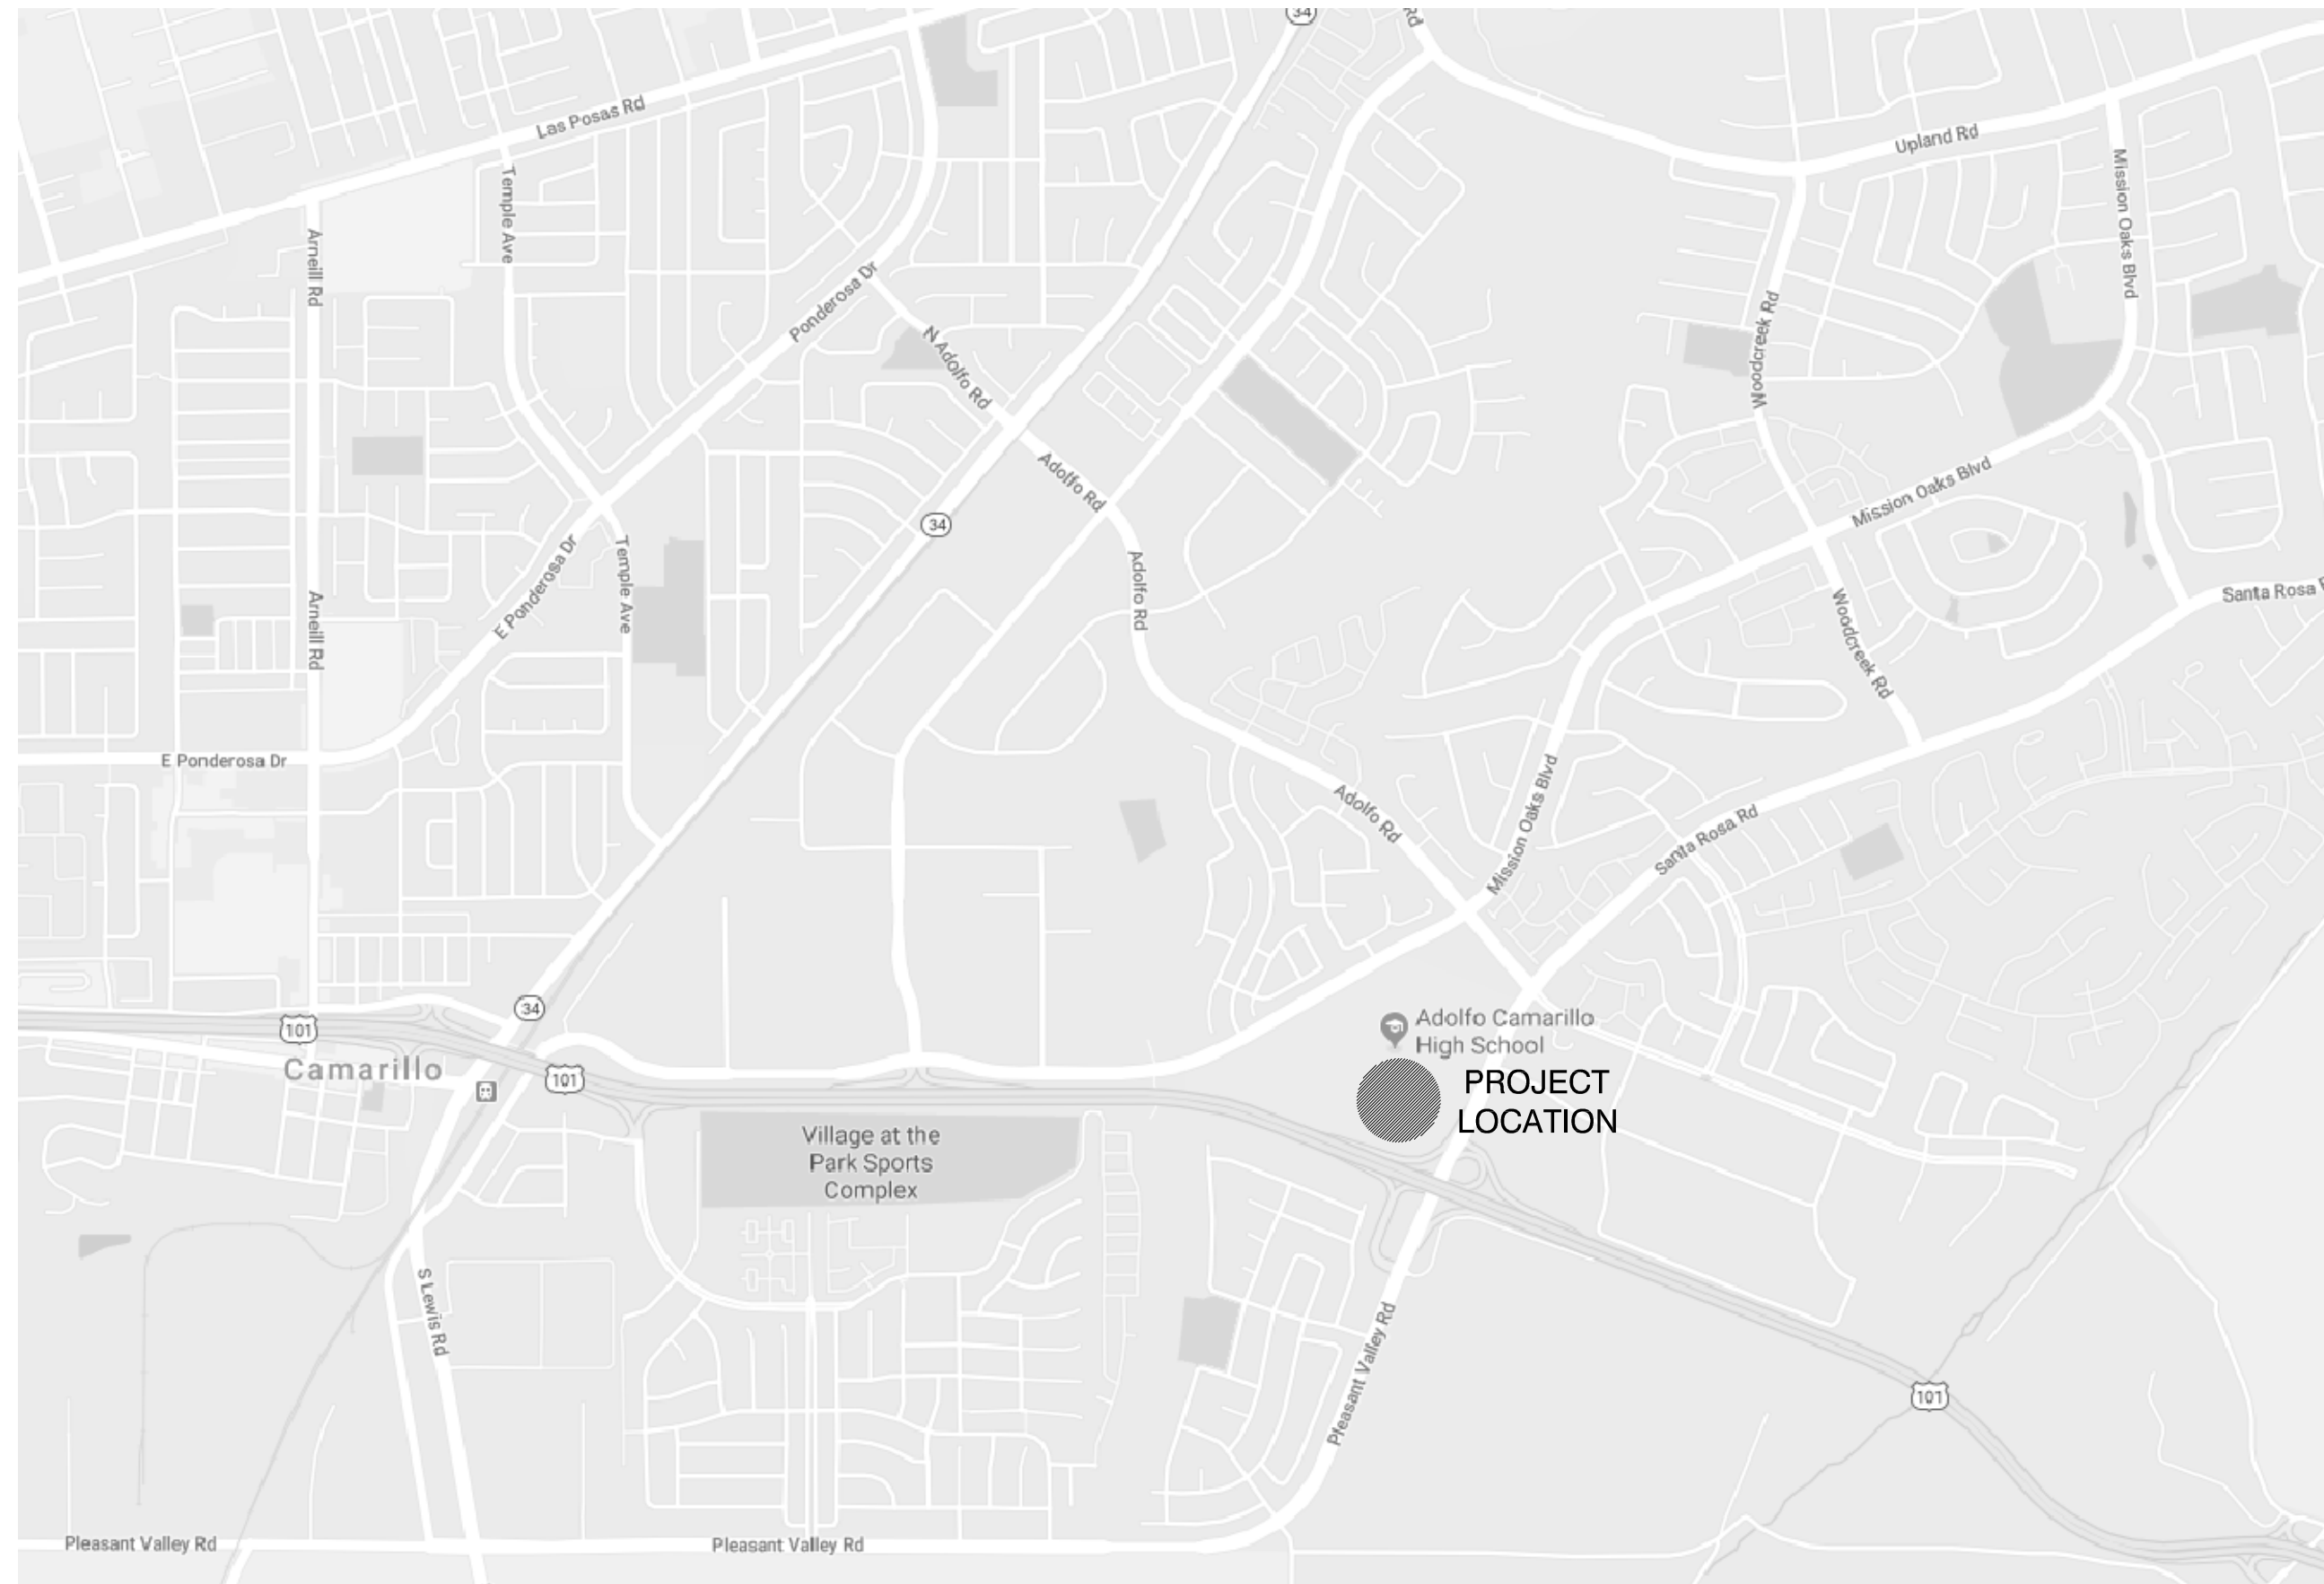

## VICINITY MAP

SCALE: N.T.S.

## GENERAL REQUIREMENTS:

1. ALL WORK SHALL CONFORM TO 2016 EDITION TITLE 24, CALIFORNIA CODE OF REGULATIONS (CCR).
2. CHANGES TO THE APPROVED DRAWINGS AND SPECIFICATIONS SHALL BE MADE BY ADDENDUM OR CONSTRUCTION CHANGE DOCUMENT (CCD) APPROVED BY THE DIVISION OF THE STATE ARCHITECT, AS REQUIRED BY SECTION 4-338, PART 1, TITLE 24, CCR.
3. A DSA CERTIFIED PROJECT INSPECTOR EMPLOYED BY THE DISTRICT (OWNER) AND APPROVED BY THE DIVISION OF THE STATE ARCHITECT SHALL PROVIDE CONTINUOUS INSPECTION OF THE WORK. THE DUTIES OF THE INSPECTOR ARE DEFINED IN SECTION 4-342, CALIFORNIA BUILDING STANDARDS ADMINISTRATIVE CODE (PART 1, TITLE 24, CCR).
4. A DSA CERTIFIED INSPECTOR WITH CLASS 1 CERTIFICATION IS REQUIRED FOR THIS PROJECT.
5. THE INTENT OF THESE DRAWINGS AND SPECIFICATIONS IS THAT THE WORK OF THE ALTERATION, REHABILITATION OR RECONSTRUCTION IS TO BE IN ACCORDANCE WITH TITLE 24, CALIFORNIA CODE OF REGULATIONS. SHOULD ANY EXISTING CONDITIONS SUCH AS DETERIORATION OR NON-COMPLYING CONSTRUCTION BE DISCOVERED WHICH IS NOT COVERED BY THE CONTRACT DOCUMENTS WHERE-IN THE FINISHED WORK WILL NOT COMPLY WITH TITLE 24, CALIFORNIA CODE OF REGULATIONS, A CONSTRUCTION CHANGE DOCUMENT (CCD), OR A SEPARATE SET OF PLANS AND SPECIFICATIONS, DETAILING AND SPECIFYING THE REQUIRED WORK SHALL BE SUBMITTED TO AND APPROVED BY THE DIVISION OF THE STATE ARCHITECT BEFORE PROCEEDING WITH THE WORK.

## APPLICABLE CODES

CONSTRUCTION SHALL COMPLY WITH THE FOLLOWING:

PART 1	2016 CALIFORNIA ADMINISTRATIVE CODE (CAC), TITLE 24 C.C.R.
PART 2	2016 CALIFORNIA BUILDING CODE (CBC), TITLE 24 C.C.R.
PART 3	2016 CALIFORNIA ELECTRICAL CODE (CEC), TITLE 24 C.C.R.
PART 4	2016 CALIFORNIA MECHANICAL CODE (CMC), TITLE 24 C.C.R.
PART 5	2016 CALIFORNIA PLUMBING CODE (CPC), TITLE 24 C.C.R.
PART 6	2016 CALIFORNIA ENERGY CODE, TITLE 24 C.C.R.
PART 8	2016 CALIFORNIA HISTORICAL BUILDING CODE, TITLE 24 C.C.R.
PART 9	2016 CALIFORNIA FIRE CODE (CFC), TITLE 24, C.C.R.
PART 10	2016 CALIFORNIA EXISTING BUILDING CODE (CEBC), TITLE 24, C.C.R.
PART 11	2016 CALIFORNIA GREEN BUILDING STANDARDS CODE (CALGREEN), TITLE 24, C.C.R.
PART 12	2016 CALIFORNIA REFERENCED STANDARDS CODE, TITLE 24, C.C.R.

PARTIAL LIST OF APPLICABLE STANDARDS:

NFPA 13 AUTOMATIC SPRINKLER SYSTEMS (CALIFORNIA AMENDED)	2016 EDITION
NFPA 14 STANDPIPE SYSTEMS (CALIFORNIA AMENDED)	2013 EDITION
NFPA 17 DRY CHEMICAL EXTINGUISHING SYSTEMS	2013 EDITION
NFPA 17A WET CHEMICAL EXTINGUISHING SYSTEMS	2013 EDITION
NFPA 20 STATIONARY PUMPS	2016 EDITION
NFPA 24 PRIVATE FIRE SERVICE MAINS (CALIFORNIA AMENDED)	2016 EDITION
NFPA 72 NATIONAL FIRE ALARM & SIGNALING CODE (CA, AMENDED)	2016 EDITION
NFPA 80 FIRE DOOR AND OTHER OPENING PROTECTIVES	2016 EDITION
NFPA 253 CRITICAL RADIANT FLUX OF FLOOR COVERING SYSTEMS	2015 EDITION
NFPA 2001 CLEAN AGENT FIRE EXTINGUISHING SYSTEM (CA, AMENDED)	2015 EDITION
NATIONAL REFERENCE STANDARDS:	
AISC SEISMIC PROVISIONS FOR STRUCTURAL STEEL BUILDINGS (ANSI/AISC 341-10)	
AISC SPECIFICATION FOR STRUCTURAL STEEL BUILDINGS (ANSI/AISC 360-10)	
NATIONAL DESIGN SPECIFICATION (NDS) FOR WOOD CONSTRUCTION (ANSI/AWS NDS 2015)	
ACI-318-14 BUILDING CODE REQUIREMENTS FOR STRUCTURAL CONCRETE	

## ABBREVIATIONS

ABV	ABOVE	FG	FINISH GRADE	PLAS	PLASTIC
AFF	ABOVE FINISHED FLOOR	FIXT	FIXTURE	PLAM	LAMINATE
ADJ	ADJUSTABLE / ADJACENT	FLSH	FLASHING	PL	PLATE
A/C	AIR CONDITIONING	FHMS	FLATHEAD MACHINE SCREW	PLYWD	PLYWOOD
ALT	ALTERNATE	FHWS	FLATHEAD WOOD SCREW	POC	POINT OF CONNECTION
ALUM	ALUMINUM	FLR	FLOOR (ING)	PVC	POLYVINYL CHLORIDE
AS	ANCHOR BOLT	FLUOR	FLUORESCENT	PCF	POUNDS PER CUBIC FOOT
&	AND	FT	FOOT OR FEET	PSF	POUNDS PER SQUARE FOOT
<	ANGLE	FTG	FOOTING	PT	PRESSURE TREATED
ANOD	ANODIZED	FND	FOUNDATION	RAD	RADIUS
APPROX	APPROXIMATE	FURR	FURRING	REF	REFERENCE
ARCH	ARCHITECT (URAL)	GA	GAGE / GAUGE	REFR	REFRIGERATOR
ASPH	ASPHALT	GALV	GALVANIZED	REG	REGISTER
AC	ASPHALT CONCRETE	GRND	GROUND	REINF	REINFORCED
⊕	AT	GYP	GYPHUM	REQ'D	REQUIRED
AUTO	AUTOMATIC	HDR	HARDWARE	RESIL	RESILIENT
BM	BEAM	HDR	HEADER	RET	RETAINING
BLKG	BLOCKING	HRT	HEATING	R/A	RETURN AIR
BD	BOARD	HVAC	HEATING VENTILATING & AIR CONDITIONING	REV	REVISION(S) / REVISED
BOT	BOTTOM	HTG	HEATING	RH	RIGHT HAND
BN	BOUNDARY NAILING	HT	HEIGHT	RD	ROOF DRAIN
BLDG	BUILDING	HC	HOLLOW CORE	RFG	ROOFING
BUR	BUILT UP ROOFING	HM	HOLLOW METAL	ROOM	ROOM
CAB	CABINET	HOR	HORIZONTAL	ROUGH	ROUGH OPENING
CPT	CARPET (ED)	ICV	IRRIGATION CONTROL VALVE	ROUND	ROUND HEAD MACHINE SCREW
CLG	CEILING	ID	INSIDE DIAMETER	RHWS	ROUND HEAD WOOD SCREW
CEM	CEMENT	INSUL	INSULATION	SHT	SHEET
CER	CERAMIC	INT	INTERIOR	SHTG	SHEATHING
CIR	CIRCLE	JAN	JANITOR	SMS	SHEET METAL SCREW
COL	COLUMN	SC	CONCRETE	SHWR	SHOWER
CONC	CONCRETE MASONRY UNIT	L	LENGTH / LONG	SIM	SIMILAR
CMU	CONCRETE MASONRY UNIT	LAB	LABORATORY	S	SOUTH
CONN	CONNECTION	LAM	LAMINATE (D)	SPK	SPEAKER
CONST	CONSTRUCTION	LAV	LAVATORY	SPEC	SPECIFICATION (S)
CJ	CONSTRUCTION JOINT	LB	POUND	SQ	SQUARE
CONT	CONTINUOUS/CONTINUE	LF	LINEAR FEET	SS	STAINLESS STEEL
CNTK	COUNTER SINK	LT	LIGHT	STD	STANDARD
DEM	DEMOLISH / DEMOLITION	LVR	LOUVER	STL	STEEL
DET	DETAIL	MB	MACHINE BOLT	STOR	STORAGE
DIAG	DIAGONAL	MH	MANHOLE	STRUCT	STRUCTURE / STRUCTURAL
DIA	DIAMETER	MFR	MANUFACTURE (R)	SUSP	SUSPENDED
DIM	DIMENSION	MAT	MATERIAL (S)	SYS	SYSTEM
DIV	DIVISION	MAX	MAXIMUM	TEL	TELEPHONE
DR	DOOR	MECH	MECHANIC (AL)	TV	TELEVISION
DBL	DOUBLE	MBR	MEMBER	THK	THICK (NESS)
DN	DOWN	MTL	METAL	TP	TOP OF PAVEMENT
DWG	DRAWING	MIN	MINIMUM	TOP	TOP OF STEEL
DF	DRINKING FOUNTAIN/ DOUGLAS FIR	MTD	MOUNT (ED)	TW	TOP OF WALL
		MTG	MOUNTING	T	TREAD
		NAT	NATURAL	TS	TUBULAR STEEL
		(N)	NEW	TYP	TYPICAL
		N	NORTH	UN	UNLESS OTHERWISE NOTED
		NIC	NOT IN CONTRACT	VERT	VERTICAL
		NOM	NOMINAL	VG	VERTICAL GRAIN
		NTS	NOT TO SCALE	VCT	VINYL COMPOSITION TILE
		#	NUMBER	WCST	WAINSCOT
		OC	ON CENTER (S)	WC	WATER CLOSET
		OD	OUTSIDE DIAMETER	WH	WATER HEATER
		OPN	OPENING	WP	WATERPROOF (ING)
		OPP	OPPOSITE	WR	WATER RESISTANT
		O/V	OVER	WT	WEIGHT
		PR	PAIR	W	WEST / WOMEN / WIDE
		PNL	PANEL	WDW	WINDOW
		PKG	PARKING	W/O	WITH
		PTN	PARTITION	WD	WITHOUT
		PVMT	PAVEMENT		WOOD
		PERF	PERFORATE (D)		
		PERM	PERIMETER		

## SYMBOLS LEGEND

KEY NOTE SYMBOLS	1 (NEW)	DIMENSION LINES	8'-0"
	1 (DEMO)		
ROOM NUMBER (SEE ROOM LEGEND)	101	ACCESSIBLE WHEELCHAIR SPACE, 30" W x 48" D CLEAR FLOOR SPACE, 27" H CLEAR KNEE SPACE MIN. 34" H MAX. TO TOP OF TABLE/COUNTER.	
DOOR NUMBER - SEE DOOR AND FRAME SCHEDULE	1	60" DIAMETER CLEAR WHEELCHAIR TURNING CIRCLE	
WINDOW NUMBER - SEE WINDOW SCHEDULE	X	INDICATES REQUIRED CLR. FLSR SPACE AT DOOR OPENINGS.	
WALL TYPE	X	WORK CONTROL/DATUM	
WALL TYPE NOTE (MODIFIES WALL TYPE)	X	BREAK LINE	
DETAIL SYMBOL	7 - DETAIL NO. / AS.1 - SHEET NO.	CENTER LINE	
DETAIL CUT SYMBOL	7 - DETAIL NO. / AS.1 - SHEET NO.	GRID LINE SYMBOL	1
ELEVATIONS	A - ELEVATION NO. / AS.0 - DRAWING NO. / B - SHEET NO. / C	MATCHLINE SYMBOL	
SECTION/ELEVATION KEY	1 - SECTION / ELEVATION NO. / A1.0 - SHEET NO.	REVISION NO. AREA OF REVISION	
		PROJECT REFERENCE NORTH	

## SHEET INDEX (4 SHEETS TOTAL)

### GENERAL

1. G-001 TITLE SHEET

### ARCHITECTURAL

2. A-100 SITE PLAN
3. A-200 ENLARGED GATE PLANS
4. A-700 DETAILS

## PROJECT SCOPE

THE PROJECT IS TO PROVIDE A SECURED CAMPUS BY INSTALLING NEW SITE FENCING. SCOPE INCLUDES DEMOLITION AS REQUIRED TO COMPLETE SCOPE OF WORK.

## PROJECT DATA

4660 MISSION OAKS BLVD., CAMARILLO, CA 93012  
FIRE DISTRICT : COUNTY OF VENTURA  
FLOOD ZONE DESIGNATION : ZONE X  
NO NEW SQUARE FOOTAGE  
NO CHANGE TO THE NUMBER OF PARKING SPACES

## DESIGN DATA

WIND DESIGN DATA (2016 CBC 1603A.1.4)  
1. ULTIMATE DESIGN WIND SPEED V=110 MPH  
2. RISK CATEGORY II  
3. WIND EXPOSURE CATEGORY C  
4. INTERNAL PRESSURE COEFFICIENT +/- 0.18  
5. ENCLOSURE CLASSIFICATION ENCLOSED  
EARTHQUAKE DESIGN DATA (2016 CBC 1603A.1.5)  
SITE COORDINATES: 34.21813°N, 119.00840°W  
1. RISK CATEGORY II  
2. SEISMIC IMPORTANCE FACTOR I=1.00  
3. MAPPED SPECTRAL RESPONSE ACCELERATION PARAMETERS S<sub>s</sub>=2.209g S<sub>1</sub>=0.795g  
4. SITE CLASS D  
5. DESIGN SPECTRAL RESPONSE ACCELERATION PARAMETERS S<sub>DS</sub>=1.472g S<sub>D1</sub>=0.795g  
GEOTECHNICAL INFORMATION (2016 CBC 1603A.1.6)  
1. ALLOWABLE SOIL BEARING PRESSURE = 1,500 PSF

## PROJECT TEAM

ARCHITECT  
KRUGER BENSEN ZIEMER ARCHITECTS, INC.  
199 FIGUEROA STREET, SUITE 100A, VENTURA, CA 93001  
OFFICE: (805) 650-1033  
PRINCIPAL-IN-CHARGE: TODD A. JESPERSEN, AIA  
EMAIL ADDRESS: toddj@kbzarch.com  
PROJECT TEAM:  
JONATHAN D. LEE  
EMAIL ADDRESS: jonathan@kbzarch.com

## OWNER

OXNARD UNION HIGH SCHOOL DISTRICT  
309 S. "K" STREET, OXNARD, CA 93030  
OFFICE: (805) 385-2500  
CONTACT: JOSHUA BROWN  
EMAIL ADDRESS: joshua.brown@oxnardunion.org

OXNARD UNION HIGH SCHOOL DISTRICT  
ADOLFO CAMARILLO HIGH SCHOOL  
4660 MISSION OAKS BLVD, CAMARILLO, CA 93012  
CAMPUS SECURITY FENCING




KRUGER BENSEN ZIEMER ARCHITECTS, INC.  
199 FIGUEROA ST, SUITE 100A VENTURA, CA 93001  
TELEPHONE (805) 650-1033

TODD A. JESPERSEN, AIA  
PRINCIPAL-IN-CHARGE  
JONATHAN D. LEE  
ARCHITECTURAL ASSISTANT

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ARCHITECTS STAMP & SIGNATURE ENGINEERS STAMP & SIGNATURE

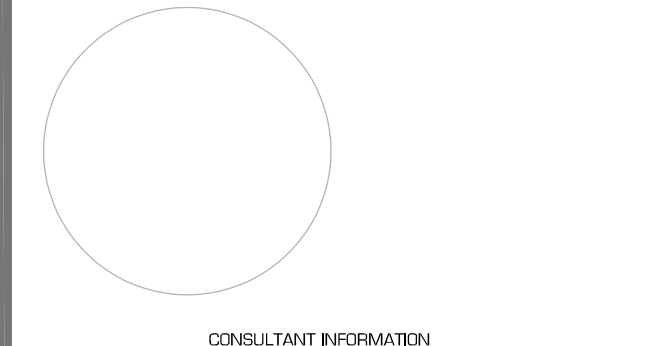

CONSULTANT INFORMATION

REVISION	DESCRIPTION	DATE	BY
1	ADD	3/23/2020	JDL
2	ADD	3/23/2020	JDL
3	ADD	3/23/2020	JDL
4	ADD	3/23/2020	JDL
5	ADD	3/23/2020	JDL

PROJECT TEAM:  
JONATHAN D. LEE  
EMAIL ADDRESS: jonathan@kbzarch.com

G-001






**KRUGER BENSON ZIEMER ARCHITECTS, INC.**  
 1189 FELICIA ST., SUITE 100A VENTURA, CA 93001  
 TELEPHONE (805) 654-1333

TODD A. JESPERSEN, AIA  
 FENCE/ENCLOSURE  
 JONATHAN D. LEE  
 ARCHITECTURAL ASSISTANT

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ARCHITECTS: STAMP & SIGNATURE  
 ENGINEERS: STAMP & SIGNATURE

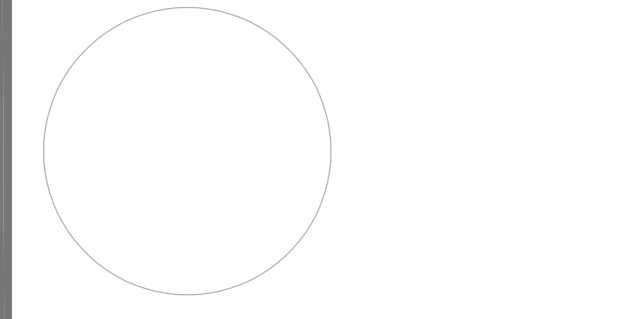


CONSULTANT INFORMATION

REVISION	DESCRIPTION	DATE	BY
1	---/---/XX		
2	---/---/XX		
3	---/---/XX		
4	---/---/XX		
5	---/---/XX		

REVISION DESCRIPTION DATE BY  
 DRAWN: PF  
 CHECKED: TJ  
 DATE: 3/23/2020  
 JOB NO. 19001  
 DSA #A03-120195 FILE: 5644 P/N: 72546-B8  
 SHEET TITLE  
 TITLE

A-100

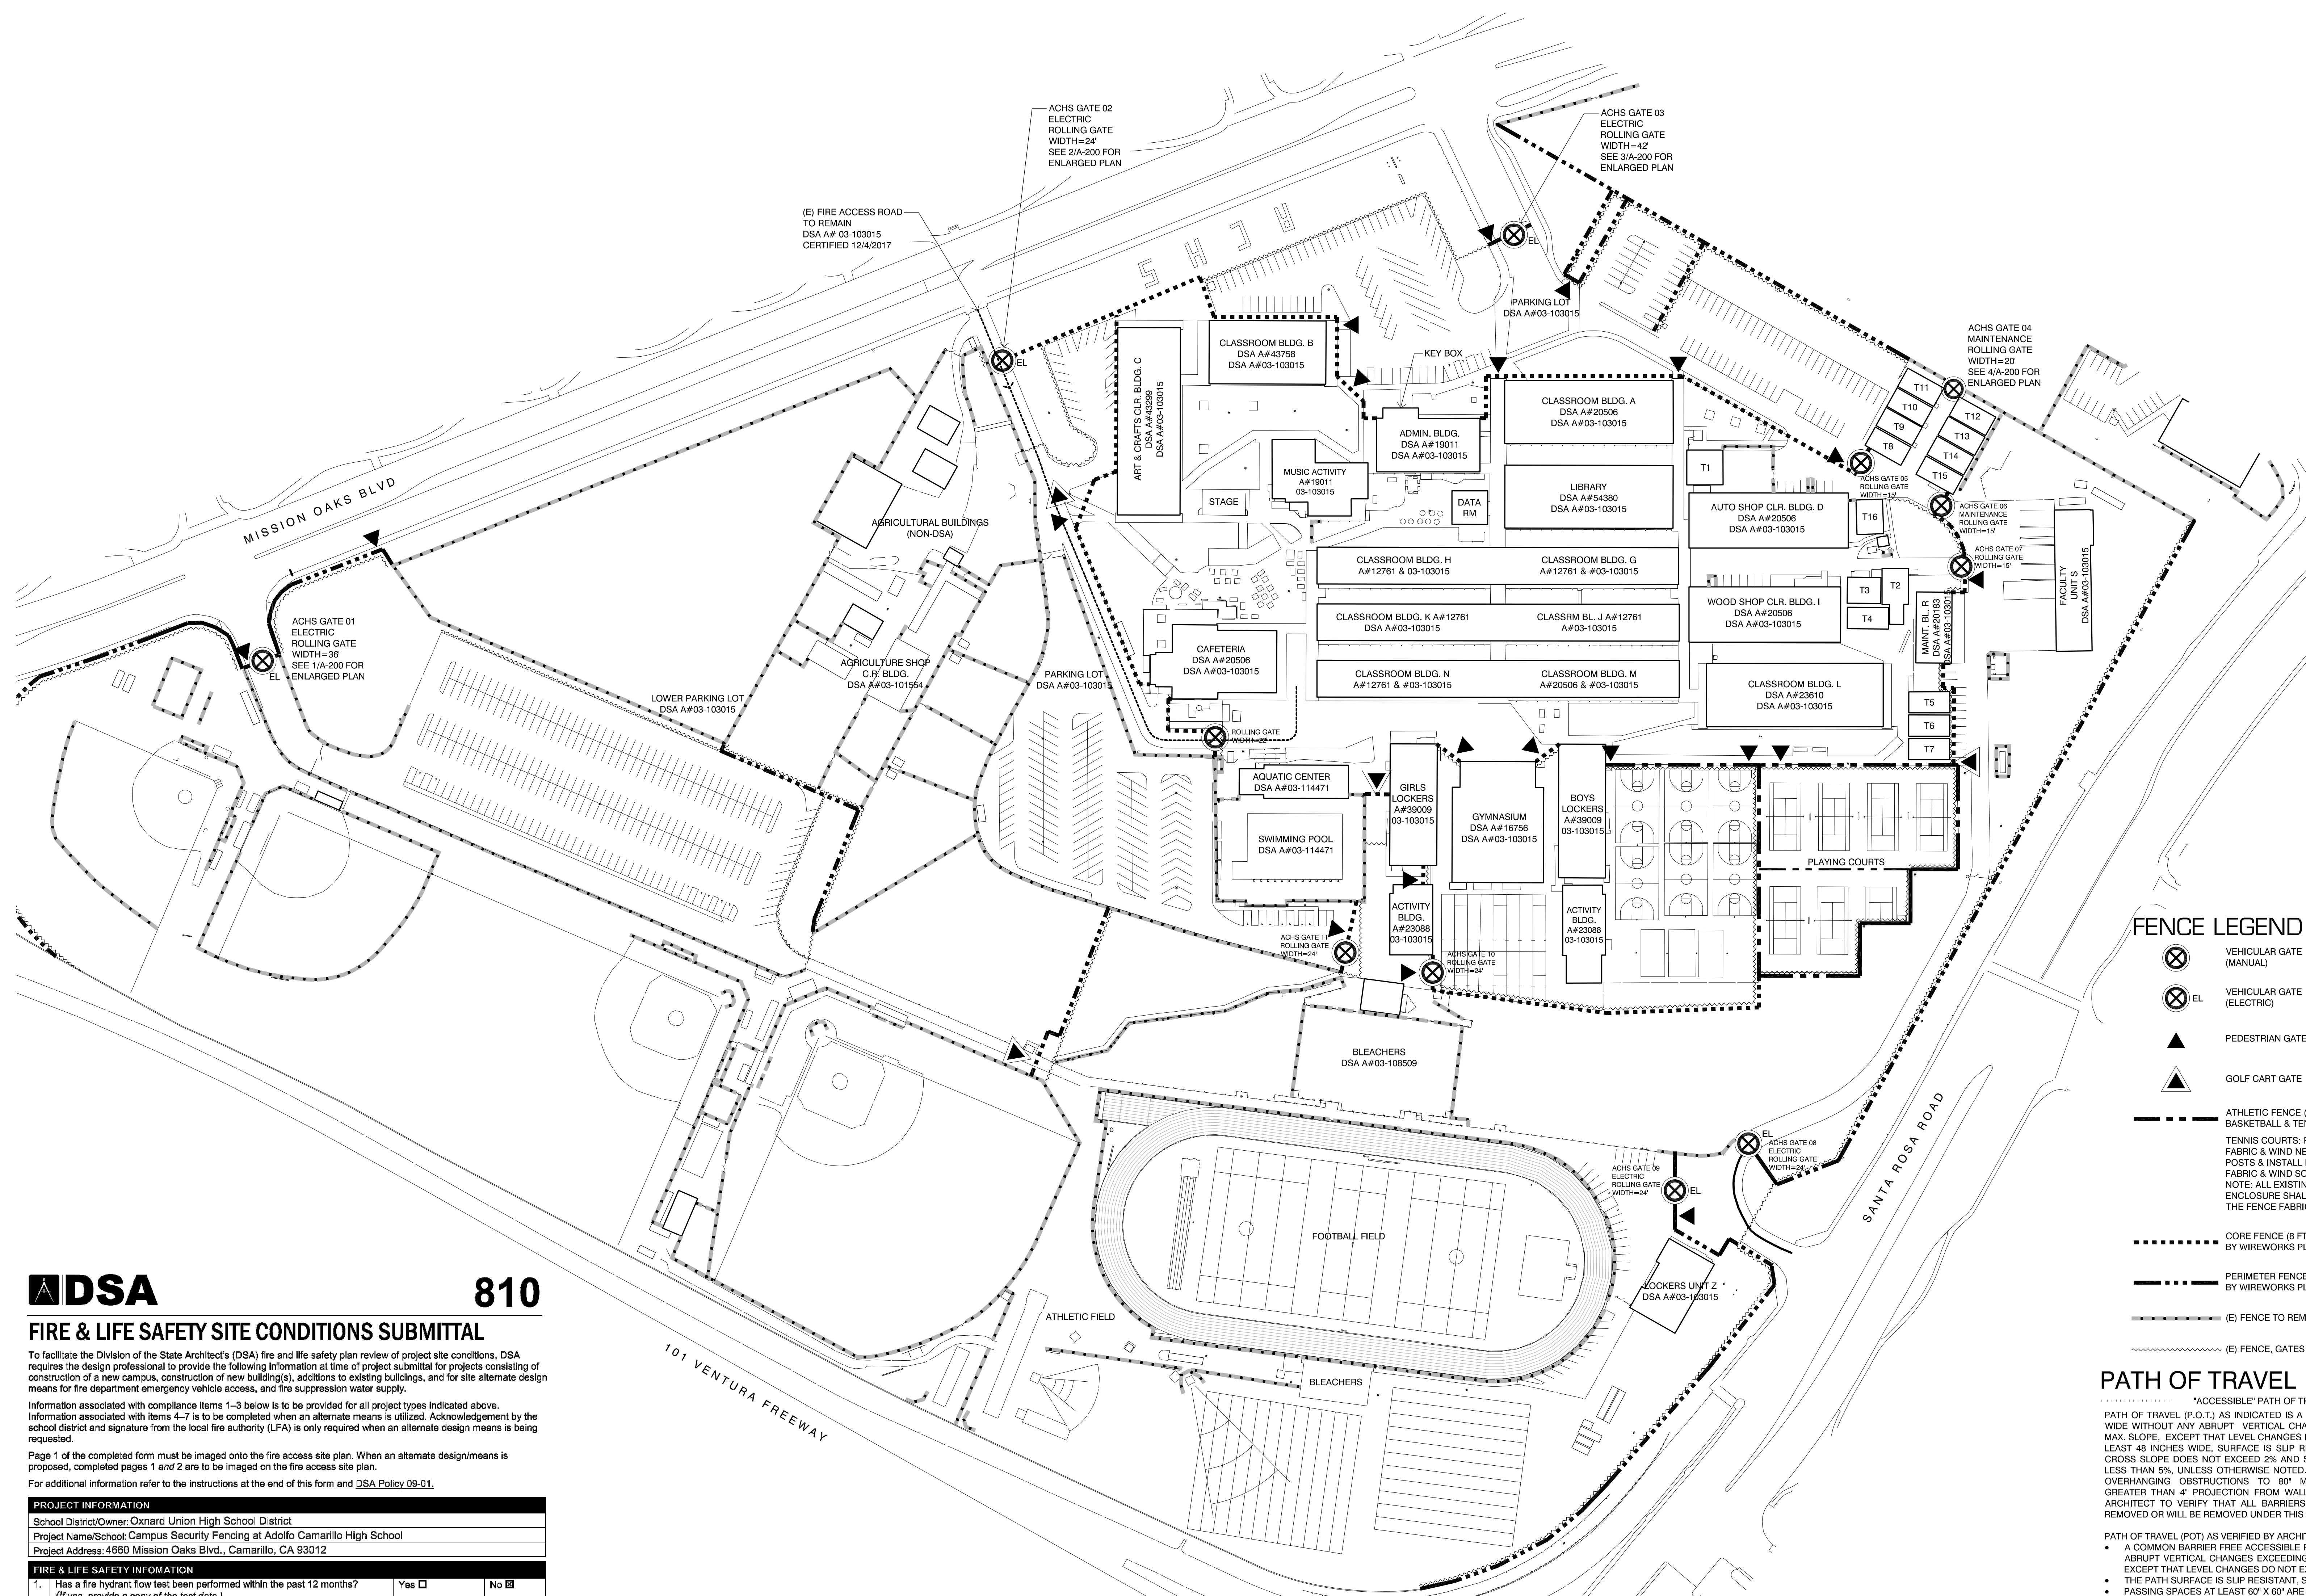

**FENCE LEGEND**

- VEHICULAR GATE (MANUAL) 5 (A-700)
- VEHICULAR GATE (ELECTRIC) 5 (A-700)
- PEDESTRIAN GATE 4 (A-700)
- GOLF CART GATE 3 (A-700) NOTE: 8' WIDE MIN. OPENING
- ATHLETIC FENCE (14 FT. HIGH ATHLETIC FENCE AT BASKETBALL & TENNIS COURTS) 8 (A-700)
- TENNIS COURTS: REMOVE EXISTING FENCE FABRIC & WIND NETTINGS; PAINT EXISTING FENCE FABRIC & WIND SCREEN. NOTE: ALL EXISTING GATES IN THE TENNIS COURT ENCLOSURE SHALL HAVE THE FRAMES PAINTED & THE FENCE FABRIC/WIND SCREEN REPLACED.
- CORE FENCE (8 FT. HIGH VERTICAL WIRE MESH BY WIREWORKS PLUS) 2 (A-700)
- PERIMETER FENCE (8 FT. HIGH BY WIREWORKS PLUS) 2 (A-700)
- (E) FENCE TO REMAIN
- (E) FENCE, GATES & FOOTINGS TO BE REMOVED

**PATH OF TRAVEL**

ACCESSIBLE PATH OF TRAVEL (P.O.T.)

PATH OF TRAVEL (P.O.T.) AS INDICATED IS A BARRIER FREE ACCESS IS AT LEAST 48" WIDE WITHOUT ANY ABRUPT VERTICAL CHANGES EXCEEDING 1/2" BEVELED AT 1:2 MAX. SLOPE. EXCEPT THAT LEVEL CHANGES DO NOT EXCEED 1/4" VERTICAL AND IS AT LEAST 48 INCHES WIDE. SURFACE IS SLIP RESISTANT, STABLE, FIRM AND SMOOTH. CROSS SLOPE DOES NOT EXCEED 2% AND SLOPE IN THE DIRECTION OF TRAVEL IS LESS THAN 5% UNLESS OTHERWISE NOTED. P.O.T. SHALL BE MAINTAINED FREE OF OVERHANGING OBSTRUCTIONS TO 80" MINIMUM AND PROTRUDING OBJECTS GREATER THAN 4" PROJECTION FROM WALL AND ABOVE 27" AND LESS THAN 80". ARCHITECT TO VERIFY THAT ALL BARRIERS IN THE PATH OF TRAVEL HAVE BEEN REMOVED OR WILL BE REMOVED UNDER THIS PROJECT.

PATH OF TRAVEL (POT) AS VERIFIED BY ARCHITECT IS:

- A COMMON BARRIER FREE ACCESSIBLE ROUTE AT LEAST 48" WIDE WITHOUT ANY ABRUPT VERTICAL CHANGES EXCEEDING 1/2" BEVELED AT 1:2 MAXIMUM SLOPE. EXCEPT THAT LEVEL CHANGES DO NOT EXCEED 1/4" VERTICAL.
- THE PATH SURFACE IS SLIP RESISTANT, STABLE, FIRM AND SMOOTH.
- PASSING SPACES AT LEAST 60" X 60" ARE LOCATED NOT MORE THAN 200' APART.
- CONTINUOUS GRADIENTS HAVE 60" LEVEL AREAS NOT MORE THAN 400' APART.
- CROSS-SLOPE DOES NOT EXCEED 2%.
- SLOPE IN THE DIRECTION OF TRAVEL IS LESS THAN 5% UNLESS OTHERWISE INDICATED AS A RAMP.
- MAINTAIN POT FREE OF OVERHANGING OBSTRUCTIONS TO 80" MINIMUM. PROTRUDING OBJECTS GREATER THAN 4" PROJECTION FROM WALL OR EDGE AND 27" ABOVE FINISH GRADE.

FOR GRATINGS LOCATED IN THE SURFACE OF ANY PEDESTRIAN WAYS AT PATH OF TRAVEL, GRID/OPENINGS IN GRATINGS SHALL BE LIMITED TO 1/2" MAX. IN THE DIRECTION OF TRAFFIC FLOW. IF SUCH CONDITION OCCURS, PROVIDE MANUFACTURER CUTSHEETS OF GRATE PROVIDED.

GATES SERVING THE MEANS OF EGRESS SYSTEM SHALL COMPLY WITH THE REQUIREMENTS OF SECTION 1008. GATES USED AS A COMPONENT IN A MEANS OF EGRESS SHALL CONFORM TO THE APPLICABLE REQUIREMENTS FOR DOORS. PROVIDE LEVER HARDWARE AND KICKPLATE. FIRE AND LIFE SAFETY MAY REQUIRE PANIC HARDWARE FOR EMERGENCY EXITING EVEN WITH THE SIGN. COORDINATE WITH FIRE AND LIFE SAFETY REQUIREMENTS.

DESIGN PROFESSIONAL IN GENERAL RESPONSIBLE CHARGE STATEMENT

THE POT IDENTIFIED IN THESE CONSTRUCTION DOCUMENTS IS COMPLIANT WITH THE CURRENT APPLICABLE CALIFORNIA BUILDING CODE ACCESSIBILITY PROVISIONS FOR PATH OF TRAVEL REQUIREMENTS FOR ALTERATIONS, ADDITIONS AND STRUCTURAL REPAIRS. AS PART OF THE DESIGN OF THIS PROJECT, THE POT WAS DETERMINED AND ANY ELEMENTS, COMPONENTS OR PORTIONS OF THE POT THAT WERE IDENTIFIED TO BE NON COMPLIANT

1. HAVE BEEN IDENTIFIED

2. THE CORRECTIVE WORK NECESSARY TO BRING THEM INTO COMPLIANCE HAS BEEN INCLUDED WITHIN THE SCOPE OF THIS PROJECT'S WORK THROUGH DETAILS, DRAWINGS AND SPECIFICATIONS INCORPORATED INTO THESE CONSTRUCTION DOCUMENTS.

DURING CONSTRUCTION, IF POT ITEMS WITHIN THE SCOPE OF THE PROJECT REPRESENTED AS CODE COMPLIANT ARE FOUND TO BE NON CONFORMING BEYOND REASONABLE CONSTRUCTION TOLERANCES, THEY SHALL BE BROUGHT INTO COMPLIANCE WITH THE CBC AS PART OF THIS PROJECT BY MEANS OF A CONSTRUCTION CHANGE DOCUMENT.

- NOTES:**
- REPLACE IRRIGATION AS REQUIRED FOR INSTALLATION OF NEW FENCING.
  - REFER TO PLAN FOR GATES THAT REQUIRE ELECTRIC OPENERS.
  - POSTS: SQUARE TUBES 2-1/2" x 2-1/2" FORMED FROM NOMINAL THICKNESS, METALLIC-COATED STEEL SHEET OR FOR MED FROM .0625-INCH NOMINAL - THICKNESS STEEL SHEET AND HOT DIP GALVANIZED AFTER FABRICATION.
  - POSTS AT NON-ACCESSIBLE SWING GATE OPENINGS: SQUARE TUBES 3" x 3" FORMED FROM 0.108 INCH NOMINAL THICKNESS, METALLIC-COATED STEEL SHEET OR FORMED FROM 0.105 INCH NOMINAL THICKNESS STEEL SHEET AND HOT DIP GALVANIZED AFTER FABRICATION.
  - POSTS AT ACCESSIBLE EGRESS GATE OPENINGS: SQUARE TUBES 4" x 4" FOR SINGLE EGRESS OPENINGS AND 6" x 6" FOR DOUBLE EGRESS OPENINGS.

**DSA 810**  
**FIRE & LIFE SAFETY SITE CONDITIONS SUBMITTAL**

To facilitate the Division of the State Architect's (DSA) fire and life safety plan review of project site conditions, DSA requires the design professional to provide the following information at time of project submittal for projects consisting of construction of a new campus, construction of new building(s), additions to existing buildings, and for site alternate design means for fire department emergency vehicle access, and fire suppression water supply.

Information associated with compliance items 1-3 below is to be provided for all project types indicated above. Information associated with items 4-7 is to be completed when an alternate means is utilized. Acknowledgement by the school district and signature from the local fire authority (LFA) is only required when an alternate design means is being requested.

Page 1 of the completed form must be imaged onto the fire access site plan. When an alternate design means is proposed, completed pages 1 and 2 are to be imaged on the fire access site plan.

For additional information refer to the instructions at the end of this form and **DSA Policy 09-01**.

PROJECT INFORMATION			
School District/Owner: Oxnard Union High School District			
Project Name/School: Campus Security Fencing at Adolfo Camarillo High School			
Project Address: 4660 Mission Oaks Blvd., Camarillo, CA 93012			
FIRE & LIFE SAFETY INFORMATION			
1. Has a fire hydrant flow test been performed within the past 12 months? (If yes, provide a copy of the test data.)	Yes <input type="checkbox"/>	No <input checked="" type="checkbox"/>	
2. Was the fire hydrant water flow test performed as part of this LFA review?	Yes <input type="checkbox"/>	No <input checked="" type="checkbox"/>	
3. Is the project located within a designated fire hazard severity zone as established by Cal-Fire? (If yes, indicate the hazard zone classification below)	Yes <input type="checkbox"/>	No <input checked="" type="checkbox"/>	
Refer to the following for fire hazard zone locations: <a href="http://www.fire.ca.gov/fire_prevention/fire_prevention_wildland_zones_maps">www.fire.ca.gov/fire_prevention/fire_prevention_wildland_zones_maps</a>			
Wildland Interface Area (WIFA) (If any designations are checked, project design must meet the requirements of CBC Chapter 7A.)	Moderate <input type="checkbox"/>	High <input type="checkbox"/>	Very High <input type="checkbox"/>
	WIFA <input type="checkbox"/>		
CONDITION MEANS AND METHODS RESOLUTION			
	ALTERNATE ACCEPTED		
	Yes	No	N/A / N/R
4. Emergency vehicle access roadways do not meet CFC requirements.			<input checked="" type="checkbox"/>
4a. <b>Acceptable Alternate:</b> Emergency vehicle and personnel access as proposed by the project architect is acceptable for providing fire suppression and protection of life and property.			<input checked="" type="checkbox"/>
5. <b>Fire Hydrants:</b> Number and spacing does not meet CFC requirements.			<input checked="" type="checkbox"/>
5a. <b>Acceptable Alternate:</b> Number of fire hydrants and spacing as proposed by the project architect is acceptable for fire suppression and protection of life and property.			<input checked="" type="checkbox"/>
6. <b>Fire Hydrants:</b> Water flow and pressure are less than CFC minimum.			<input checked="" type="checkbox"/>
6a. <b>Acceptable Alternate:</b> The available flow and pressure is acceptable for providing fire suppression and protection of life and property.			<input checked="" type="checkbox"/>
7. Location of fire department connection(s) serving fire sprinkler systems or standpipe systems does not meet CFC requirements.			<input checked="" type="checkbox"/>
7a. <b>Acceptable Alternate:</b> The location of fire department connection serving the fire sprinkler system and/or standpipe system is acceptable for providing fire suppression and protection of life and property.			<input checked="" type="checkbox"/>

DSA 810  
**FIRE & LIFE SAFETY SITE CONDITIONS SUBMITTAL**

**School District Acceptance of Acceptable Design Alternates**

By signing this form, the school district acknowledges and accepts the proposed design as an alternative to California Building Code (CBC) and California Fire Code (CFC) minimum requirements, as indicated by one or more of the conditions indicated at items 4a, 5a, 6a or 7a, for providing fire and life safety protection of life and property.


Accepted by: \_\_\_\_\_ Title: \_\_\_\_\_  
 Signature: \_\_\_\_\_ Date: \_\_\_\_\_

**LOCAL FIRE AUTHORITY (LFA) INFORMATION**


LFA Agency Name: VENTURA COUNTY FIRE DEPARTMENT  
 LFA Review Official: John Dobb  
 Title: FIRE INSPECTOR  
 Work E-mail: John.Dobb@Ventura.org

**1 SITE PLAN (ADOLFO CAMARILLO HIGH SCHOOL)**  
 SCALE: 1" = 80'-0"




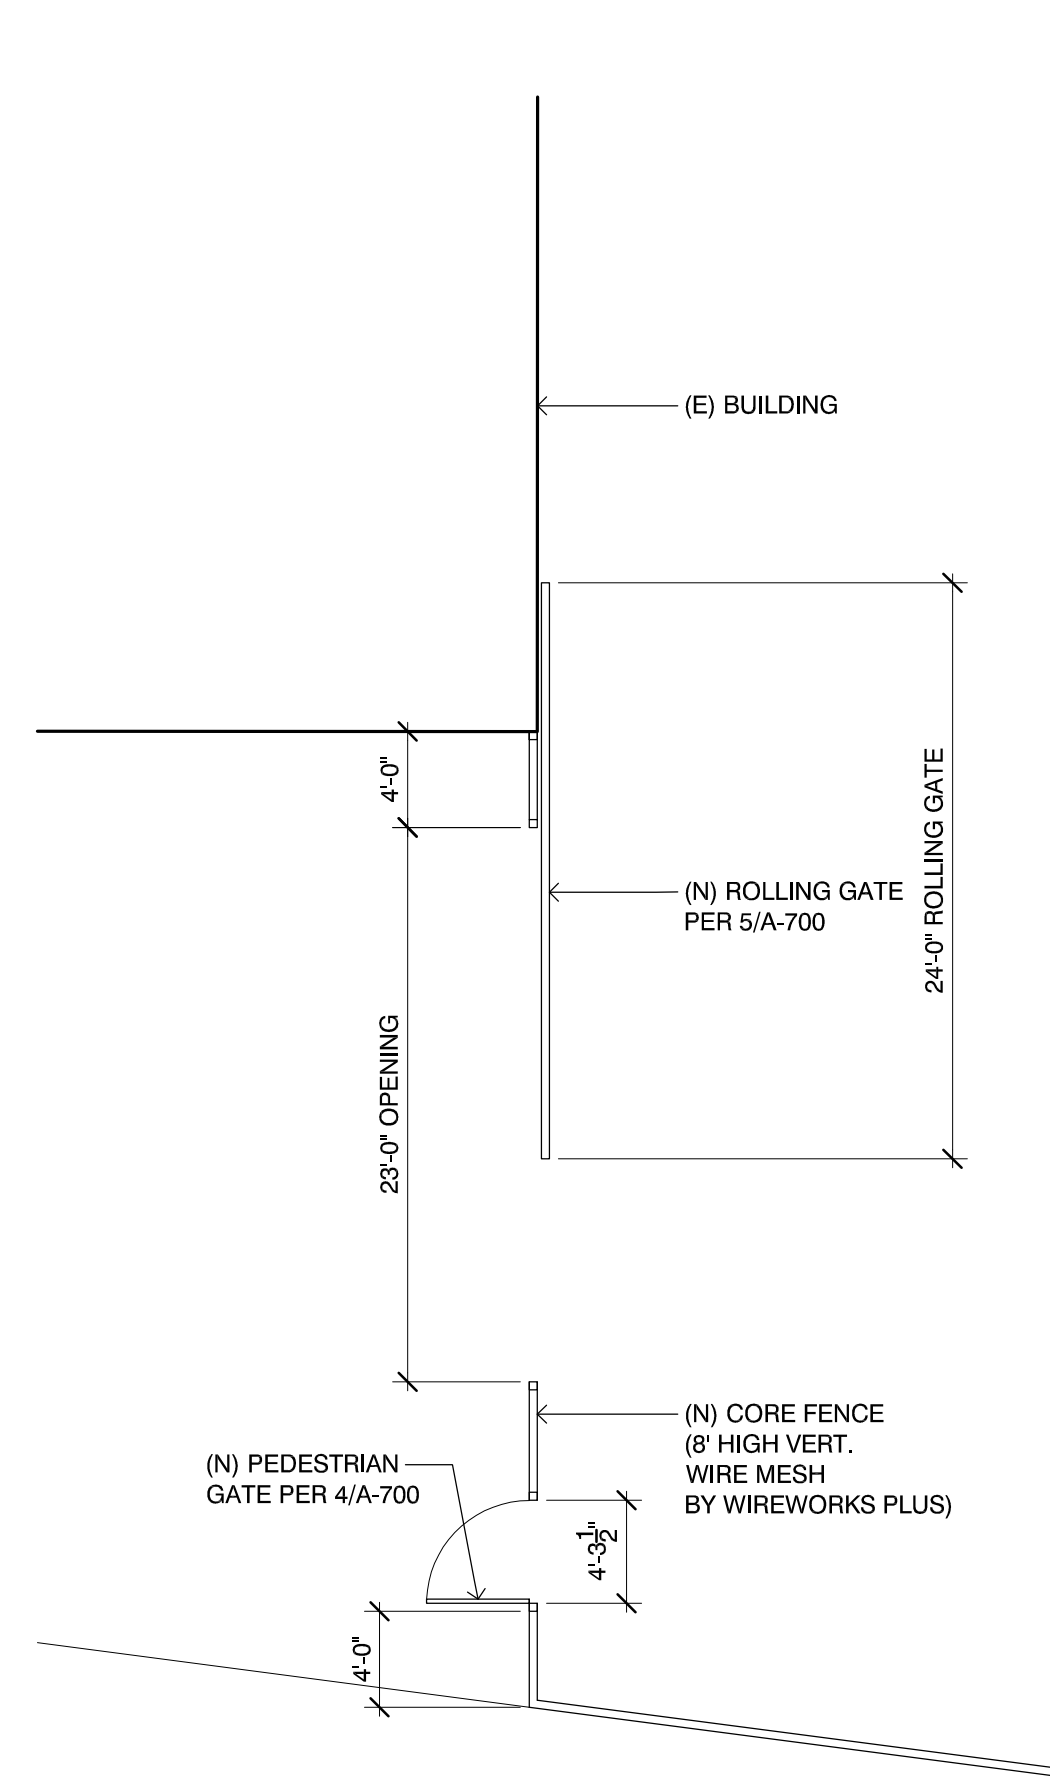


10 ACHS Gate 10 Enlarged Plan  
SCALE: 1/8" = 1'-0"

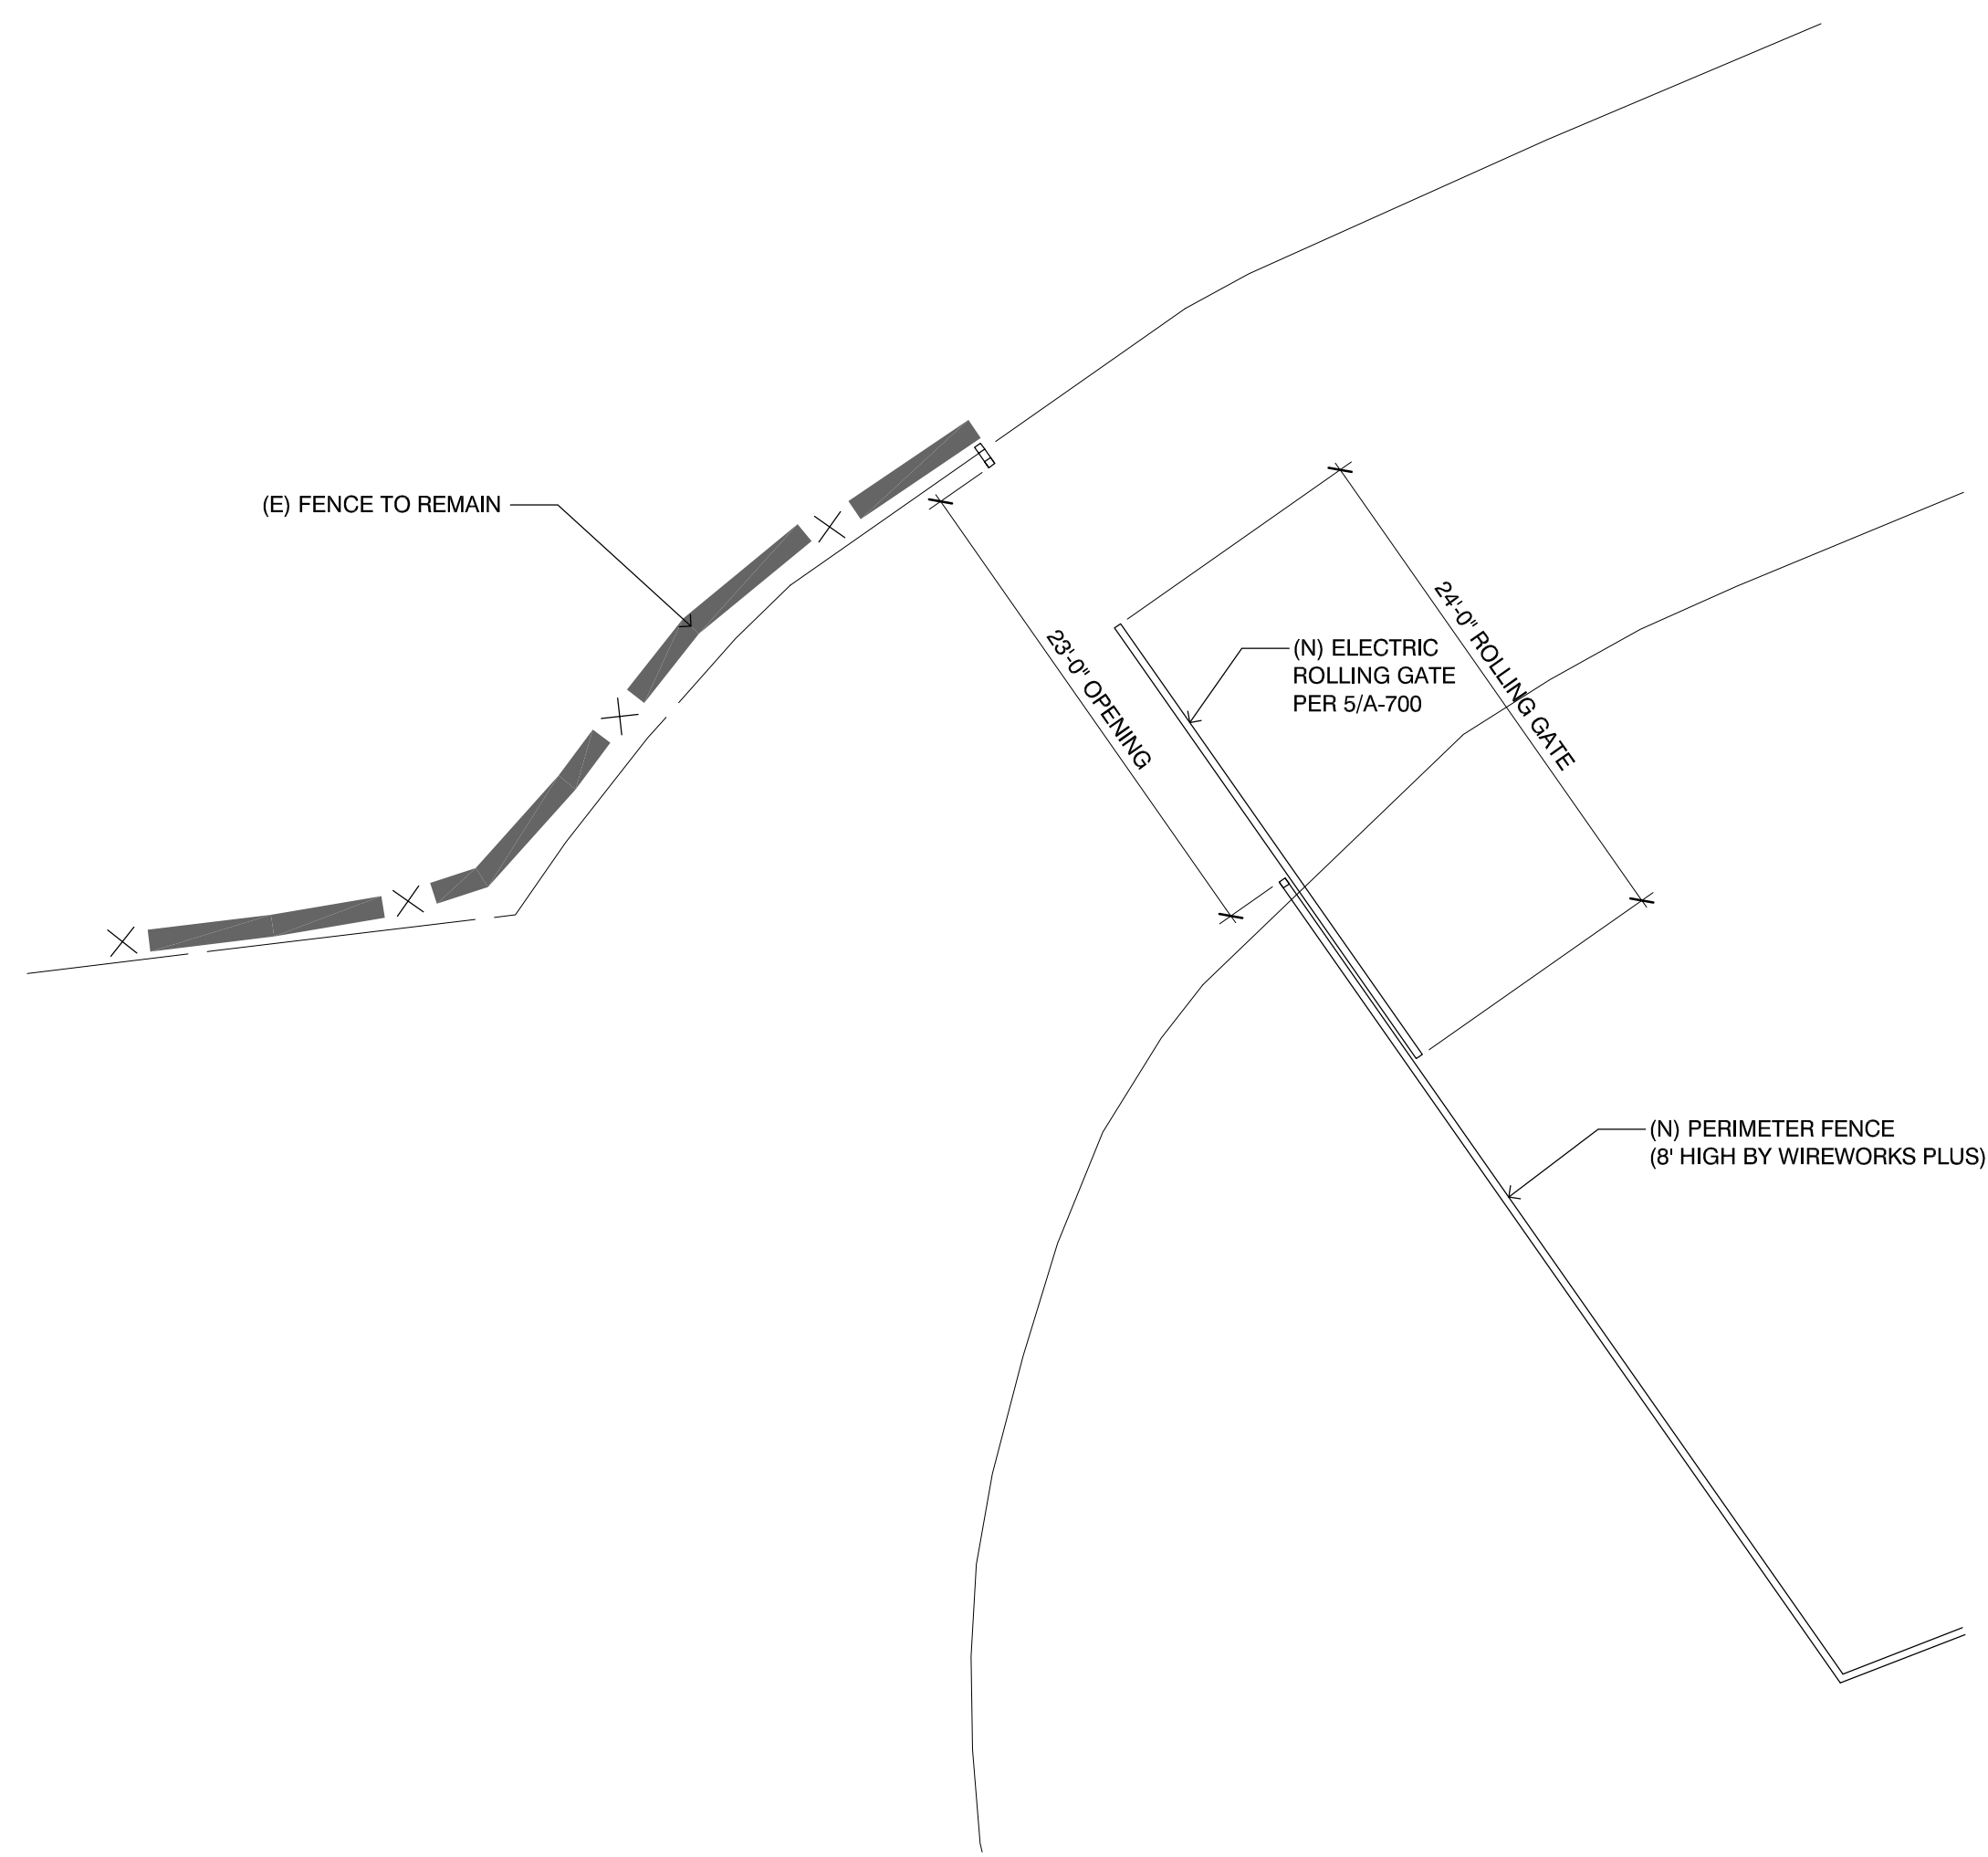


8 ACHS Gate 08 Enlarged Plan  
SCALE: 1/8" = 1'-0"

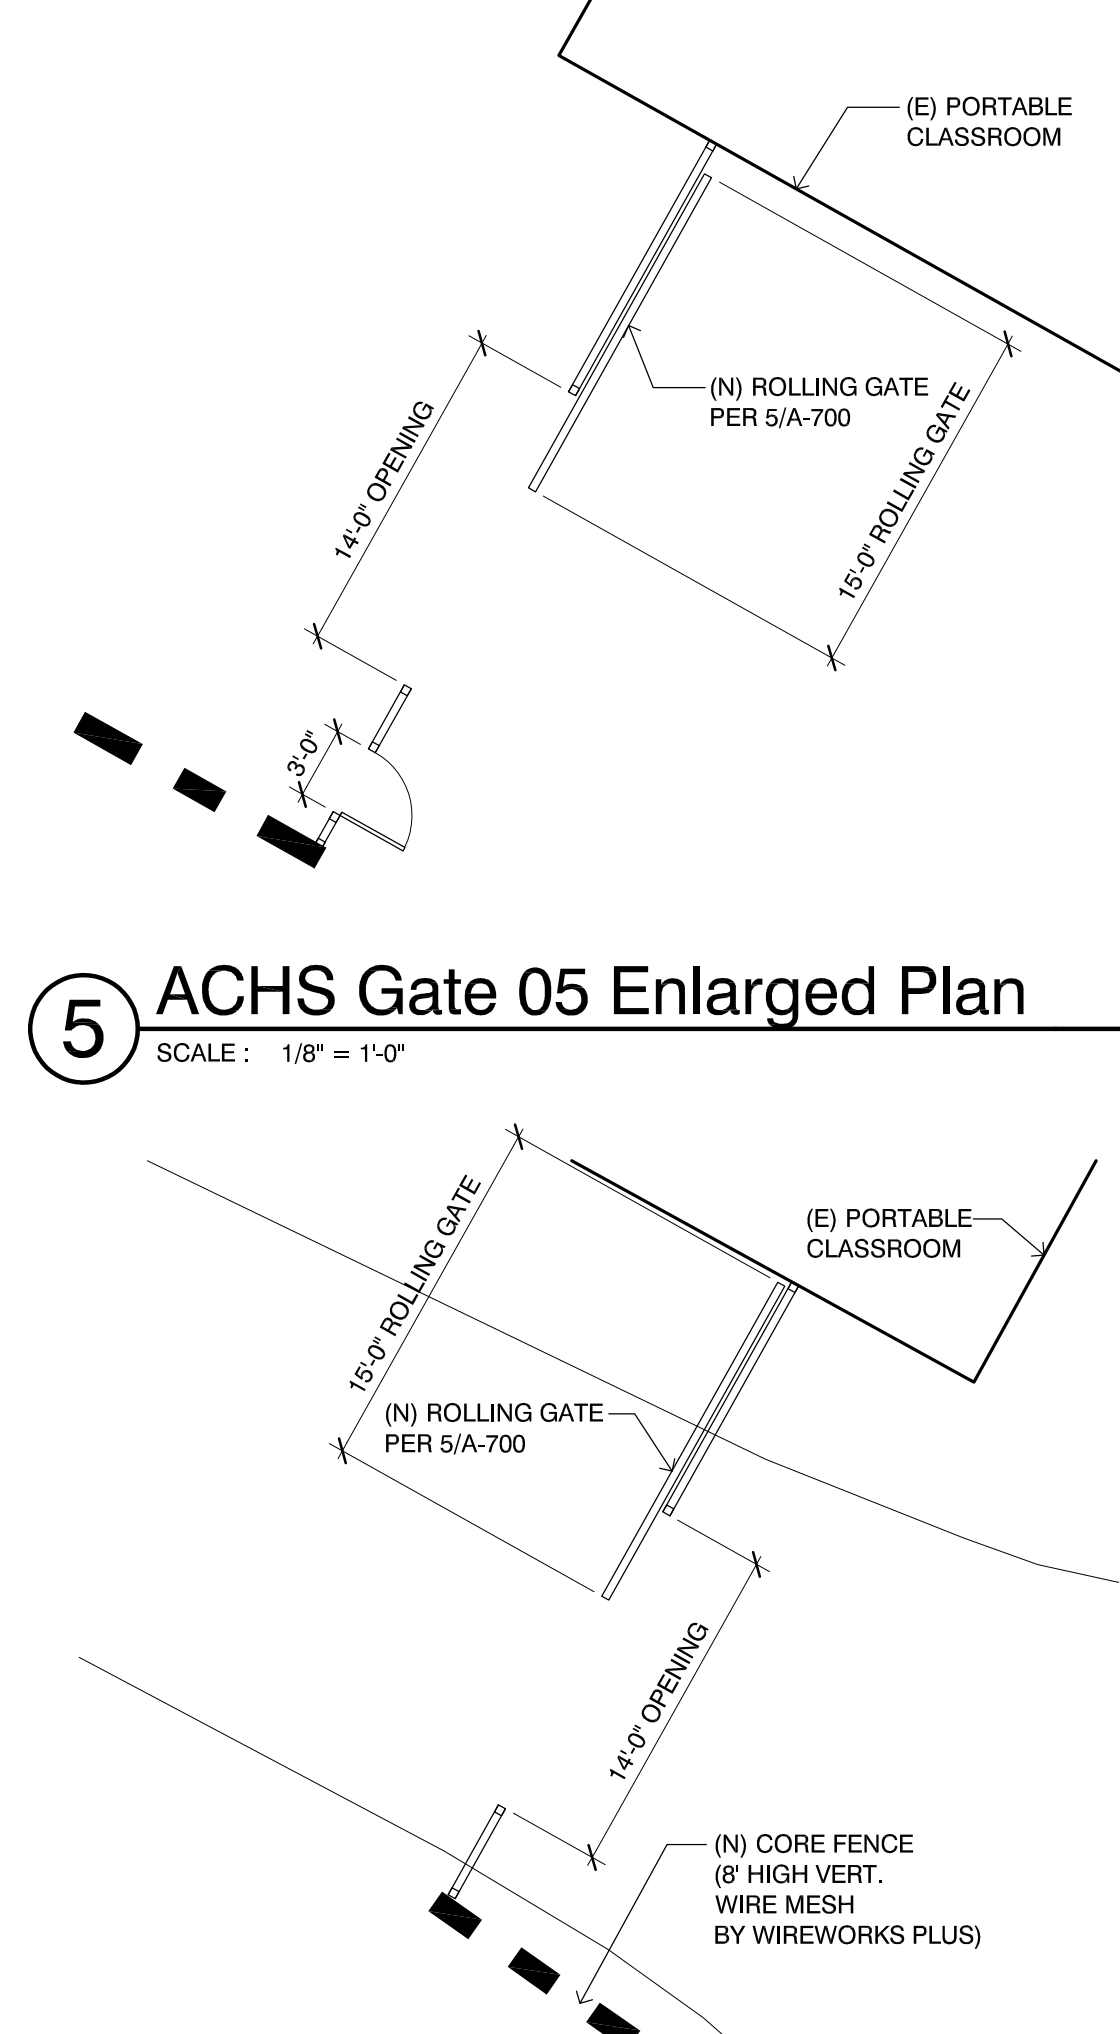


5 ACHS Gate 05 Enlarged Plan  
SCALE: 1/8" = 1'-0"

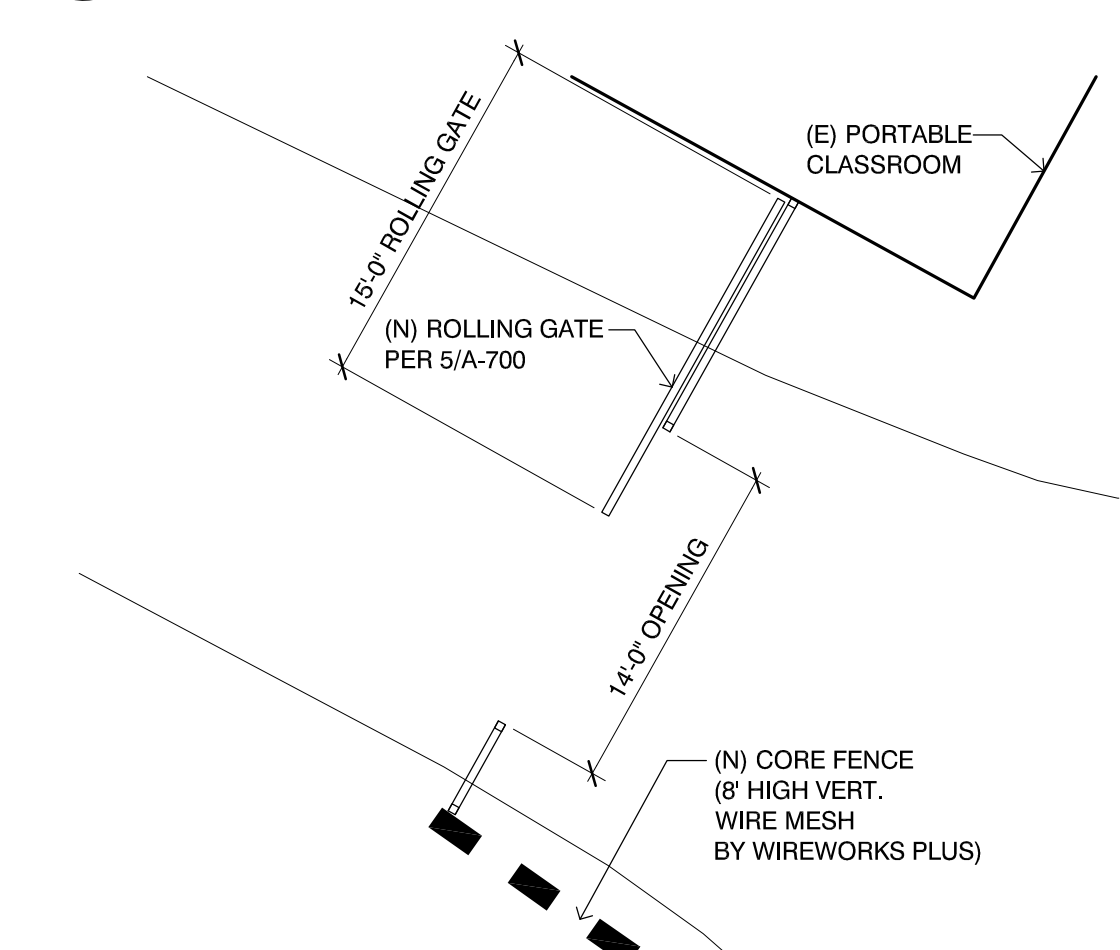


6 ACHS Gate 06 Enlarged Plan  
SCALE: 1/8" = 1'-0"

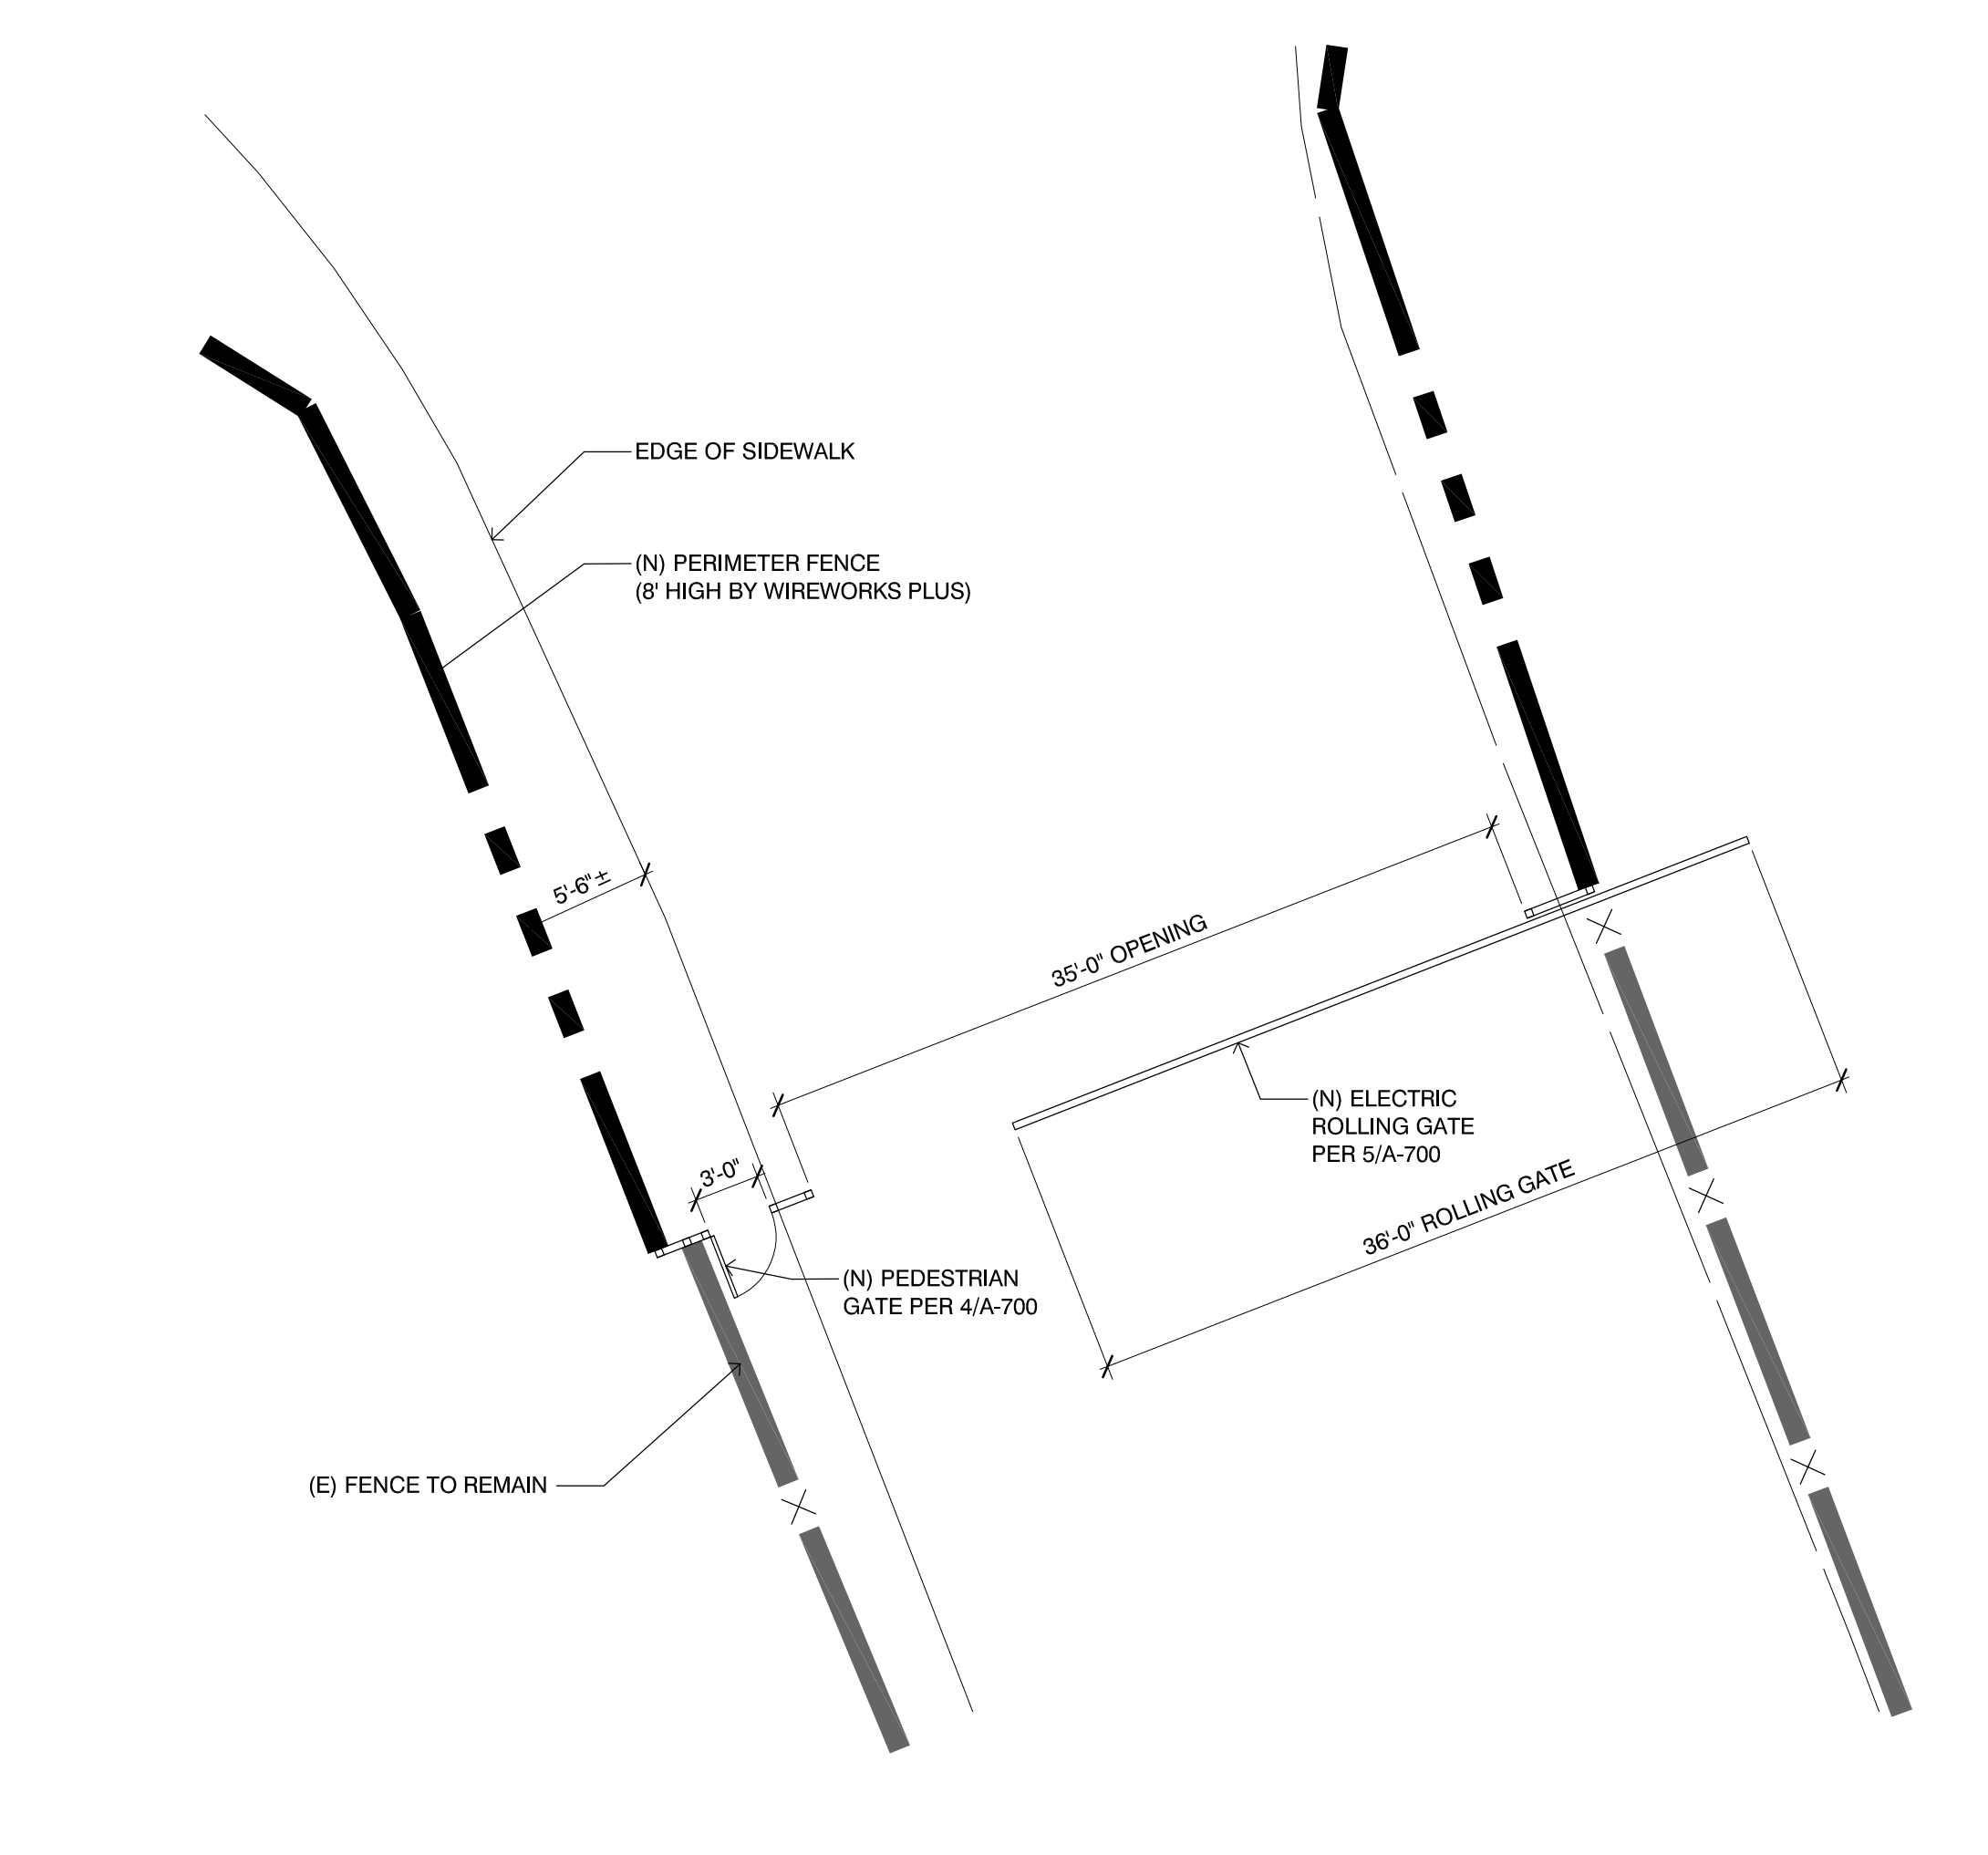


1 ACHS Gate 01 Enlarged Plan  
SCALE: 1/8" = 1'-0"

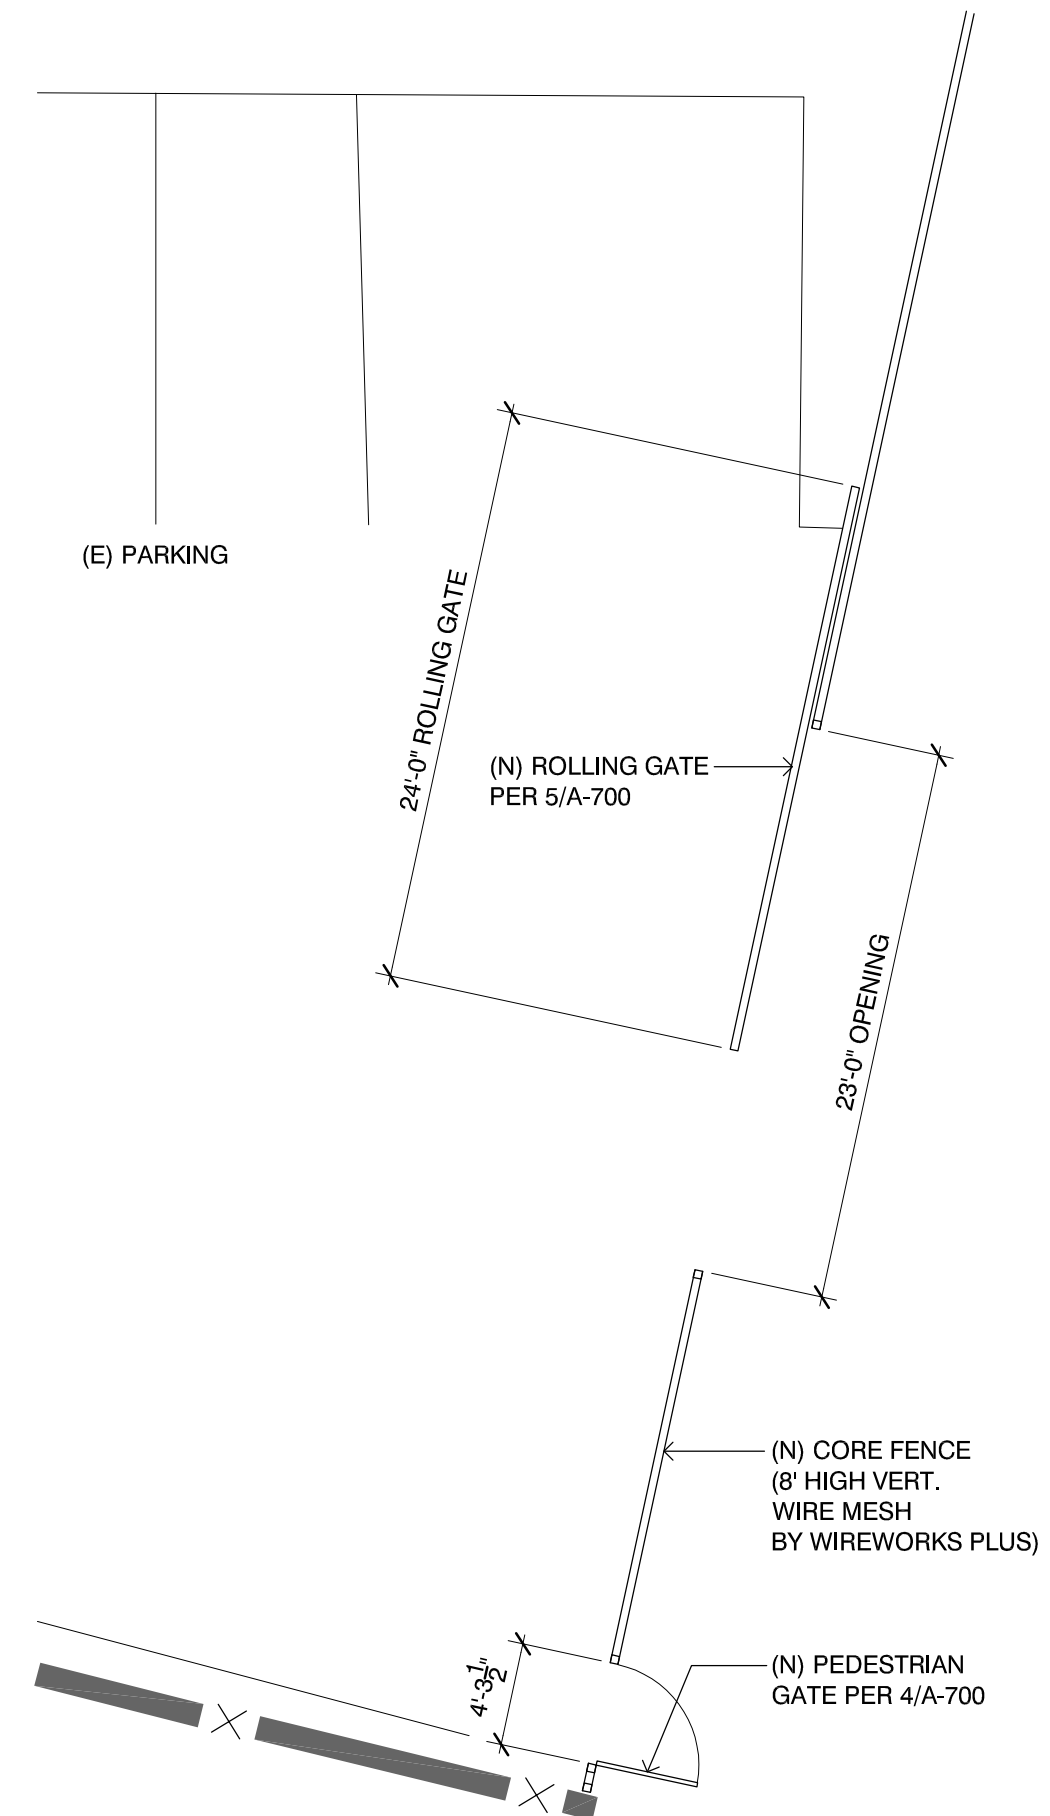


11 ACHS Gate 11 Enlarged Plan  
SCALE: 1/8" = 1'-0"

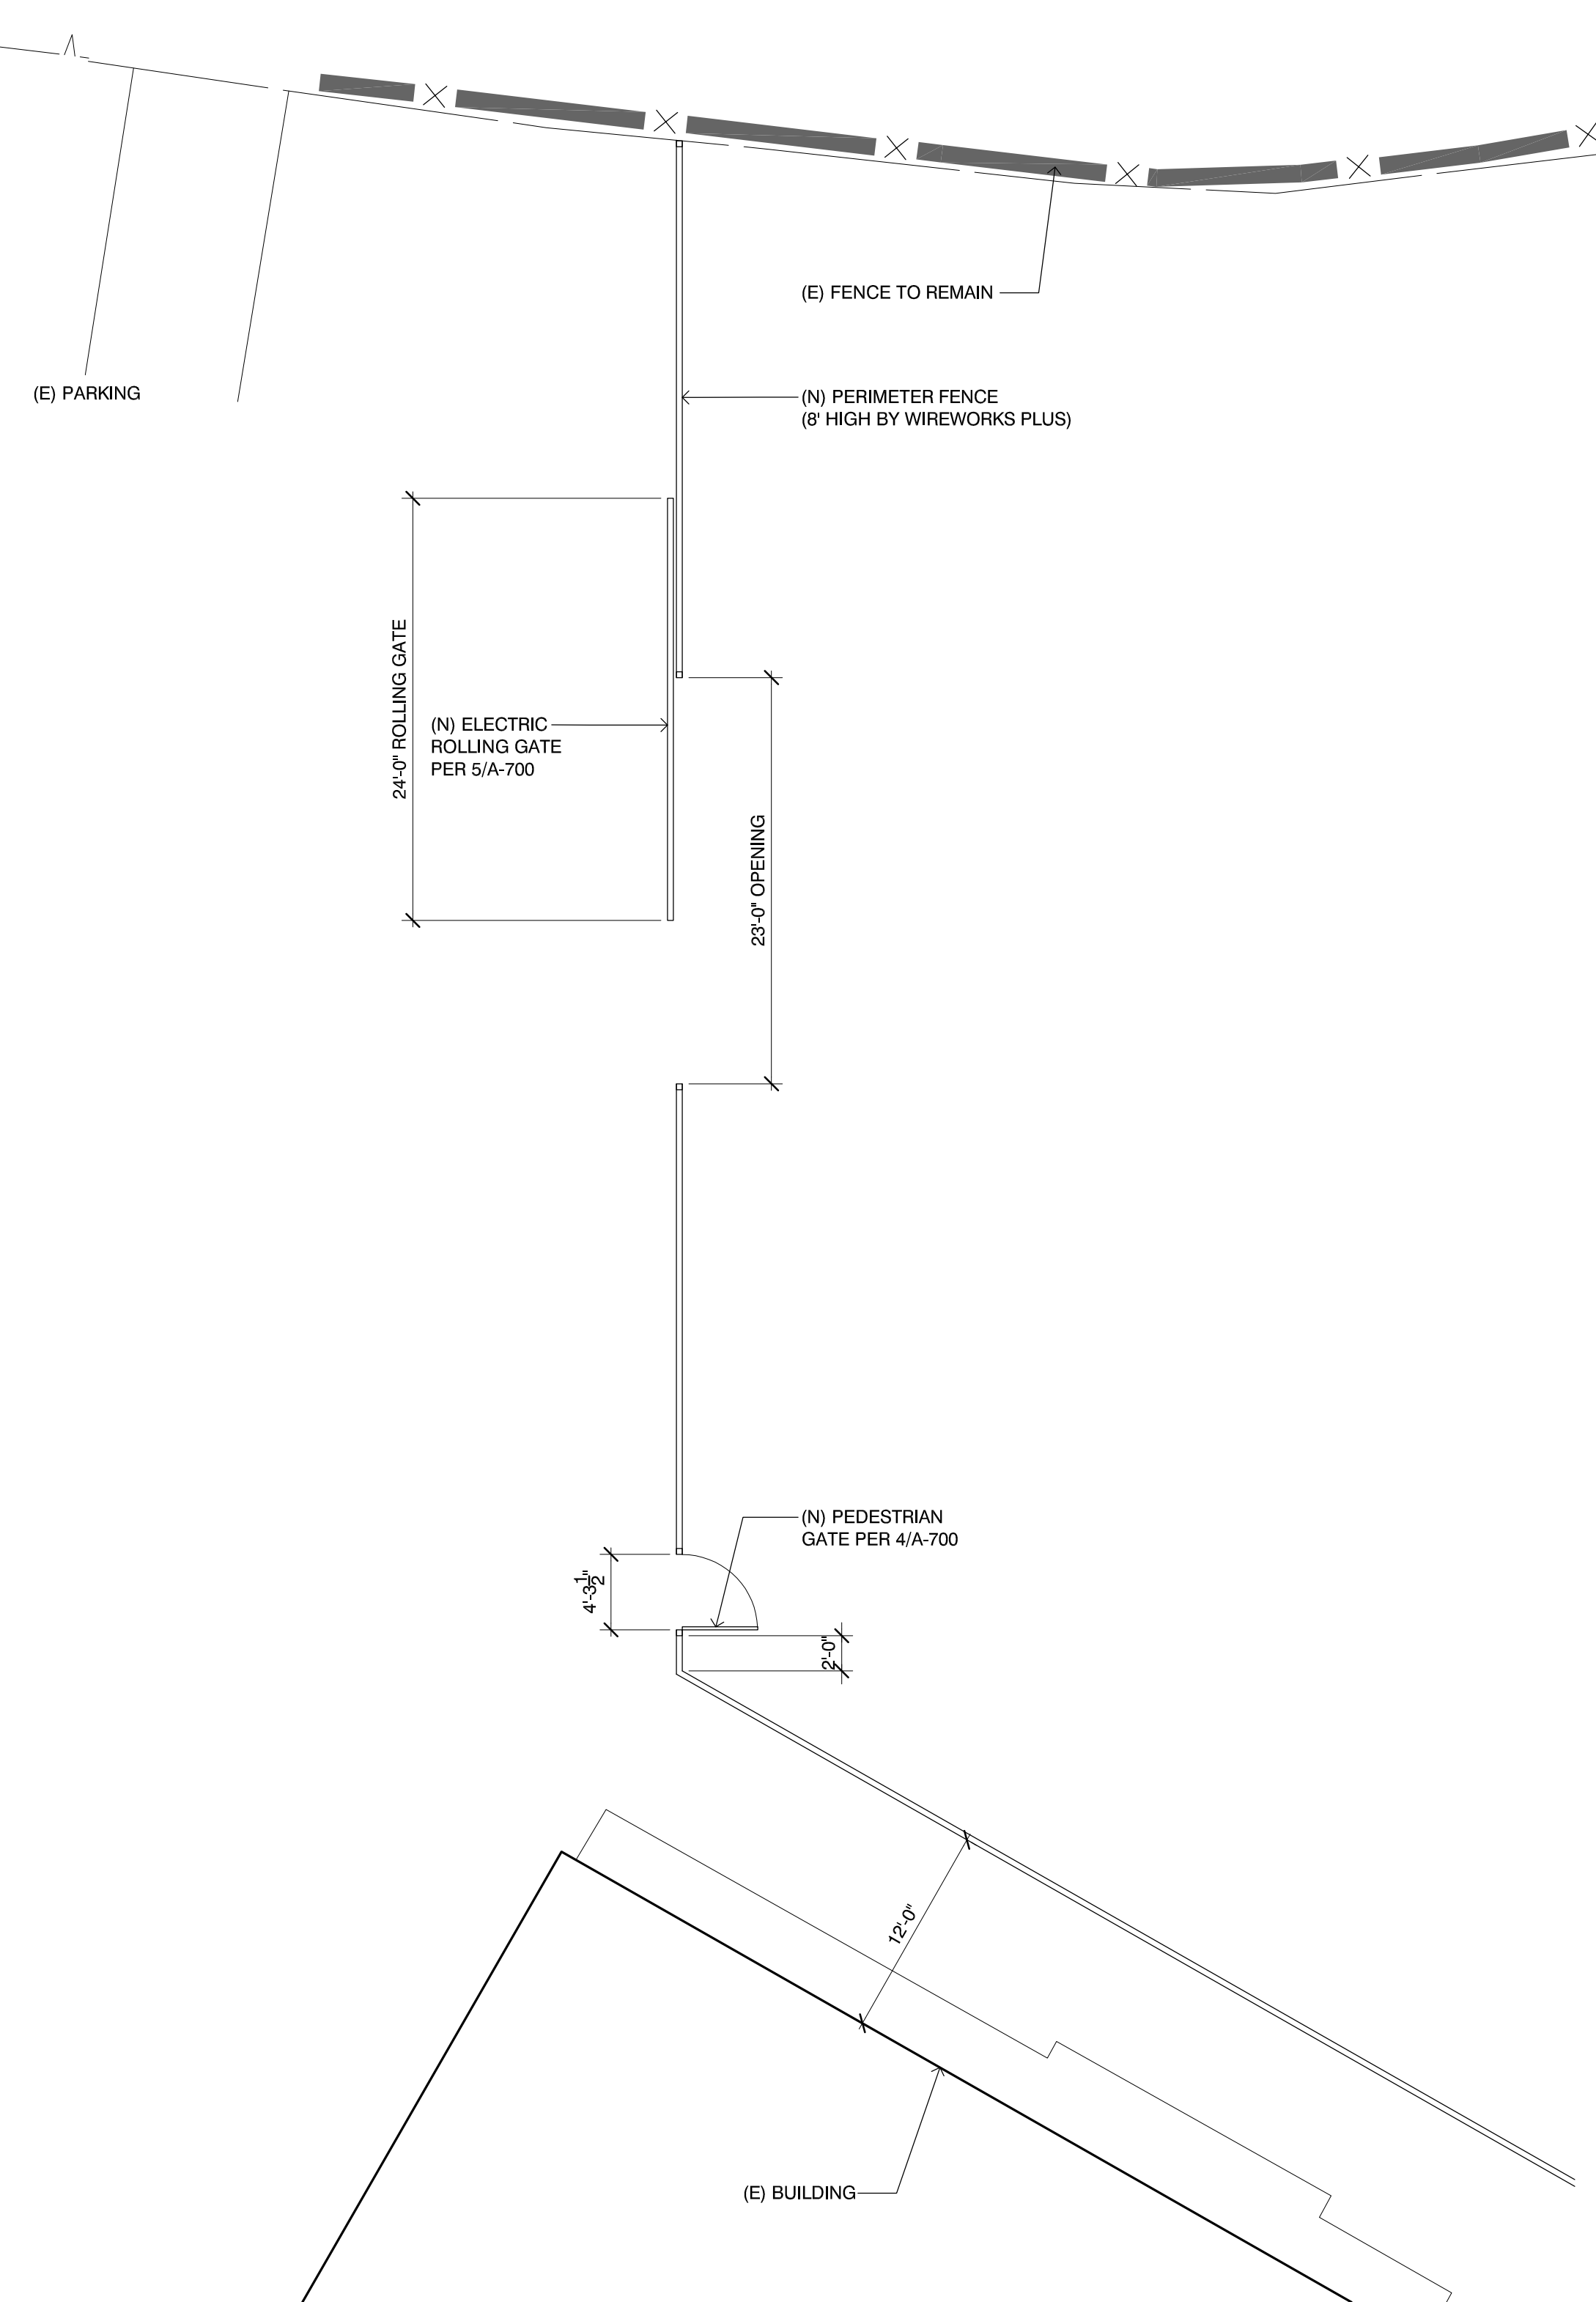


9 ACHS Gate 09 Enlarged Plan  
SCALE: 1/8" = 1'-0"

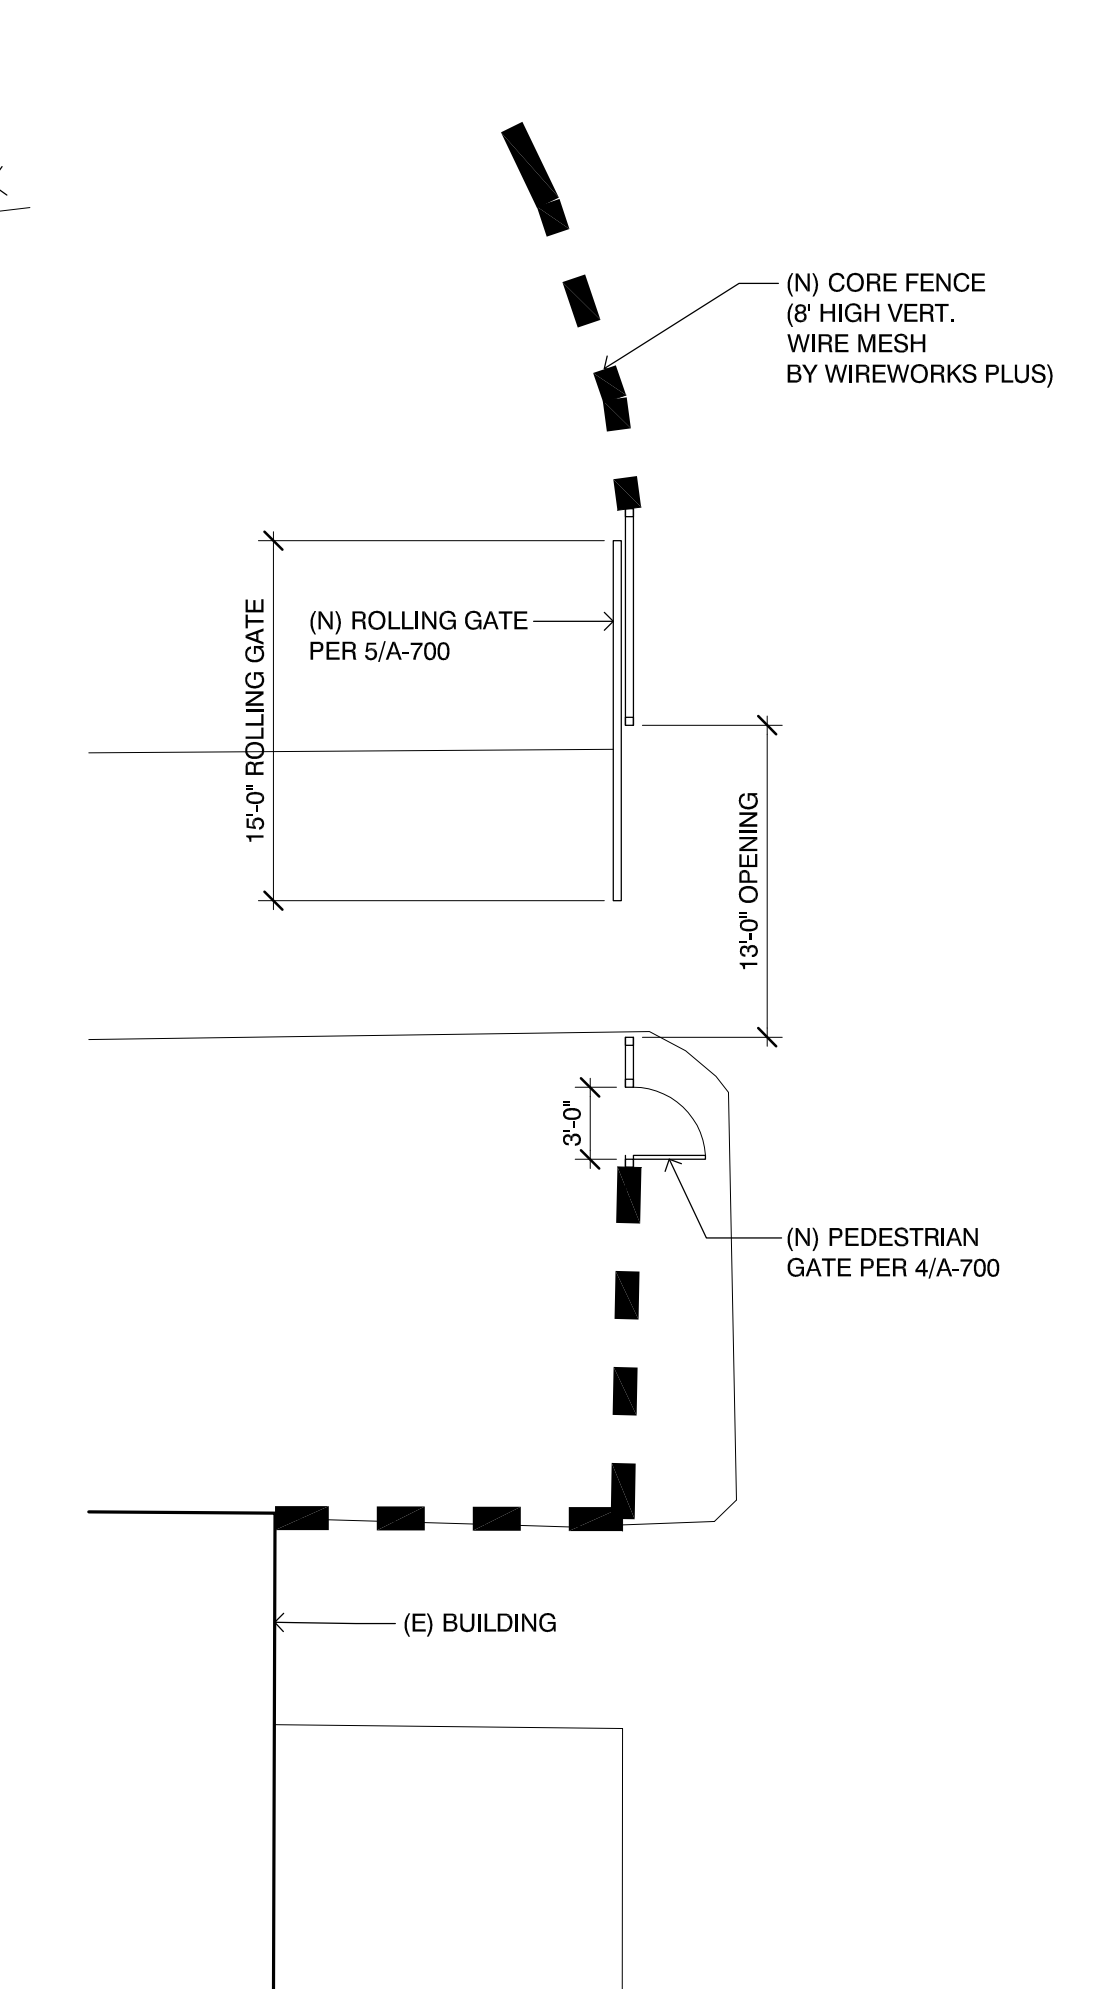


7 ACHS Gate 07 Enlarged Plan  
SCALE: 1/8" = 1'-0"

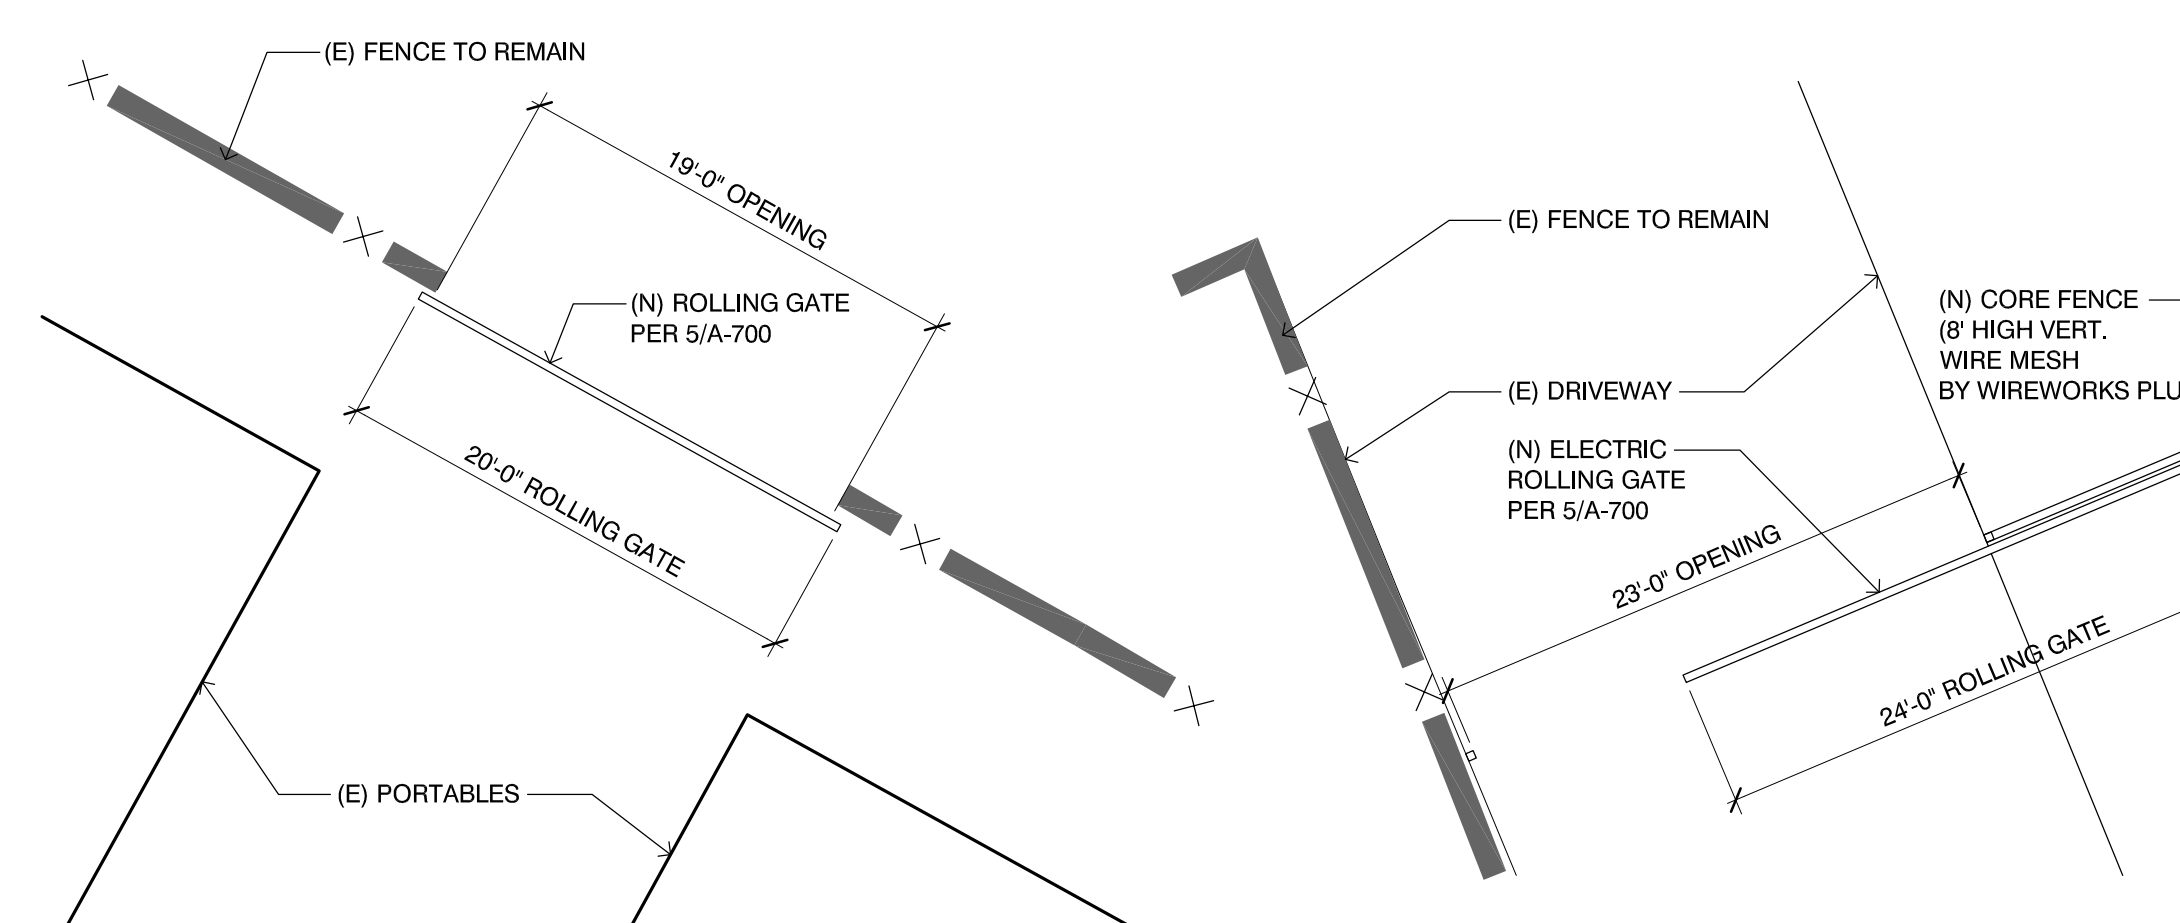

4 ACHS Gate 04 Enlarged Plan  
SCALE: 1/8" = 1'-0"

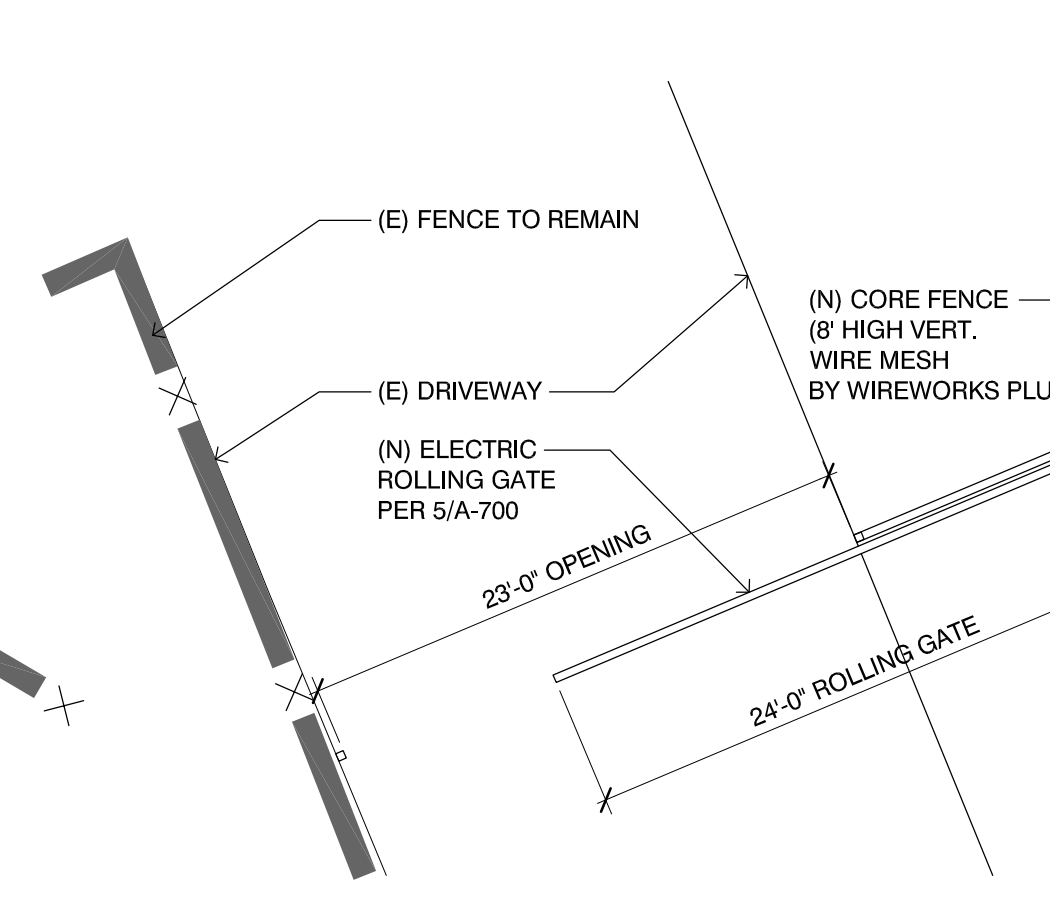

2 ACHS Gate 02 Enlarged Plan  
SCALE: 1/8" = 1'-0"

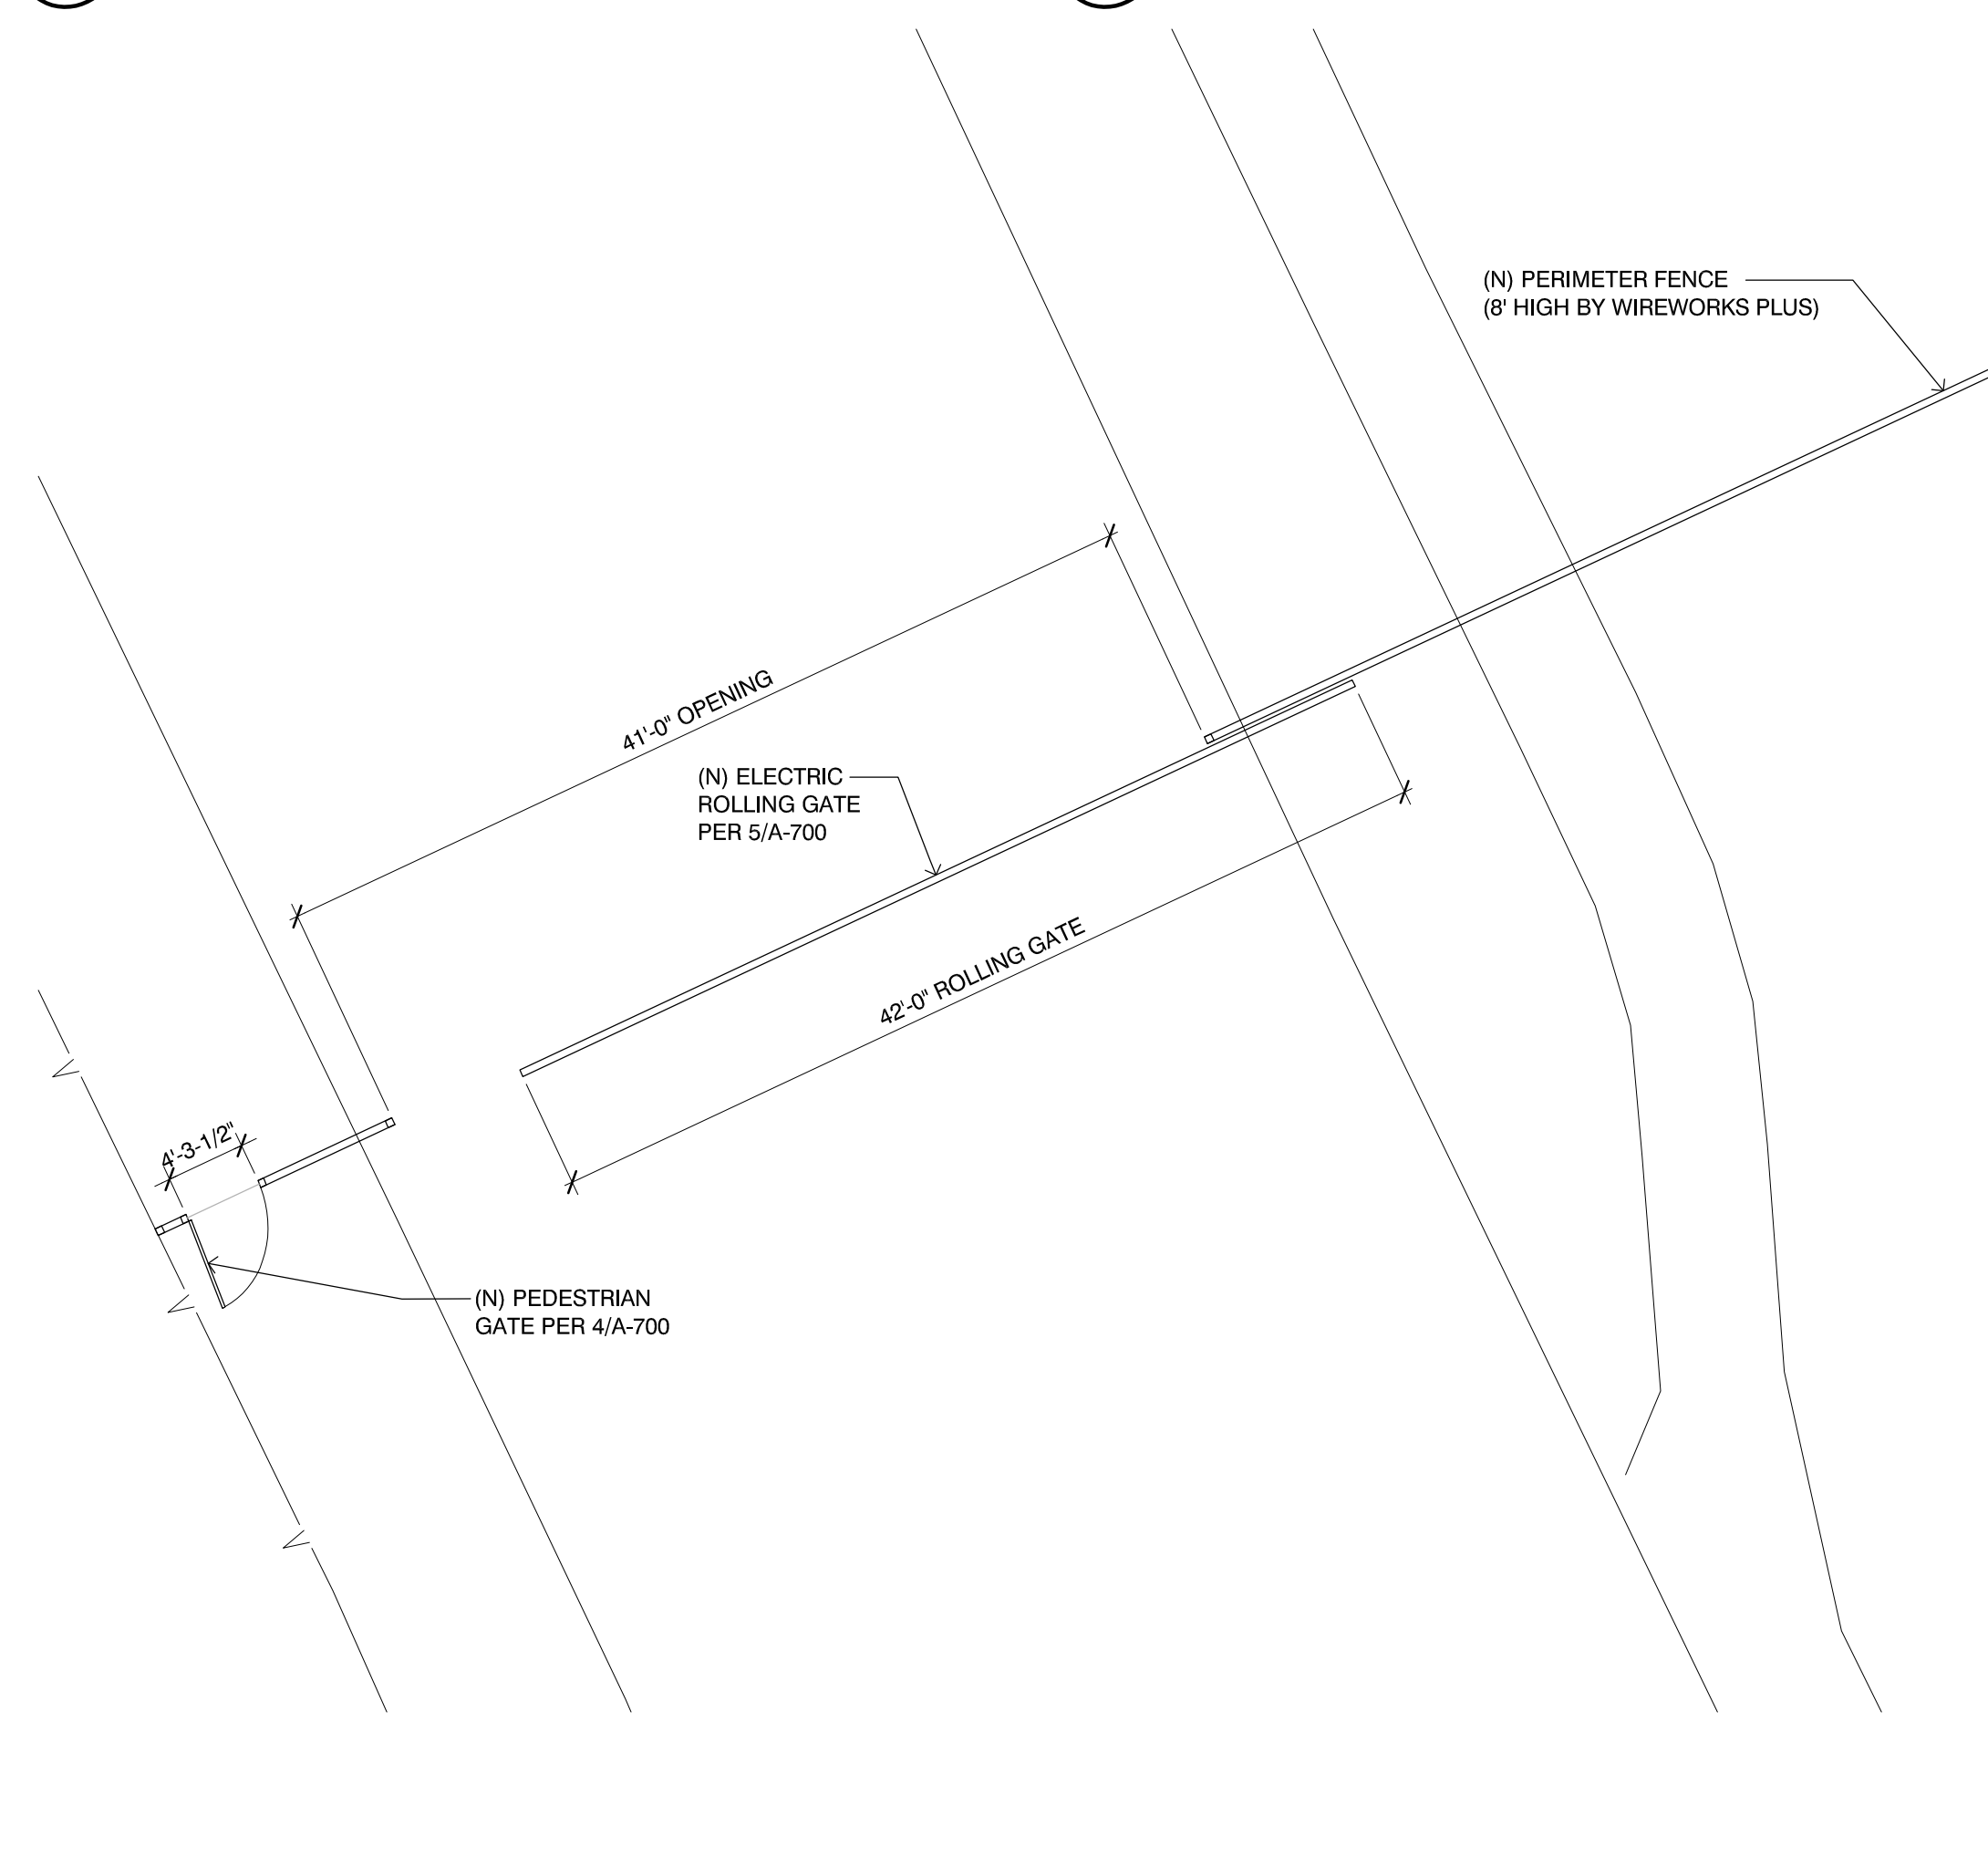

3 ACHS Gate 03 Enlarged Plan  
SCALE: 1/8" = 1'-0"




KRUGER BENSEN ZIEMER ARCHITECTS, INC. AIA  
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TELEPHONE (805) 650-1033

TODD A. JESPERSEN, AIA  
PRINCIPAL/ARCHITECT  
JONATHAN D. LEE  
ARCHITECTURAL ASSISTANT

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ARCHITECTS STAMP & SIGNATURE ENGINEERS STAMP & SIGNATURE

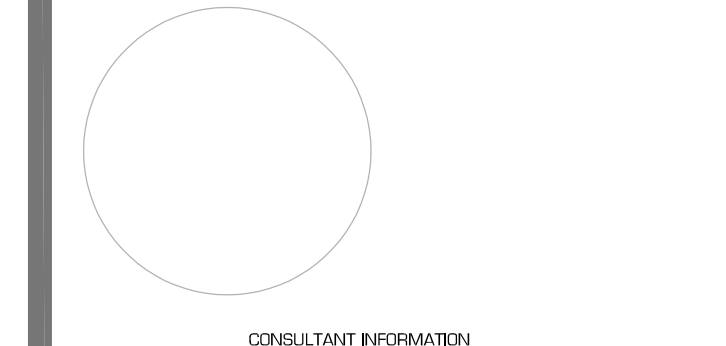

CONSULTANT INFORMATION

△	-	-/-	XX
△	-	-/-	XX
△	-	-/-	XX
△	-	-/-	XX
△	-	-/-	XX

REVISION	DESCRIPTION	DATE	BY
DRAWN	PP		
CHECKED	TJ		
DATE	3/23/2020		
JOB. NO.	19001		
DSA #03-120196	FILE: 56-H4 P/N: 72546-88		
SHEET	ENLARGED GATE PLANS		
TITLE			

